

CITY OF SPARKS BERGIN WAY STORM DRAIN CITY OF SPARKS, WASHOE COUNTY, NEVADA



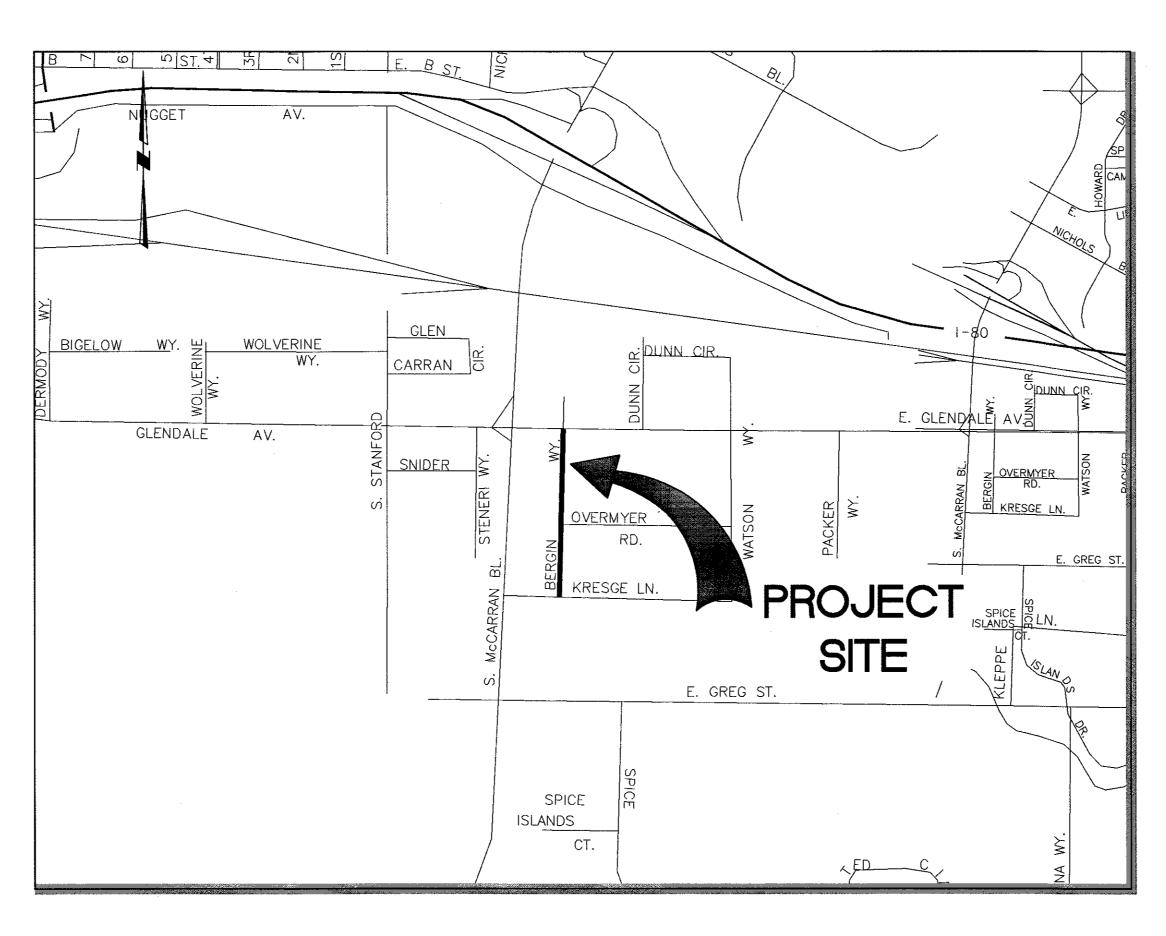
COS BID NUMBER: 17/418-007 PWP NO: WA-2017-247

SPARKS CITY COUNCIL

MAYOR	GENO MARTINI
WARD ONE	DONALD ABBOTT
WARD TWO	ED LAWSON
WARD THREE	RON SMITH
WARD FOUR	CHARLENE BYBEE
WARD FIVE	KRISTOPHER DAHIR
CITY MANAGER	STEPHEN DRISCOLL

CIVIL:

CFA, INC.
1150 CORPORATE BOULEVARD
RENO, NEVADA 89502
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CONTACT: CATIE HARRISON, P.E.



VICINITY MAP

SCALE: NTS

APPROVALS

JON R. ERICSÓN, P.E., P.TO.E. CITY ENGINEER

8/8/17

BASIS OF BEARINGS AND COORDINATES:
THE BASIS OF BEARINGS FOR THIS SURVEY IS NEVADA STATE PLANE, WEST ZONE
NAD83(94) BASED ON REAL TIME KINEMATIC (RTK) GPS OBSERVATIONS UTILIZING

THE BASIS OF BEARINGS FOR THIS SURVEY IS NEVADA STATE PLANE, WEST ZONE NAD83(94) BASED ON REAL TIME KINEMATIC (RTK) GPS OBSERVATIONS UTILIZING CORRECTIONS FROM THE NORTHERN NEVADA COOPERATIVE REAL TIME NETWORK. COORDINATES AND DISTANCES HEREON ARE AT GROUND LEVEL BASED ON A COMBINED GRID TO GROUND FACTOR OF 1.000197939.

BASIS OF ELEVATIONS:

THE BASIS OF ELEVATIONS FOR THIS SURVEY IS THE NORTH AMERICAN VERTICAL DATUM OF 1988 (NAVD88) BASED UPON GPS OBSERVATIONS UTILIZING GEOID99. SITE BENCHMARK #98 WAS USED IN THIS SURVEY WITH AN ELEVATION OF 4449.95.

PREPARED AND SUBMITTED BY:

CATIE HARRISON, P.E. PROJECT MANAGER

DATE



GENERAL NOTES

- 1. ALL CONSTRUCTION AND MATERIALS SHALL CONFORM TO THE CITY OF SPARKS STANDARDS, THE STANDARD SPECIFICATIONS FOR PUBLIC WORKS CONSTRUCTION (SSPWC) AND THE STANDARD DETAILS FOR PUBLIC WORKS CONSTRUCTION (SDPWC), LATEST EDITION, AS ADOPTED BY CITY OF SPARKS, AND SHALL BE SUBJECT TO THE APPROVAL OF THE OWNER. ALL SPECIFICATIONS REFERENCED HEREIN REFER TO THE SSPWC UNLESS INDICATED OTHERWISE.
- 2. THE CONTRACTOR SHALL PROVIDE AND MAINTAIN ALL NECESSARY TRAFFIC CONTROL, THROUGHOUT CONSTRUCTION, IN ACCORDANCE WITH APPLICABLE PARTS OF SPECIFICATION SECTION 336, AND THE MANUAL ON UNIFORM TRAFFIC CONTROL DEVICES, (MUTCD, LATEST EDITION).
- 3. THE CONTRACTOR SHALL BE RESPONSIBLE FOR THE GENERAL SAFETY DURING CONSTRUCTION, AND ALL WORK SHALL CONFORM TO PERTINENT SAFETY REGULATIONS AND CODES. THE CONTRACTOR SHALL FENCE AND OR BARRICADE THE CONSTRUCTION AREA AS REQUIRED TO PROTECT ADJACENT SITES, VEHICULAR TRAFFIC, AND PEDESTRIAN TRAFFIC. THE CONTRACTOR SHALL BE SOLELY AND COMPLETELY RESPONSIBLE FOR COMPLIANCE WITH ALL APPLICABLE PROVISIONS OF OSHA AND NRS CHAPTER 618, IN THE CONSTRUCTION PRACTICES FOR ALL EMPLOYEES DIRECTLY ENGAGED IN THE CONSTRUCTION OF THIS PROJECT.
- 4. THE CONTRACTOR SHALL BE RESPONSIBLE FOR THE LOCATION AND/OR PROTECTION OF ALL EXISTING AND PROPOSED PIPING, UTILITIES, TRAFFIC SIGNAL EQUIPMENT (BOTH ABOVE GROUND AND BELOW GROUND). STRUCTURES ADJACENT TO STREETS. AND ALL OTHER EXISTING IMPROVEMENTS THROUGHOUT CONSTRUCTION.
- 5. THE CONTRACTOR SHALL PURSUE WORK IN A CONTINUOUS AND DILIGENT MANNER TO ENSURE A TIMELY COMPLETION OF THE PROJECT.
- 6. ALL CONSTRUCTION SHALL BE CLOSELY COORDINATED WITH THE OWNER SO THAT THE QUALITY OF WORK CAN BE CHECKED FOR APPROVAL.
- 7. THE CONTRACTOR SHALL INCORPORATE ADEQUATE DRAINAGE PROCEDURES DURING THE CONSTRUCTION PROCESS TO ELIMINATE EXCESSIVE PONDING AND/OR EROSION.
- 8. THE CONTRACTOR SHALL BE RESPONSIBLE FOR MAINTAINING THE SITE IN A NEAT AND ORDERLY MANNER THROUGHOUT THE CONSTRUCTION PROCESS. ALL MATERIALS SHALL BE STORED WITHIN APPROVED CONSTRUCTION AREAS.
- 9. THE CONTRACTOR SHALL BE RESPONSIBLE FOR CONTINUOUS DUST CONTROL THROUGHOUT THE CONSTRUCTION OF ALL ITEMS SHOWN ON THESE DRAWINGS IN CONFORMITY WITH SECTION 40.030 OF WASHOE COUNTY AIR POLLUTION REGULATIONS. THE CONTRACTOR SHALL BE RESPONSIBLE FOR THE REGULAR CLEANING OF ALL MUD, DIRT, DEBRIS, ETC., FROM ANY AND ALL ADJACENT STREETS AND SIDEWALKS.
- 10. THE CONTRACTOR SHALL BE RESPONSIBLE FOR OBTAINING ALL PERMITS AS REQUIRED BY CITY OF SPARKS. THE DUST CONTROL PERMIT SHALL BE AT THE CONTRACTOR'S EXPENSE. THE ENCROACHMENT, EXCAVATION, AND LANE CLOSURE PERMITS ARE "NO FEE" PERMITS FOR CITY PROJECTS.
- 11. ALL DIMENSIONS ARE TO FRONT FACE OF CURB UNLESS NOTED OTHERWISE.
- 12. SHOULD ANY PREHISTORIC OR HISTORIC REMAINS OR ARTIFACTS BE DISCOVERED DURING SITE DEVELOPMENT, WORK SHALL BE TEMPORARILY HALTED AT THE SPECIFIC SITE AND THE STATE HISTORIC PRESERVATION OFFICE OF THE DEPARTMENT OF MUSEUMS, LIBRARY AND ARTS, SHALL BE NOTIFIED TO RECORD AND PHOTOGRAPH THE SITE. THE PERIOD OF TEMPORARY DELAY SHALL BE LIMITED TO A MAXIMUM OF TWO (2) WORKING DAYS FROM THE DATE OF NOTIFICATION.
- 13. A PRECONSTRUCTION CONFERENCE WILL BE HELD WITH CITY OF SPARKS PRIOR TO ANY CONSTRUCTION.
- 14. NO MATERIALS OF ANY KIND SHALL BE STOCKPILED OR CONSTRUCTION EQUIPMENT PARKED ON CONCRETE OR ASPHALT SURFACES.
- 15. CONSTRUCTION OF STREET IMPROVEMENTS MUST ALLOW FOR THE PERPETUATION OF ALL EXISTING LEGAL ACCESSES AND EXISTING DRIVEWAYS.
- 16. THE CONTRACTOR SHALL FURNISH PRODUCT SUBMITTALS FOR PUBLIC IMPROVEMENTS INCLUDING MANUFACTURER'S SPECIFICATIONS, SHOP DRAWINGS, CONCRETE MIX DESIGNS, ASPHALT MIX DESIGNS, GRADATION CERTIFICATIONS, ETC. FOR REVIEW BY THE ENGINEER OF RECORD. SUBMITTALS SHALL BE FURNISHED PROMPTLY AFTER EXECUTION OF THE CONTRACT, BUT IN ALL CASES PRIOR TO DELIVERY OF SUCH MATERIALS.
- 17. THE CONTRACTOR UPON COMPLETION OF THE PROJECT, SHALL PREPARE AND SUBMIT AS-BUILT DRAWINGS TO THE OWNER. SUBMITTAL SHALL BE IN THE FORM OF A CD IN 300 DPI, MULTIPAGE PDF FORMAT.
- 18. THE CONTRACTOR IS REQUIRED TO FILE A NOTICE OF INTENT (NOI) WITH THE NEVADA DEPARTMENT OF ENVIRONMENTAL PROTECTION. THE CONTRACTOR IS REQUIRED TO SUBMIT THE NOI, PAY THE ASSOCIATED FEES, AND PROVIDE A COPY OF THE NOI RECEIPT WITH THE EE PERMIT APPLICATION. BEST MANAGEMENT PRACTICES SHALL BE IN PLACE PRIOR TO START OF CONSTRUCTION. THE CONTRACTOR SHALL COMPLY AND MAINTAIN THE CONSTRUCTION SITE INSPECTION CHECKLIST, LOCATED IN APPENDIX D OF THE TRUCKEE MEADOWS BMP HANDBOOK. THE CHECKLIST SHALL BE ONSITE FOR REVIEW BY STATE AND LOCAL GOVERNMENT INSPECTORS. CONTRACTOR SHALL INSPECT THE SITE DAILY; PRIOR TO FORECASTED RAIN EVENTS AND WITHIN 24 HOURS OF ANY RAIN EVENT. IF AN INSPECTOR DETERMINES THAT INSTALLED STORM WATER CONTROLS PLACE THE CITY AT RISK OF VIOLATING ITS NPDES PERMIT, THE INSPECTOR MAY ORDER A CHANGE TO THE STORM WATER CONTROLS. IF THE CHANGE IS NOT ACCEPTABLE OR IS NOT IMMEDIATELY IMPLEMENTED, A VIOLATION POSSIBLY RESULTING IN A FINE MAY BE ISSUED. THE CONTRACTOR SHALL NOT DISPOSE OR PLACE DEBRIS IN ANY CITY OF SPARKS MANHOLE, CATCH BASIN OR FACILITY.

DEMOLITION NOTES

- 1. THE REMOVAL OF EXISTING IMPROVEMENTS SHALL BE PERFORMED IN ACCORDANCE WITH THE STANDARD SPECIFICATIONS FOR PUBLIC WORKS CONSTRUCTION (SSPWC, LATEST EDITION), SECTION 301.00.
- 2. EXISTING IMPROVEMENTS, ADJACENT PROPERTY, FENCING, WALLS, UTILITIES AND OTHER FACILITIES, TREES AND PLANTS THAT ARE NOT TO BE REMOVED SHALL BE PROTECTED FROM INJURY OR DAMAGE RESULTING FROM THE CONTRACTORS OPERATIONS IN ACCORDANCE WITH SPECIFICATION SECTION 301.04 AND 300.04.
- 3. THE CONTRACTOR SHALL ADJUST ALL EXISTING MANHOLE RIMS, WATER & GAS VALVE COVERS, & UTILITY BOXES AND FRAME AND COVERS, BOTH HORIZONTALLY AND VERTICALLY, AS REQUIRED TO FIT THE NEW WORK. THE CONTRACTOR SHALL REPLACE ANY APPURTENANCE DAMAGED DURING RELOCATION AT THE COST OF THE CONTRACTOR.
- 4. ALL EXISTING FEATURES IN CONFLICT WITH PROPOSED SHALL BE REMOVED, RELOCATED AND/OR REPLACED. CONTRACTOR SHALL OBTAIN APPROVAL FROM THE ENGINEER AND THE GOVERNING AGENCIES PRIOR TO SUCH REMOVAL, RELOCATION AND/OR REPLACEMENT.

UTILITY NOTES

- 1. UTILITIES MAY EXIST THAT ARE NOT SHOWN ON THE PLANS. HORIZONTAL AND VERTICAL LOCATIONS OF EXISTING UTILITIES ARE APPROXIMATE ONLY. CONTRACTOR SHALL VERIFY ACTUAL LOCATIONS OF EXISTING UTILITIES PRIOR TO CONSTRUCTION. CONTRACTOR SHALL CALL UNDERGROUND SERVICES ALERT, USA, AT (1-800-227-2600) PRIOR TO ANY
- 2. THE CONTRACTOR SHALL LOCATE ALL EXISTING UTILITIES WHICH MAY CONFLICT WITH THE NEW WORK PRIOR TO BEGINNING CONSTRUCTION.
- 3. THE CONTRACTOR SHALL NOTIFY NV ENERGY AT LEAST 48 HOURS PRIOR TO THE START OF UTILITY CONSTRUCTION.
- 4. THE CONTRACTOR SHALL MAKE EVERY ATTEMPT TO AVOID SHUT OFF OR DISCONNECTION OF ACTIVE UTILITIES. IF SHUT OFFS ARE UNAVOIDABLE, THE CONTRACTOR SHALL COORDINATE THAT SHUT OFF WITH THE AFFECTED CUSTOMERS AND UTILITY COMPANIES AT LEAST 48 HOURS IN ADVANCE OF THE DISRUPTION OF THE SERVICE.
- 5. CONTRACTOR TO PROVIDE ALL MISCELLANEOUS PIPE. FITTINGS AND APPURTENANCES AS REQUIRED TO COMPLETE THE UTILITY WORK AS SHOWN.
- 6. A MANHOLE PROTECTION PLAN SHALL BE SUBMITTED AND APPROVED PRIOR TO ANY MANHOLE ADJUSTMENTS. THE PLAN SHALL CLEARLY IDENTIFY HOW THE CONTRACTOR WILL PROTECT FROM ALL DEBRIS ENTERING INTO THE SYSTEM AND A DETAIL OF HOW THE CONTRACTOR IS PREPARED FOR EMERGENCY OVERFLOWS. PRIOR TO PEFORMING ANY ADJUSTMENTS OR GROUTING THE ENGINEER OF RECORD SHALL OBSERVE AND VERIFY THAT THE CONTRACTOR IS IN COMPLIANCE WITH THE "MANHOLE PROTECTION PLAN".
- 7. MANHOLES AND CATCH BASINS SHALL BE PORTLAND CEMENT CONCRETE PER SPECIFICATION SECTION 204.00. MANHOLES AND CATCH BASINS SHALL BE PLACED PER APPLICABLE PARTS OF SPECIFICATION SECTIONS 305.00, 306.00, AND 311.00.
- 8. ALL CATCH BASIN COVERS DESIGNATED TO BE RESET TO GRADE SHALL BE REPLACED WITH A NEW FRAME AND COVER AT THE CONTRACTOR'S EXPENSE.
- 9. CONTRACTOR TO VACUUM CLEAN ALL STORM DRAIN & SANITARY SEWER MANHOLES AND CATCH BASINS AFTER REMOVING CONTAINMENT DEVICES UPON COMPLETION OF THE
- 10. ALL BMPS SHALL BE REMOVED FROM CATCH BASINS & MANHOLES PRIOR TO FINAL ACCEPTANCE & RELEASE OF RETENTION.
- 11. THE CONTRACTOR SHALL POTHOLE ALL WATER MAINS AHEAD OF CONSTRUCTION AND VERIFY THAT SUFFICIENT VERTICAL CLEARANCE EXISTS TO PROVIDE SUFFICIENT PROTECTIVE COVER AND TO ACCOMMODATE THE STREET STRUCTURAL SECTION. IF WATER PIPE IS NEAR THE SUBGRADE, THE CONTRACTOR MAY NEED TO PERFORM ADDITIONAL WORK TO SHIELD WATER MAINS FROM DAMAGE. SUCH WORK MAY INCLUDE, BUT NOT BE LIMITED TO, REDUCING EXCAVATION/PULVERIZATION DEPTH OVER THE PIPE ZONE, ADDING BASE OVER THE PIPE TO INCREASE COVER PRIOR TO COMPACTION, OR REDUCING VIBRATORY COMPACTION AND CONSTRUCTION TRAFFIC OVER THE PIPE ZONE. ACTUAL FIELD CONDITIONS SHOULD BE EXAMINED AND CONSTRUCTION METHODS DISCUSSED PRIOR TO BEGINNING EXCAVATION. WATER MAINS IN BERGIN WAY ARE TRANSITE. THE CONTRACTOR SHALL TAKE EXTRA PRECAUTIONS TO PROTECT TRANSITE WATER MAINS DURING CONSTRUCTION.
- 12. STEEL PLATES THE USE OF STEEL PLATES SERVING AS A TEMPORARY TRENCH COVER SHALL ONLY BE USED WITHIN CLOSED TRAVEL LANES. THE USE OF STEEL PLATES WITHIN CLOSED TRAVEL LANES SERVING AS A TEMPORARY TRENCH COVER SHALL HAVE ASPHALT RAMPS CONSTRUCTED AROUND THE PERIMETER OF THE PLATE(S) FOR EMERGENCY VEHICLES AND CONSTRUCTION VEHICLES. WARNING SIGNS MUST BE APPROPRIATELY PLACED TO CAUTION MOTORISTS. STEEL PLATES WILL NOT BE ALLOWED IF SNOW OR FREEZING TEMPERATURES ARE EXPECTED.


CONCRETE & PAVEMENT NOTES

- 1. PORTLAND CEMENT CONCRETE SHALL MEET THE REQUIREMENTS OF SPECIFICATION SECTION 202.00. PC CONCRETE EXPOSED TO FREEZE-THAW ENVIRONMENTS SHALL HAVE A MINIMUM 28 DAY COMPRESSIVE STRENGTH OF 4,000 PSI AND MEET THE SPECIFIC REQUIREMENTS OF SPECIFICATION SECTION 337.10.01.01
- 2. ASPHALT CEMENT CONCRETE SHALL MEET THE REQUIREMENTS OF SPECIFICATION SECTION 320.00 AND THE FOLLOWING:
 - A. MARSHALL METHOD OF MIX DESIGN 50 BLOWS, 3% VOIDS. B. TYPE 2 AGGREGATE PER SPECIFICATION SECTION 200.00. C. ASPHALT CEMENT SHALL BE PG 64-28NV.
- 3. TEMPORARY PAVEMENT SHALL MEET THE REQUIREMENTS OF ASTM D4215, PLACE COLD MIX. COLD LAID BITUMINOUS PAVING MIXTURE IN ACCORDANCE WITH ASTM D4215 IMMEDIATELY FOLLOWING BACKFILLING AND COMPACTION OF TRENCHES THROUGH EXISTING PAVEMENTS. THE CONTRACTOR SHALL MAINTAIN PAVEMENT IN A SAFE AND SMOOTH CONDITION UNTIL FINAL PAVEMENT CAN BE PLACED, TO THE SATISFACTION OF THE
- 4. CURB, GUTTER AND SIDEWALK SHALL BE PLACED IN ACCORDANCE WITH SPECIFICATION SECTION 312.00.
- 5. CONCRETE PAVEMENTS SHALL BE PLACED IN ACCORDANCE WITH SPECIFICATION SECTION
- 6. ASPHALT CONCRETE PAVEMENT SHALL BE PLACED IN ACCORDANCE WITH SPECIFICATION SECTION 320.00.

UTILITY OWNERSHIP

SANITARY SEWER	- CITY OF SPARKS
STORM DRAIN	- CITY OF SPARKS
WATER	- TMWA
GAS	- NV ENERGY
ELECTRIC	- NV ENERGY
TELEPHONE	– АТ&Т
CABLE TV	- CHARTER

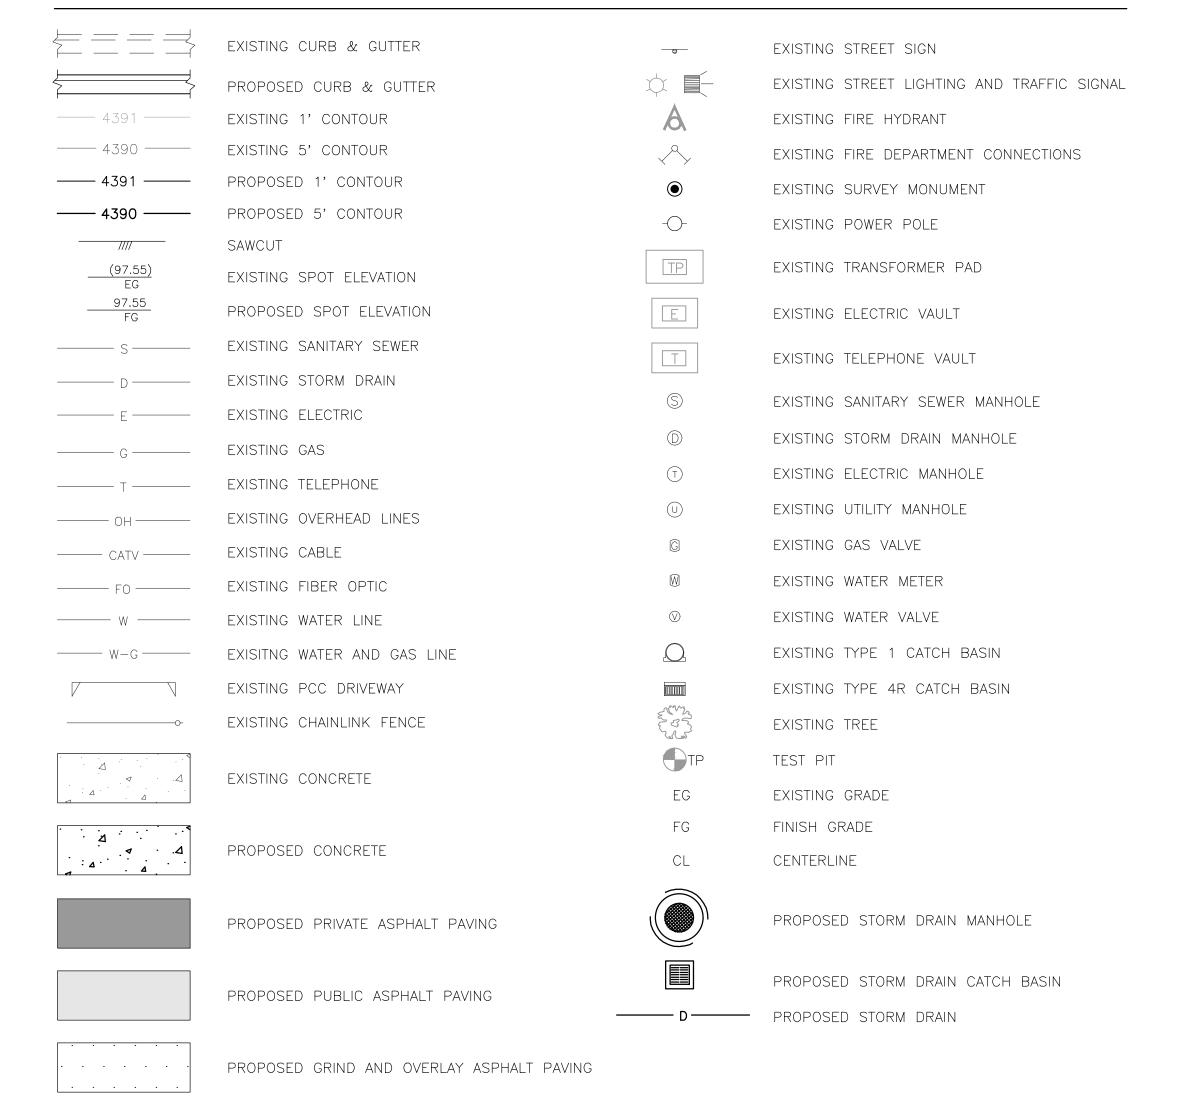LEGEND



SHEET INDEX:

C1.0	TITLE SHEET GENERAL NOTES
C2.0	SITE PLAN
C2.1	GRADING PLAN
C3.0	UTILITY PLAN INDEX
C3.1	UTILITY PLAN & PROFILE
C3.2	UTILITY PLAN & PROFILE
C3.3	UTILITY PLAN & PROFILE
C4.0	DETAILS
C4.1	DETAILS
C4.2	DETAILS
C4.3	DETAILS
C4.4	DETAILS

PROFESSIONAL SEAL CATHERINE J. \$ = 1 % Exp. 06-30-19 α CIVIL No. 19714 07-26-2017

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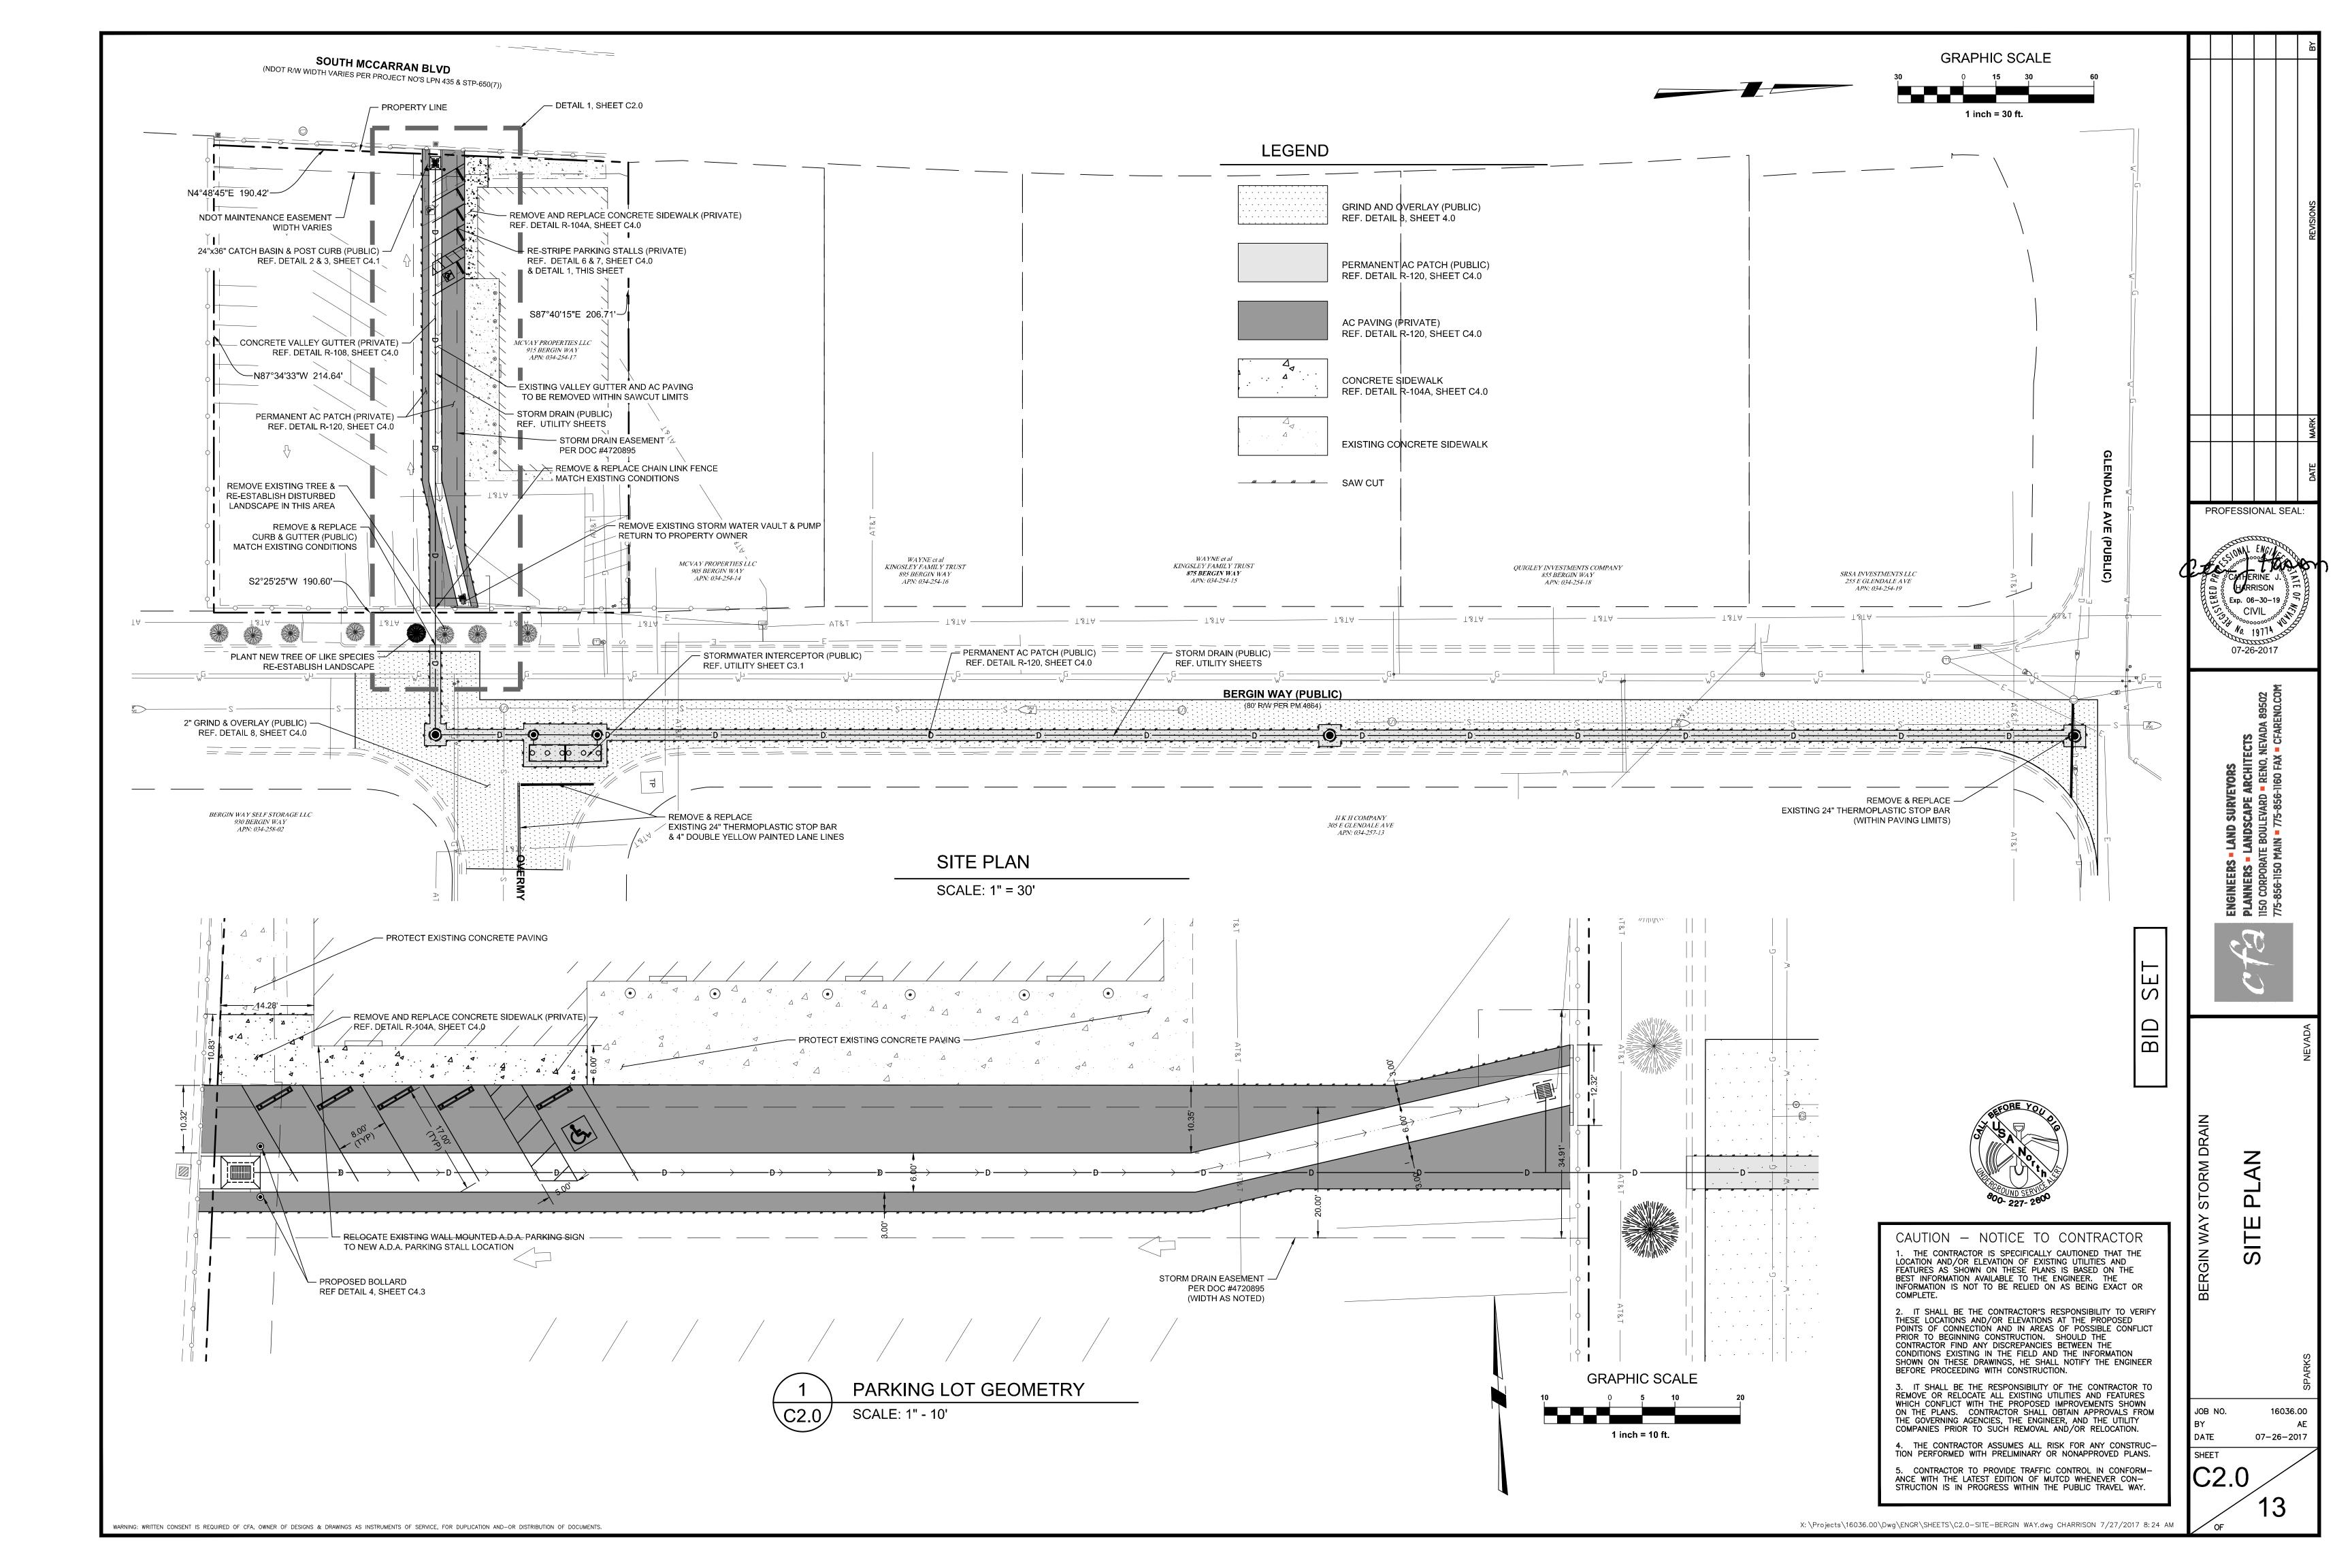
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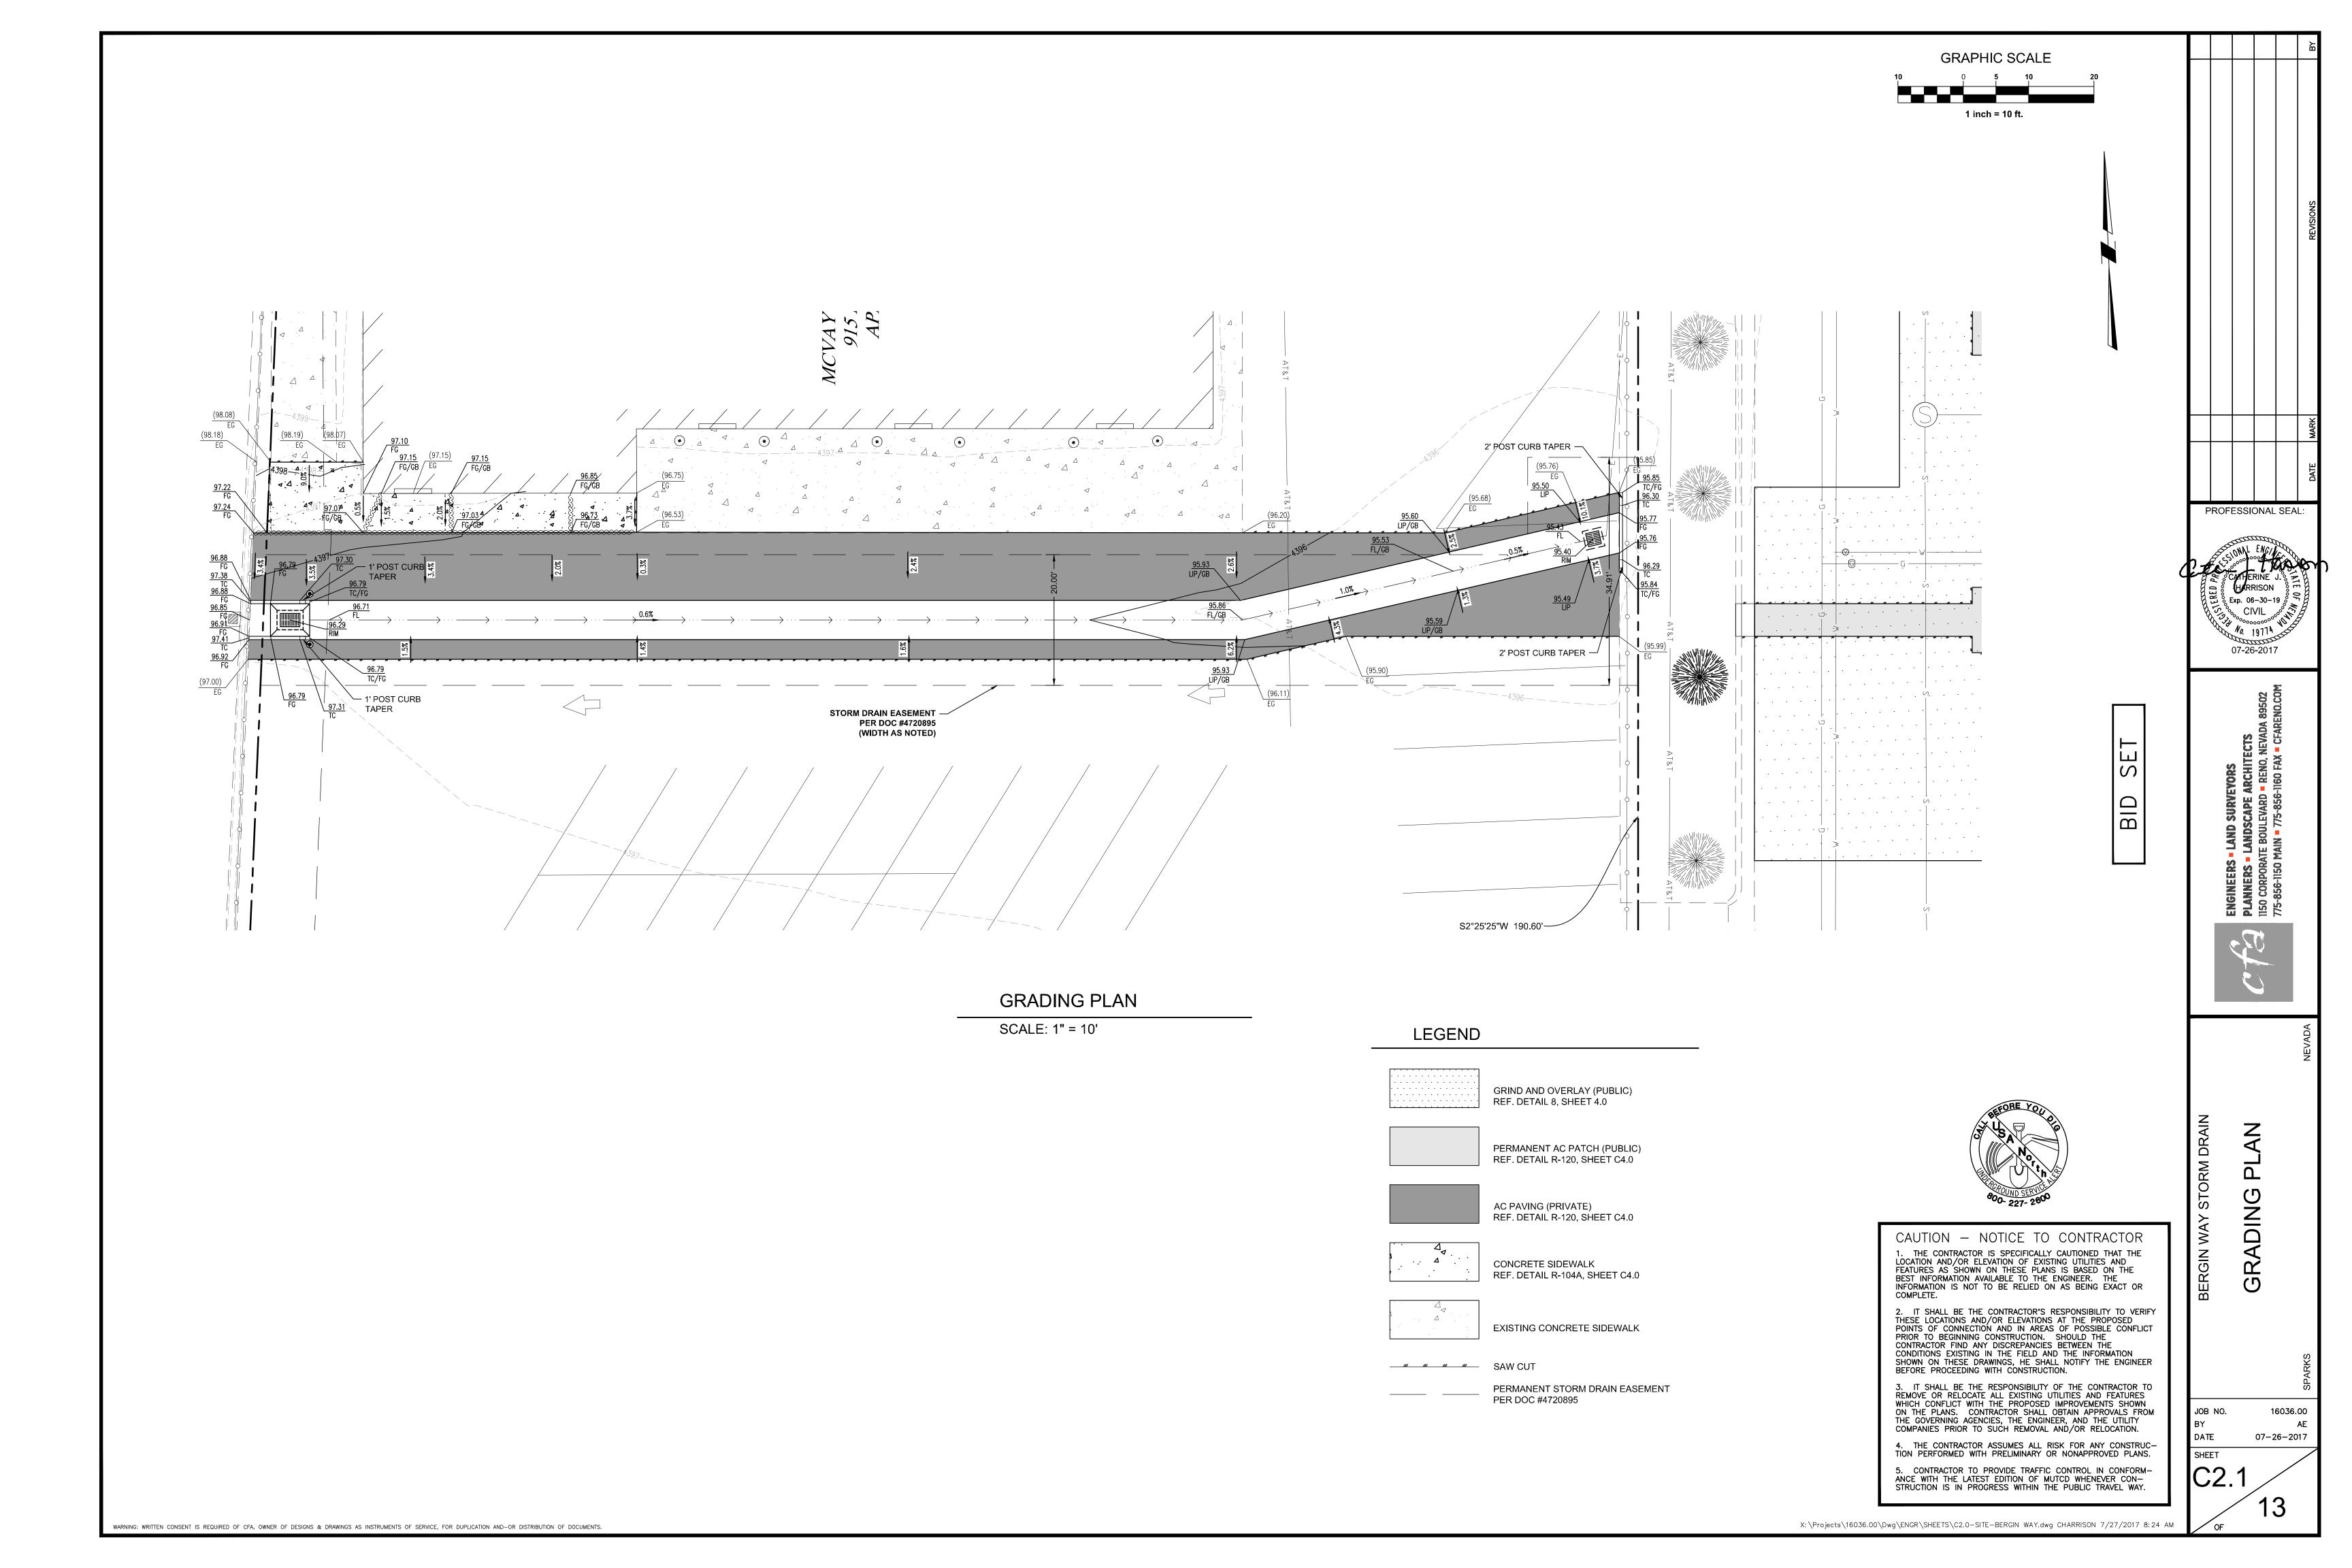
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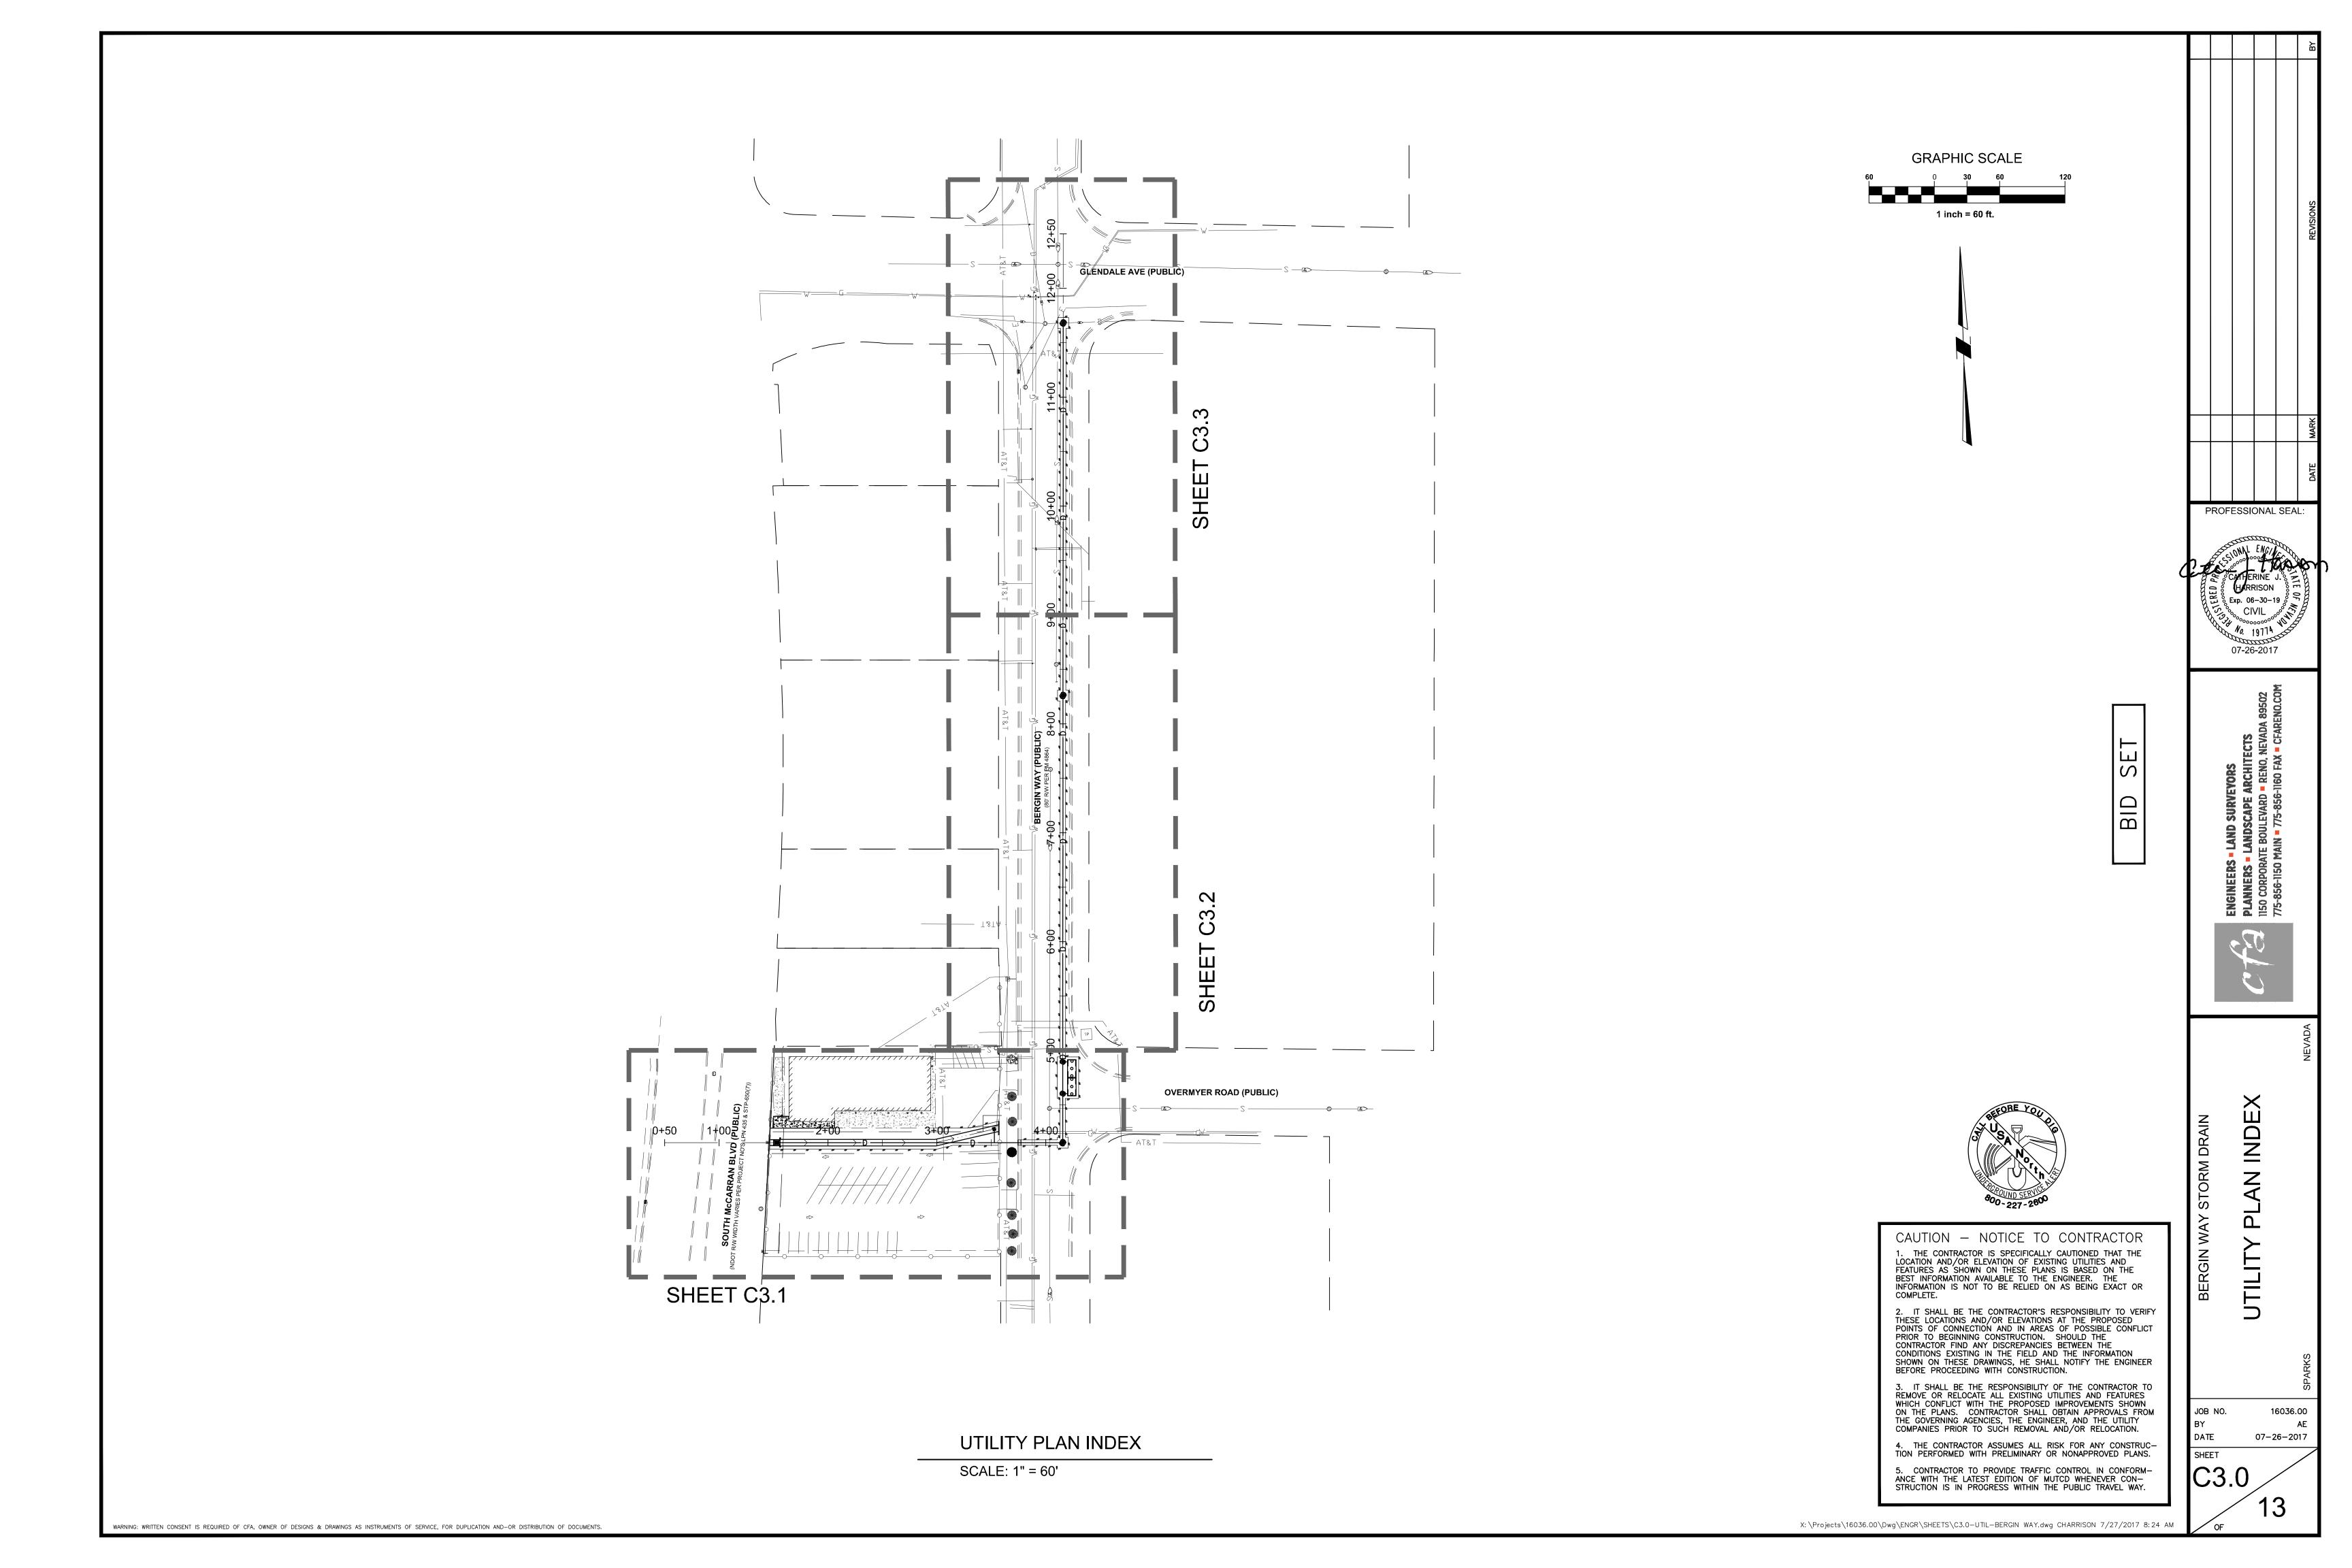
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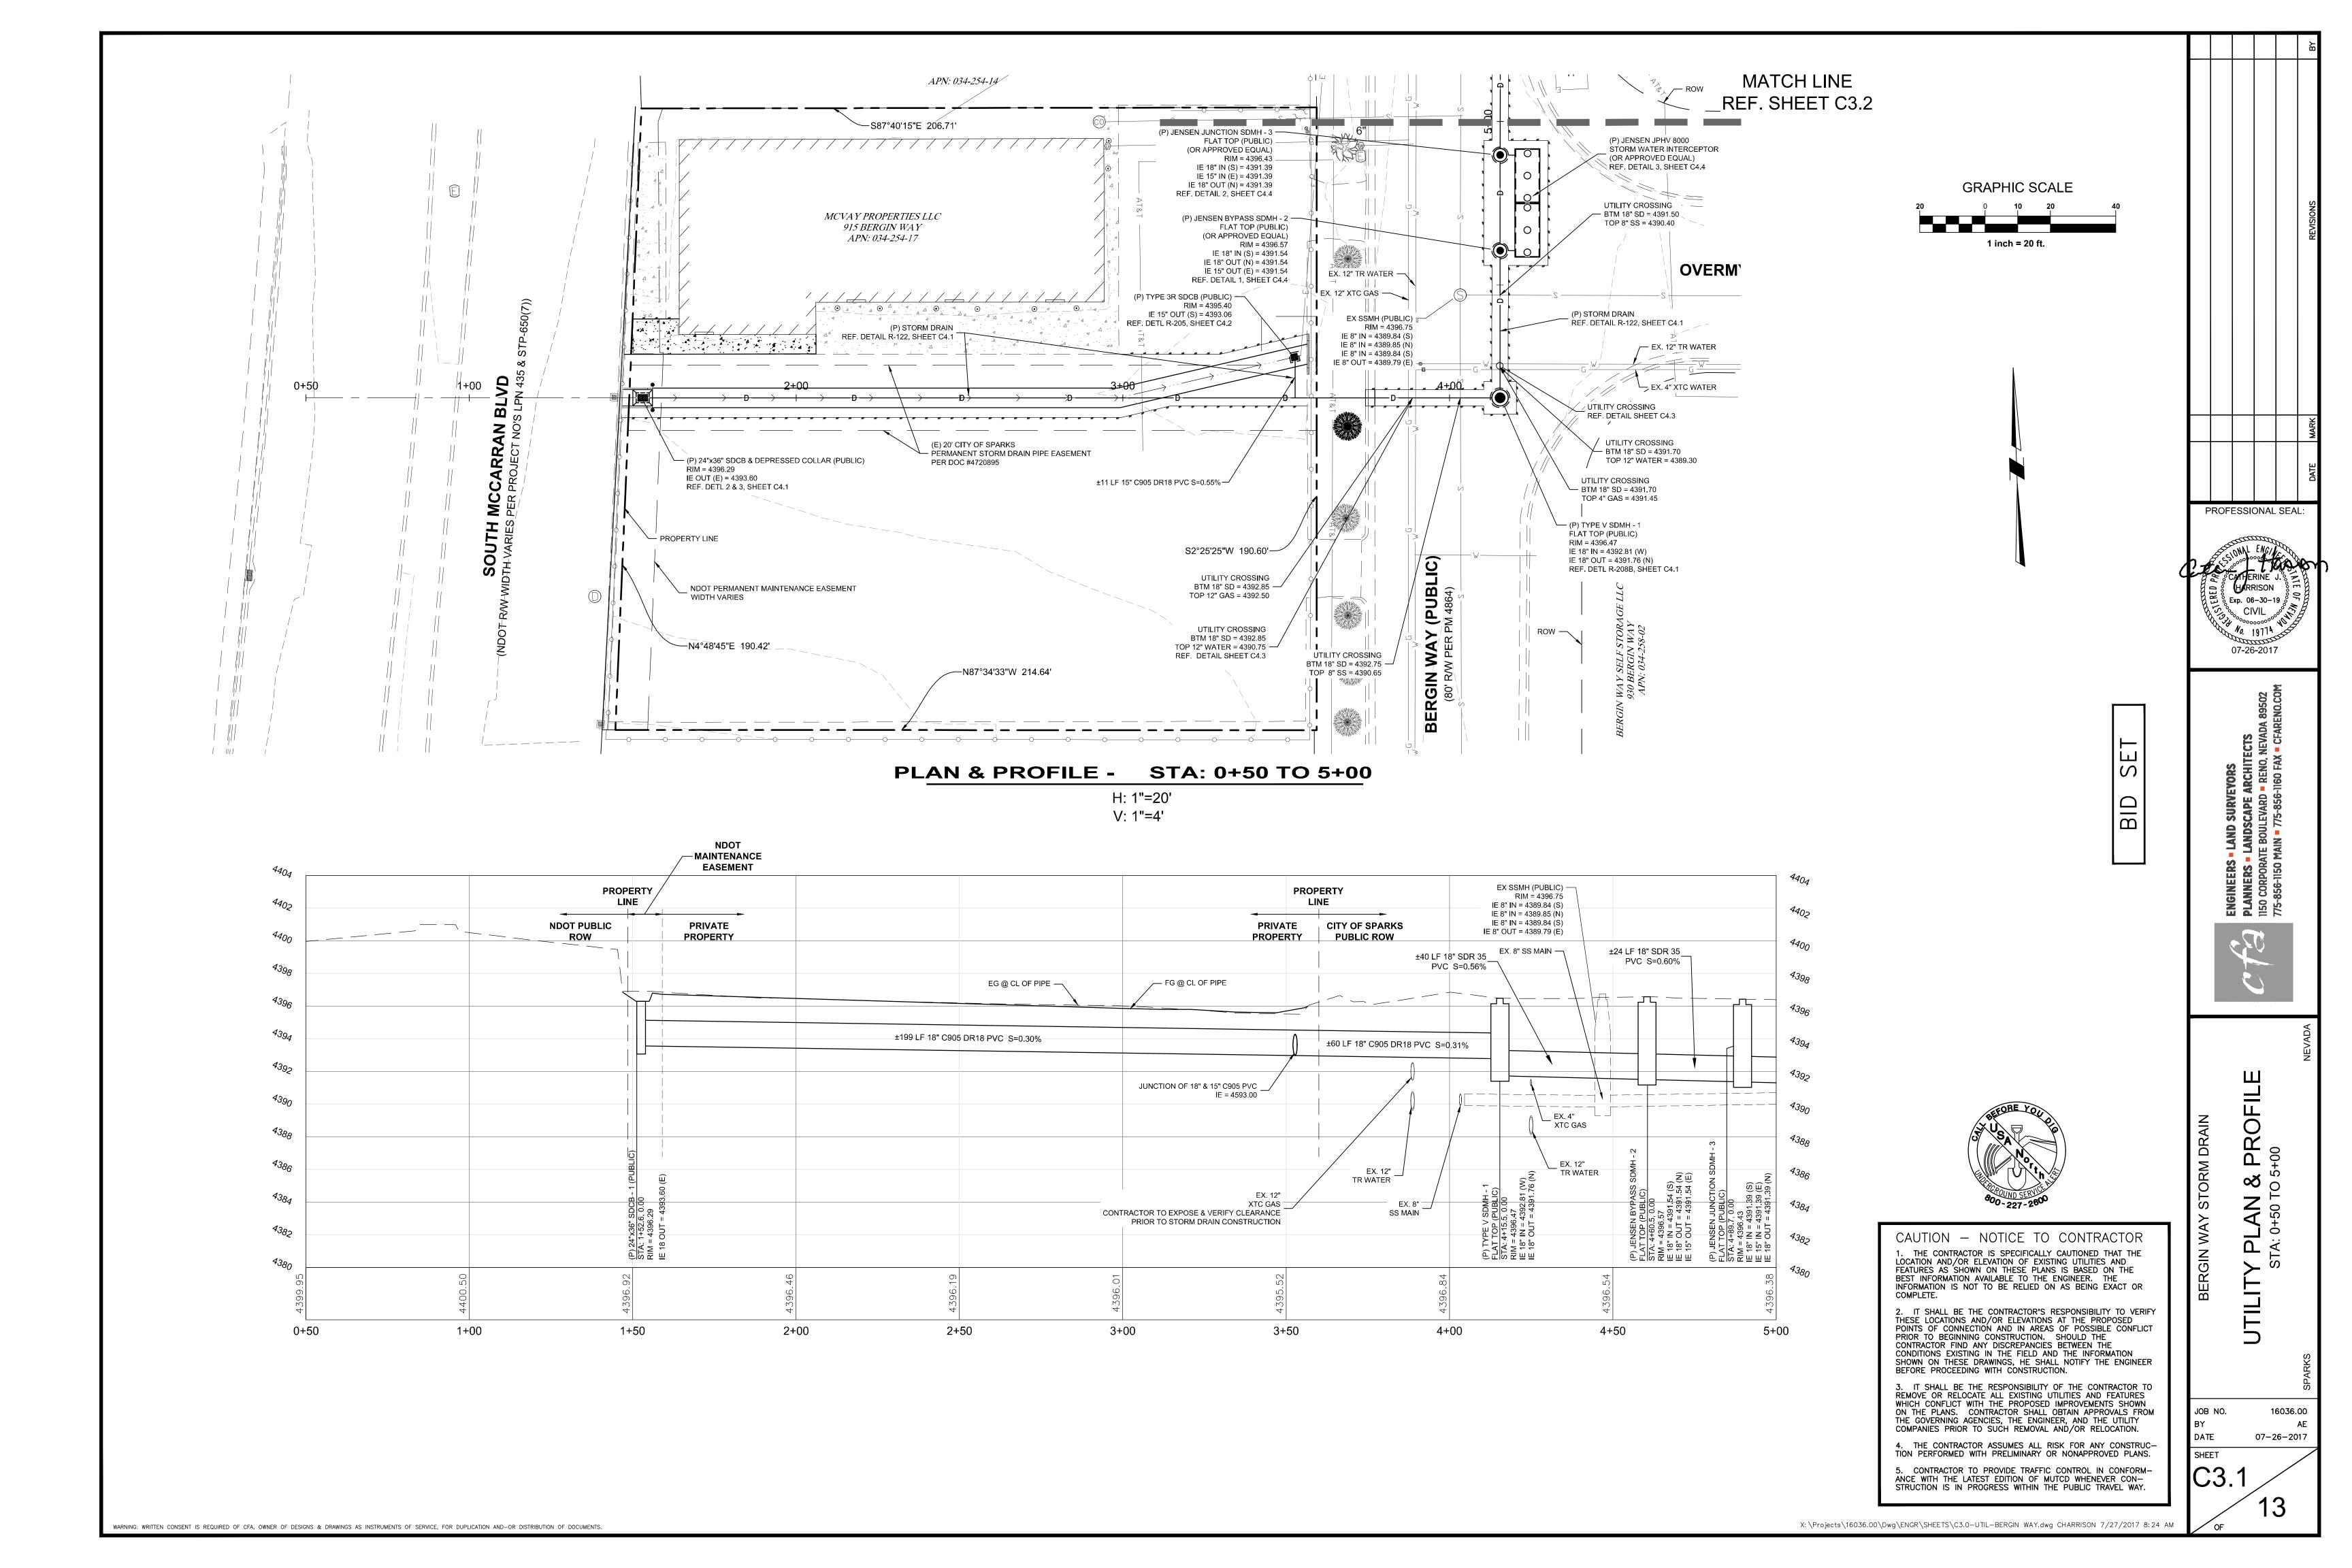
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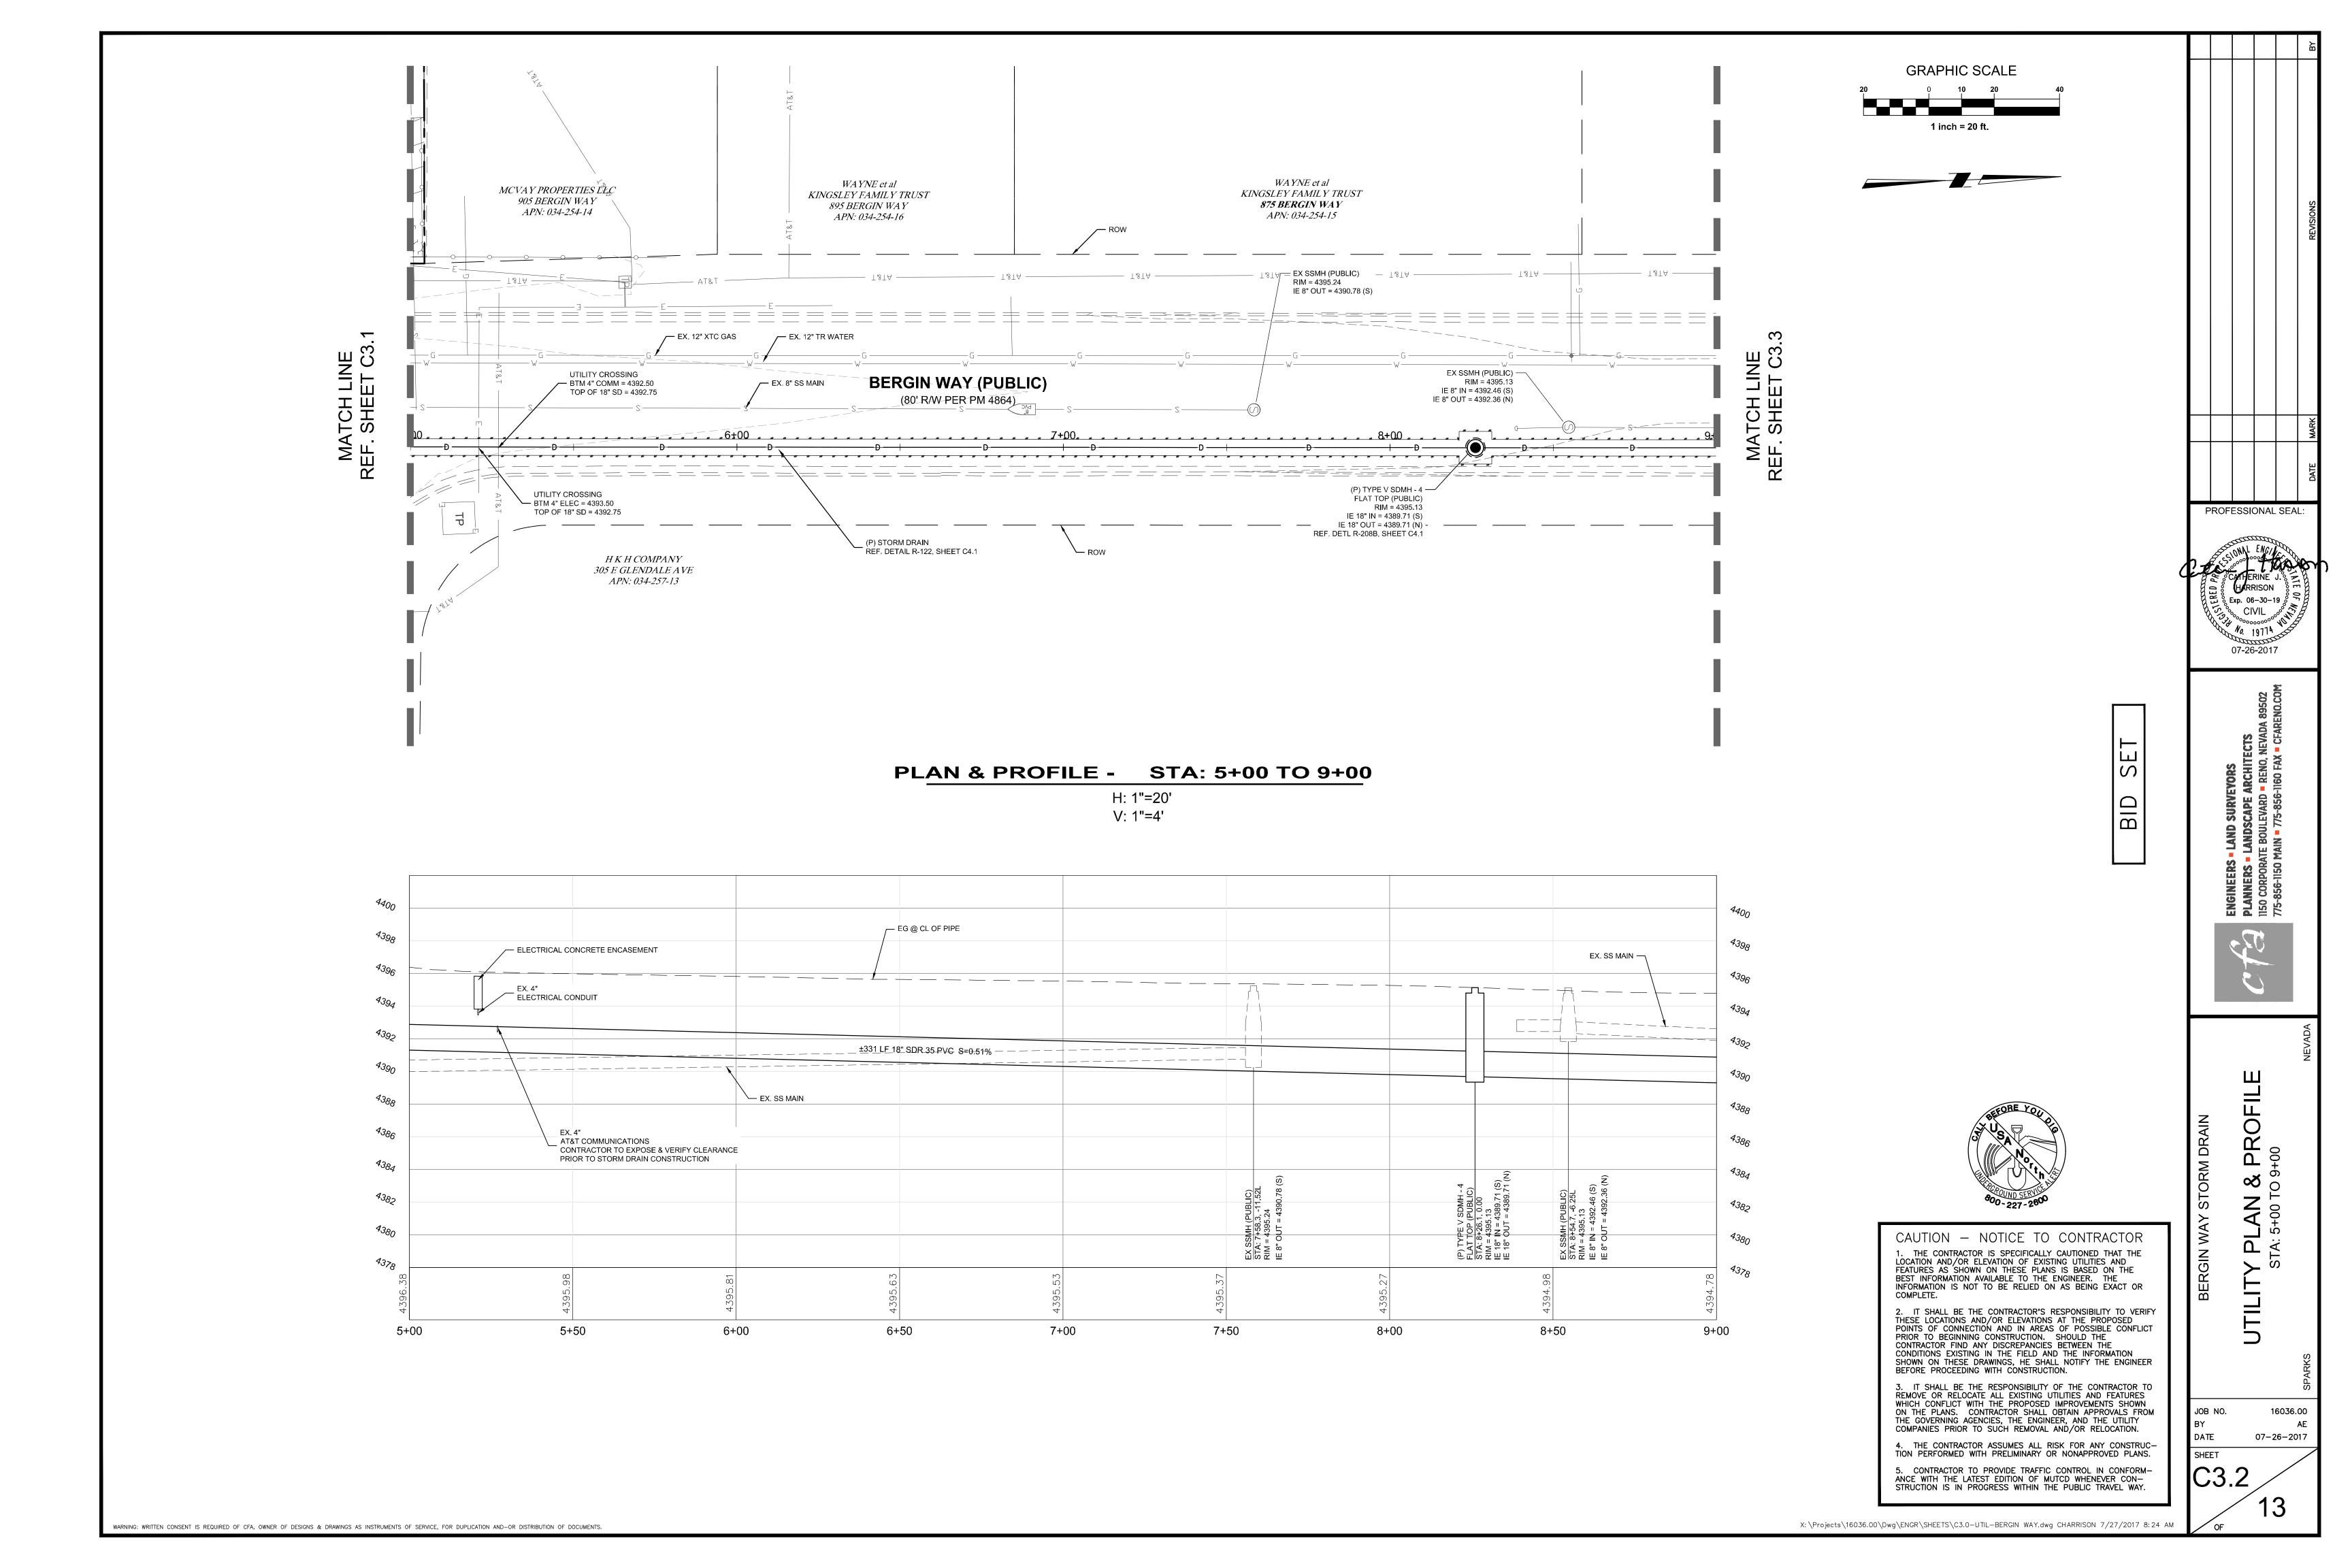
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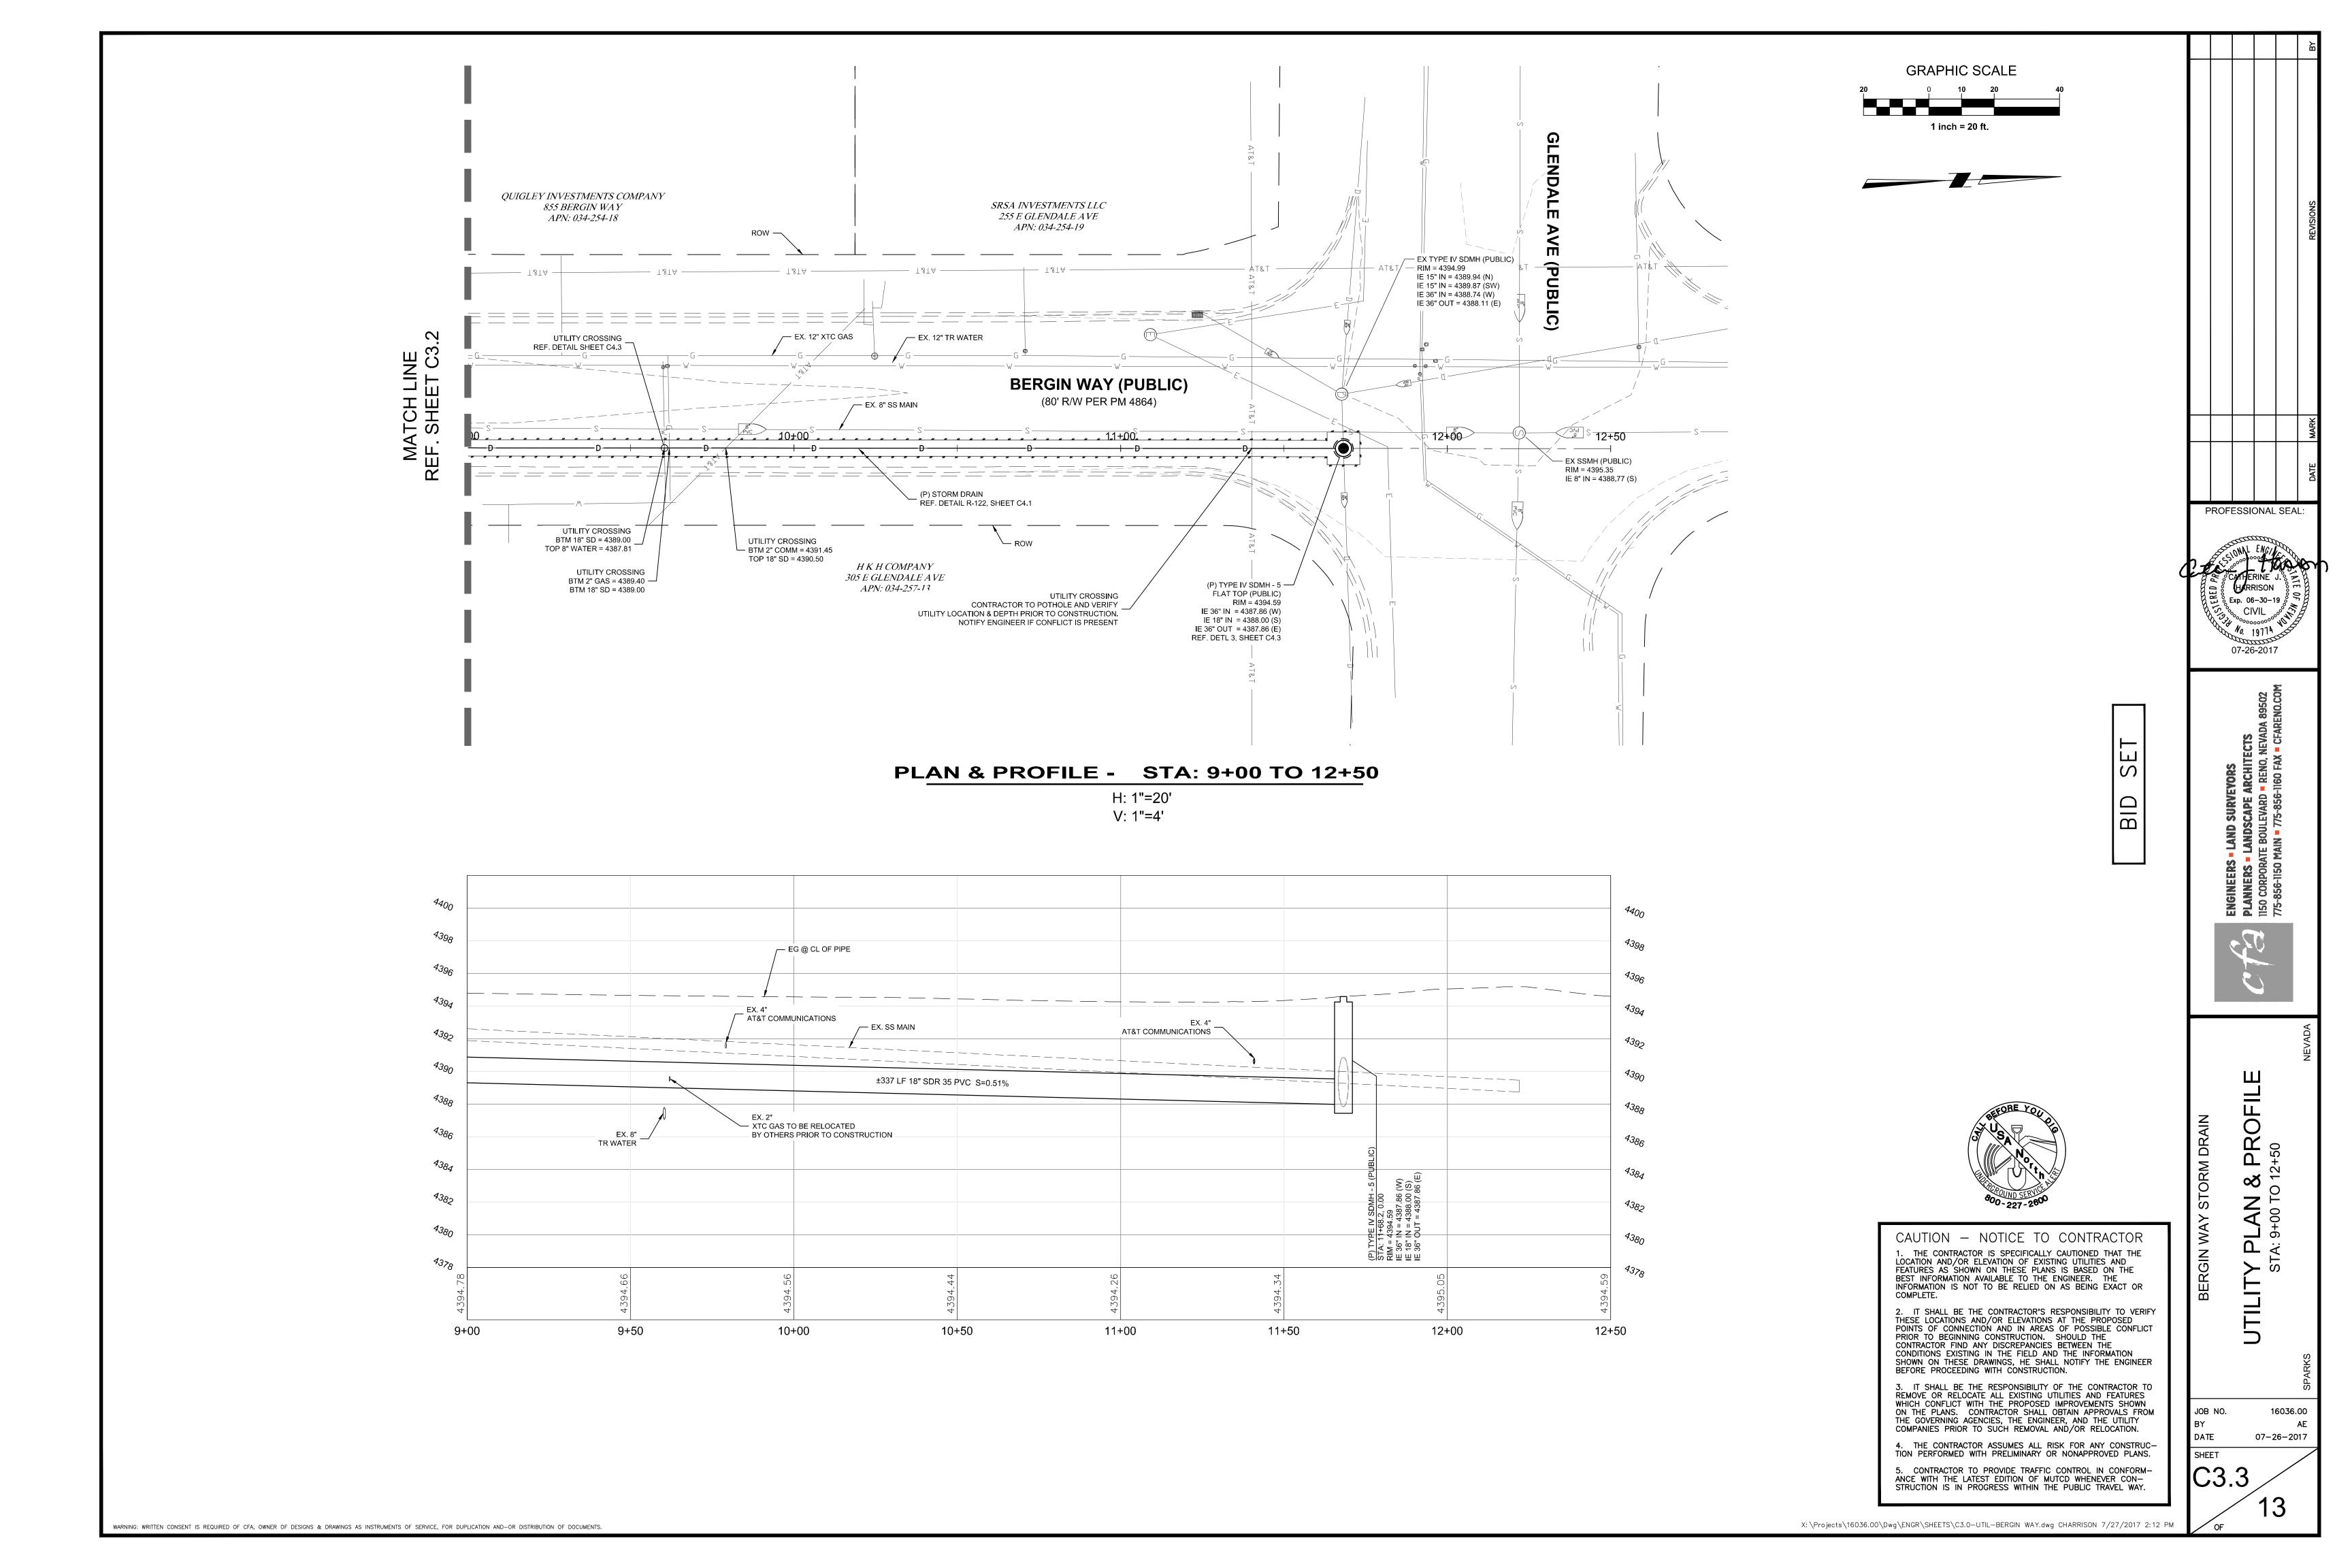













- PORTLAND CEMENT CONCRETE (P.C.C.) SHALL HAVE THE FOLLOWING CHARACTERISTICS: 4000 PSI MIN. COMPRESSIVE STRENGTH AT 28 DAYS, MIN. 6 SACKS OF CEMENT PER CUBIC YARD WITH MAX. WATER-CEMENT RATIO OF 0.45, AIR ENTRAINMENT $6\% \pm 1.5\%$, SLUMP AT 1 TO 4 INCHES. MIX DESIGN SHALL CONFORM TO THE REQUIREMENTS OF SECTION 337 OF STANDARD SPECIFICATIONS OF PUBLIC WORKS CONSTRUCTION (SSPWC). CEMENT SHALL BE TYPE II. ALL CEMENT CONCRETE SHALL HAVE A COARSE AGGREGATE GRADATION CONFORMING TO SIZE No. 67. ALL MATERIALS SHALL CONFORM TO
- AGGREGATE BASE MATERIAL UNDER SIDEWALKS SHALL BE TYPE 2, CLASS B CRUSHED AGGREGATE BASE. MATERIALS SHALL CONFORM TO SSPWC SECTION 200.
- 3. SIDEWALK WIDTH "W" AS SHOWN ON PLANS.
- I. WEAKENED PLANE JOINTS SHALL BE CONSTRUCTED AT 5 FT INTERVALS AND ACCORDANCE WITH SECTION 312 OF THE SSPWC.
- 5. ALL ADJACENT CONCRETE REMOVAL SHALL BE TO NEAT SAW CUT LINES AT RIGHT ANGLES TO NEW SIDEWALK. DOWEL INTO EXISTING ADJACENT CONCRETE SIDEWALK WITH A MINIMUM OF TWO (2) No. 4 REINFORCEMENT BARS EQUALLY SPACED ACROSS WIDTH "W". DOWELS SHALL PENETRATE A MINIMUM OF 4" INTO EXISTING CONCRETE.
- 6. SIDEWALKS SHALL NOT BE POURED MONOLITHICALLY WITH CURBS.
- 7. COLORED CONCRETE AND PAVERS ARE NOT ALLOWED.
- 8. TUNNELING AND/OR BORING IS NOT ALLOWED.

STANDARD DETAILS FOR PUBLIC WORKS CONSTRUCTION	DRAWING No.
SIDEWALK DETAIL	R-104A

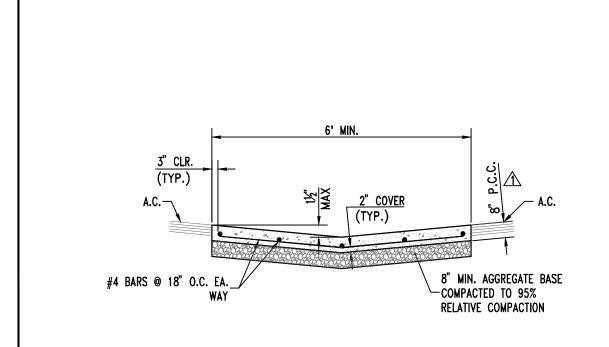1/2"R.



- PORTLAND CEMENT CONCRETE (P.C.C.) SHALL HAVE THE FOLLOWING CHARACTERISTICS: 4000 PSI MIN. COMPRESSIVE STRENGTH AT 28 DAYS, MIN. 6 SACKS OF CEMENT PER CUBIC YARD WITH MAX. WATER-CEMENT RATIO OF 0.45, AIR ENTRAINMENT 6% ± 1.5 %, SLUMP AT 1 TO 4 INCHES. MIX DESIGN SHALL CONFORM TO THE REQUIREMENTS OF SECTION 337 OF STANDARD SPECIFICATIONS OF PUBLIC WORKS CONSTRUCTION (SSPWC). CEMENT SHALL BE TYPE II. ALL CEMENT CONCRETE SHALL HAVE A COARSE AGGREGATE GRADATION CONFORMING TO SIZE No. 67. ALL MATERIALS SHALL CONFORM TO SSPWC.
- AGGREGATE BASE MATERIAL UNDER SIDEWALKS SHALL BE TYPE 2, CLASS B CRUSHED AGGREGATE BASE. MATERIALS SHALL CONFORM TO SSPWC SECTION 200.

STANDARD DETAILS FOR PUBLIC WORKS CONSTRUCTION	DRAWING No.
LONGITUDINAL	R-108
P.C.C. VALLEY GUTTER	

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4" WIDE STRIPPING;

PAINT (2) COATS

- 6' PLASTIC TIRE STOP (TYP.)

> _ 4" SOLID WHITE PAINTED STRIPE

TRAFFIC PAINT


(2 COATS)

_6" MIN. AGGREGATE BASE COMPACTED TO A MINIMUM 95% RELATIVE COMPACTION TYPE 3 CURB & GUTTER


- PORTLAND CEMENT CONCRETE (P.C.C.) SHALL HAVE THE FOLLOWING CHARACTERISTICS: 4000 PSI MIN. COMPRESSIVE STRENGTH AT 28 DAYS, MIN. 6 SACKS OF CEMENT PER CUBIC YARD WITH MAX. WATER-CEMENT RATIO OF 0.45, AIR ENTRAINMENT 6% ±1.5%, SLUMP AT 1 TO 4 INCHES. MIX DESIGN SHALL CONFORM TO THE REQUIREMENTS OF SECTION 337 OF STANDARD SPECIFICATIONS OF PUBLIC WORKS CONSTRUCTION (SSPWC). CEMENT SHALL BE TYPE II. ALL CEMENT CONCRETE SHALL HAVE A COARSE AGGREGATE GRADATION CONFORMING TO SIZE No. 67. ALL MATERIALS SHALL CONFORM TO SSPWC.
- AGGREGATE BASE MATERIAL UNDER AND BEHIND CURB AND GUTTER SHALL BE TYPE 2, CLASS B CRUSHED AGGREGATE BASE. MATERIALS SHALL CONFORM TO SSPWC SECTION 200.
- . WEAKENED PLANE JOINTS SHALL BE EVERY 10 FEET AND LOCATED ON THE BACK, TOP AND FACE OF THE CURB AND THE TOP OF THE GUTTER PAN.
- 4. CURB & GUTTER SECTIONS SHALL BE PLACED SEPARATELY FROM SIDEWALK SECTIONS. WHEN SIDEWALK IS NOT REQUIRED DIRECTLY BEHIND THE CURB, BACKFILL TO TOP OF CURB FOR A HORIZONTAL DISTANCE OF 12" FROM BACK FACE OF CURB AND COMPACT TO 90% RELATIVE COMPACTION.
- 5. FOR REPLACEMENT OF EXISTING CURB AND GUTTER, MATCH EXISTING TYPE.

STANDARD DETAILS FOR PUBLIC WORKS CONSTRUCTION	
TYPE 3 - P.C.C.	7
CURB & GUTTER	



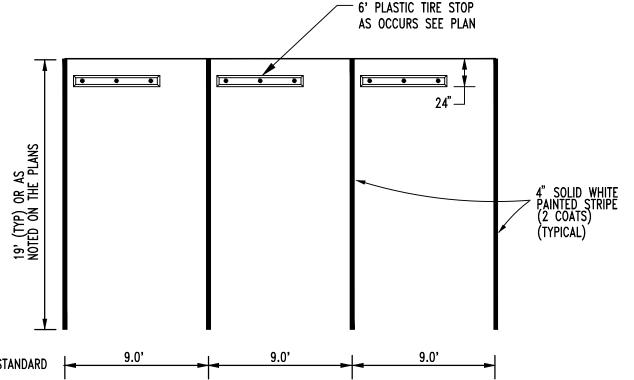

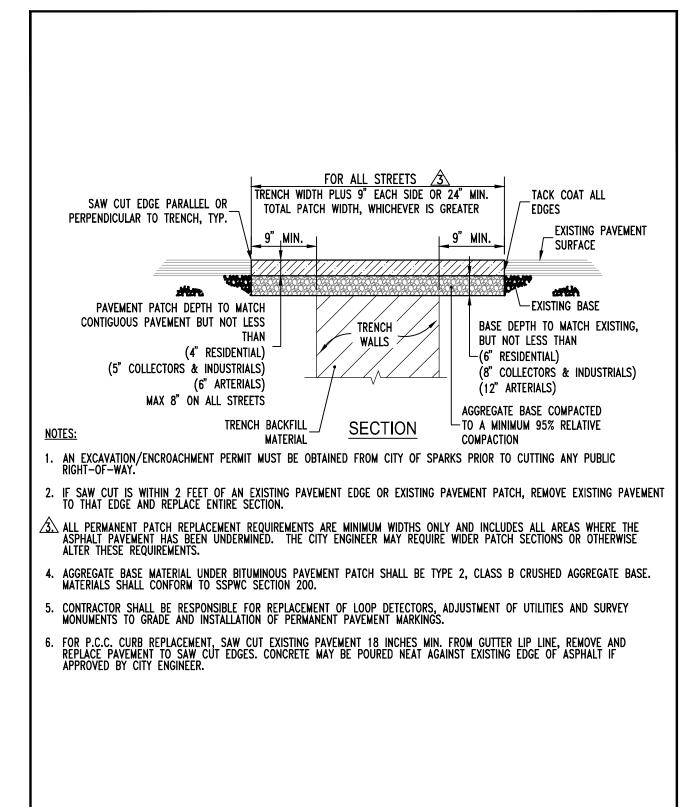NOTE: ALL PRIVATE PAVEMENT MARKING AND STRIPING SHALL MEET THE STANDARDS FOR TRAFFIC PAINT AND BE INSTALLED IN ACCORDANCE WITH SPECIFICATIONS 214.00 AND 324.00 OF THE STANDARD SPECIFICATIONS FOR PUBLIC WORKS CONSTRUCTION (LATEST EDITION).



STANDARD DETAILS FOR PUBLIC WORKS CONSTRUCTION PERMANENT BITUMINOUS R-120 **PAVEMENT PATCH**

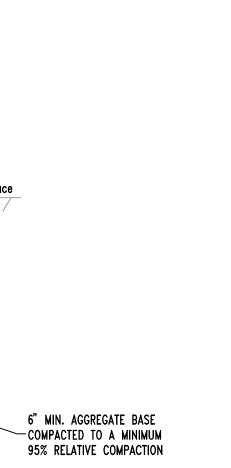
PLACE HANDICAP PARKING SIGN 1' BEHIND CURB, 1' BEHIND SIDEWALK IF SIDEWALK IS ATTACHED TO CURB, OR MOUNT ON BUILDING WALL. REF. STD. DETAIL 4" SOLID WHITE PAINTED STRIPE SPACED AT 2.0' ON CENTER

4" WIDE STRIPPING;

CENTER OF STALL

5**'**-0"

PAINT (2) COATS




1. PORTLAND CEMENT CONCRETE (P.C.C.) SHALL HAVE THE FOLLOWING CHARACTERISTICS: 4000 PSI MIN. COMPRESSIVE STRENGTH @ 28 DAYS, MIN. 6 SACKS OF CEMENT PER CUBIC YARD WITH A MAX. WATER/CEMENT RATIO OF 0.45, AIR ENTRAINMENT $6\% \pm 1.5\%$, SLUMP AT 1 TO 4 INCHES. ALL MATERIALS SHALL CONFORM TO SSPWC SECTION 202.

2. WEAKENED PLANE JOINTS SHALL BE EVERY 10 FEET AND LOCATED ON THE BACK, TOP AND EDGE OF THE CURB..

3. CURB AND GUTTER SECTIONS SHALL BE PLACED SEPARATELY FROM SIDEWALK SECTIONS.

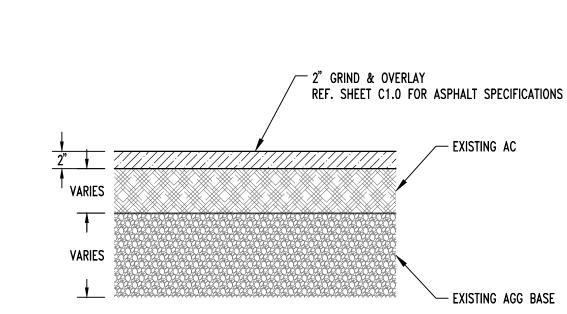- 3" WIDE PAINTED STRIPES; PAINT (2) COATS HANDICAP P.C.C. POST CURB DETAIL HANDICAP PARKING DETAIL





- EXISTING AC

EXISTING AGG BASE

CAUTION - NOTICE TO CONTRACTOR 1. THE CONTRACTOR IS SPECIFICALLY CAUTIONED THAT THE LOCATION AND/OR ELEVATION OF EXISTING UTILITIES AND FEATURES AS SHOWN ON THESE PLANS IS BASED ON THE BEST INFORMATION AVAILABLE TO THE ENGINEER. THE INFORMATION IS NOT TO BE RELIED ON AS BEING EXACT OR

2. IT SHALL BE THE CONTRACTOR'S RESPONSIBILITY TO VERIFY THESE LOCATIONS AND/OR ELEVATIONS AT THE PROPOSED POINTS OF CONNECTION AND IN AREAS OF POSSIBLE CONFLICT PRIOR TO BEGINNING CONSTRUCTION. SHOULD THE CONTRACTOR FIND ANY DISCREPANCIES BETWEEN THE CONDITIONS EXISTING IN THE FIELD AND THE INFORMATION SHOWN ON THESE DRAWINGS, HE SHALL NOTIFY THE ENGINEER BEFORE PROCEEDING WITH CONSTRUCTION.

3. IT SHALL BE THE RESPONSIBILITY OF THE CONTRACTOR TO REMOVE OR RELOCATE ALL EXISTING UTILITIES AND FEATURES WHICH CONFLICT WITH THE PROPOSED IMPROVEMENTS SHOWN ON THE PLANS. CONTRACTOR SHALL OBTAIN APPROVALS FROM THE GOVERNING AGENCIES, THE ENGINEER, AND THE UTILITY COMPANIES PRIOR TO SUCH REMOVAL AND/OR RELOCATION.

4. THE CONTRACTOR ASSUMES ALL RISK FOR ANY CONSTRUC-TION PERFORMED WITH PRELIMINARY OR NONAPPROVED PLANS. . CONTRACTOR TO PROVIDE TRAFFIC CONTROL IN CONFORM-ANCE WITH THE LATEST EDITION OF MUTCD WHENEVER CON—STRUCTION IS IN PROGRESS WITHIN THE PUBLIC TRAVEL WAY.

N.T.S.

STANDARD PARKING DETAIL

GRIND & OVERLAY

SHEET

WARNING: WRITTEN CONSENT IS REQUIRED OF CFA, OWNER OF DESIGNS & DRAWINGS AS INSTRUMENTS OF SERVICE, FOR DUPLICATION AND-OR DISTRIBUTION OF DOCUMENTS.

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- ALL MATERIALS AND INSTALLATION PROCEDURES SHALL BE IN ACCORDANCE WITH STANDARD SPECIFICATIONS FOR PUBLIC WORKS CONSTRUCTION (SSPWC), LATEST REVISION.
- <u>2.</u> BEDDING MATERIAL SHALL CONFORM TO OWNING-UTILITY COMPANY REQUIREMENTS AS APPROVED BY THE CITY OF SPARKS. FOR CITY-OWNED UTILITIES, BEDDING MATERIAL SHALL BE CLASS A OR C, COMPACTED TO MINIMUM 90% COMPACTION. MATERIALS SHALL CONFORM TO SSPWC SECTION 200.
- /3.\ CLASS C BEDDING REQUIRES INSTALLATION OF GEOTEXTILE FABRIC BETWEEN PIPE ZONE AND BACKFILL MATERIAL. GEOTEXTILE FABRIC SHALL BE MIRAFI 180N OR APPROVED EQUAL.
- BACKFILL MATERIAL SHALL BE TYPE 2, CLASS B OR CLASS E AND COMPACTED TO MINIMUM 90% COMPACTION. MATERIALS SHALL CONFORM TO SSPWC SECTION 200.
- <u>5.</u> ALL EXCAVATIONS SHALL CONFORM TO THE LATEST O.S.H.A. REQUIREMENTS
- EXISTING PIPE TO BE ABANDONED SHALL BE GROUT FILLED OR COMPLETELY REMOVED.
- 7. MINIMUM BACKFILL DEPTH REQUIREMENT IS FOR TRENCHING IN EXISTING PAVED STREETS. TRENCHING FOR NEW DEVELOPMENT WHERE STREETS HAVE NOT YET BEEN CONSTRUCTED, BACKFILL MATERIAL SHALL BE TYPE 2, CLASS B OR CLASS E AND COMPACTED TO MINIMUM 90% COMPACTION. MATERIALS SHALL CONFORM TO SSPWC SECTION 200.


STANDARD DETAILS FOR PUBLIC WORKS CONSTRUCTION	DRAWING No.
TRENCH	R-122
EXCAVATION/BACKFILL	


- ALL PRECAST MANHOLE COMPONENTS SHALL CONFORM TO ASTM C-478.
- 2. PIPES SHALL NOT PROTRUDE MORE THAN 3" INSIDE MANHOLE SECTION AS MEASURED AT THE OUTSIDE EDGES OF THE PIPE, VERTICALLY ALIGNED WITH THE SPRINGLINE. PIPE CONNECTION TO MANHOLE SHALL BE WATERTIGHT PER STANDARD DETAILS R-223A, R-223B AND R-223C.
- MANHOLE BASE SHALL BE PORTLAND CEMENT CONCRETE (P.C.C.) AND SHALL HAVE THE FOLLOWING CHARACTERISTICS: 3000 PSI MINIMUM COMPRESSIVE STRENGTH AT 28 DAYS, MINIMUM 6 SACKS OF CEMENT PER CUBIC YARD WITH SLUMP AT 1 TO 4 INCHES. ALL MATERIAL SHALL CONFORM TO STANDARD SPECIFICATIONS OF PUBLIC WORKS CONSTRUCTION (SSPWC). PRECAST CONCRETE BASE MAY BE USED IN LIEU OF CAST-IN-PLACE BASE.
- 4. TYPE I MANHOLE TO BE UTILIZED FOR PIPE DIAMETERS OF 12" OR SMALLER AND DEPTHS NOT EXCEEDING 18 FEET.
- 5. TYPE V MANHOLE TO BE UTILIZED FOR PIPE DIAMETERS OF 15" THROUGH 27" OR DEPTHS EXCEEDING 18 FEET.
- 6. MANHOLE MATERIALS AND CONSTRUCTION SHALL CONFORM TO THE REQUIREMENTS OF SECTION 204 "MANHOLES AND CATCH BASINS" OF THE STANDARD SPECIFICATIONS.
- PRECAST MANHOLE SECTIONS, OTHER THAN GRADE RINGS, SHALL BE JOINED WITH FLEXIBLE GASKET MATERIAL SUCH AS "RAM-NEK" OR EQUAL AS PER MANUFACTURER'S RECOMMENDATIONS.
- STANDARD SPECIFICATIONS. 9. EXCAVATION SHALL BE AS NEARLY VERTICAL AS POSSIBLE (SHEET AND SHORE IF SOIL CONDITIONS REQUIRE) IN EXISTING

8. EXCAVATION AND BACKFILL SHALL BE AS SPECIFIED FOR "TRENCH EXCAVATION AND BACKFILL" IN SECTION 305 OF THE


- STREET SECTIONS, ALLEY SECTIONS, AND CONFINED AREAS, SUCH AS LIMITED EASEMENTS OR ADJACENT STRUCTURES. 10. MANHOLE PRECAST SECTION LENGTH SHALL BE ARRANGED TO FIT THE REQUIRED DEPTH.
- 11. NO LATERALS OR PIPES LESS THAN 8" IN DIAMETER SHALL BE CONNECTED TO THE MANHOLE.
- 12. PRECAST CONCRETE BASE MAY BE USED IN LIEU OF CAST-IN-PLACE BASE. /13. MATCH PIPE INVERTS TO MANHOLE INVERTS WHERE PIPES CONNECT TO MANHOLE BASE.
- 14. ALL MANHOLES SHALL BE WATERTIGHT.
- 15. SEE DETAIL FOR OUTSIDE DROP MANHOLE FOR SANITARY SEWERS WITH MORE THAN 2 FEET VERTICAL DROP AT THE MANHOLE. THE USE OF "INSIDE DROP" MANHOLES IS NOT PERMITTED.
- 16. THE USE OF FLAT TOP MANHOLE CONES REQUIRES PRIOR APPROVAL FROM THE CITY ENGINEER.
- 17. PRIOR TO BACKFILLING, ALL MANHOLES SHALL BE VACUUM TESTED PER ASTM C-1244.
- 18. NO STEPS, LADDERS, OR OTHER CLIMBING DEVICES SHALL BE INSTALLED IN THE MANHOLE.
- 19. REINFORCING STEEL SHALL BE AS SHOWN, WIRED TIGHTLY AT ALL INTERSECTIONS AND EMBEDDED AT LEAST 1½" CLEAR, UNLESS OTHERWISE NOTED.
- 20. WHEN PIPE CONNECTIONS TO EXISTING MANHOLES ARE ALLOWED, THEY SHALL BE MADE BY CORE DRILLING THE MANHOLE AND CONNECTING THE PIPE PENETRATION PER DETAIL R-223A & R-223B.


STANDARD DETAILS FOR PUBLIC WORKS CONSTR	RUCTION DRAWING No.
NOTES - MANHOLE	
TYPE I & TYPE V	11-2000

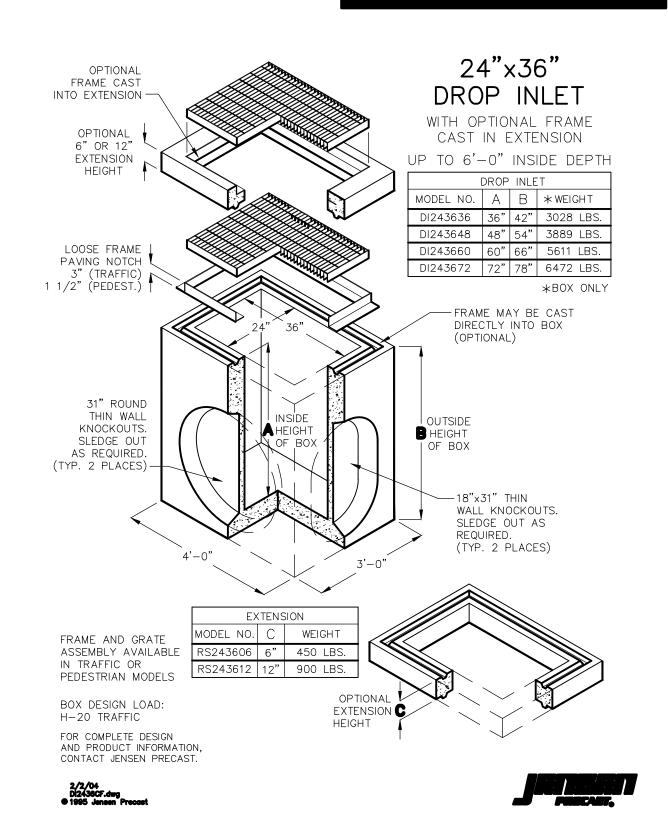


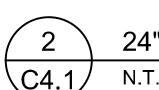

24" x 36" CATCH BASIN

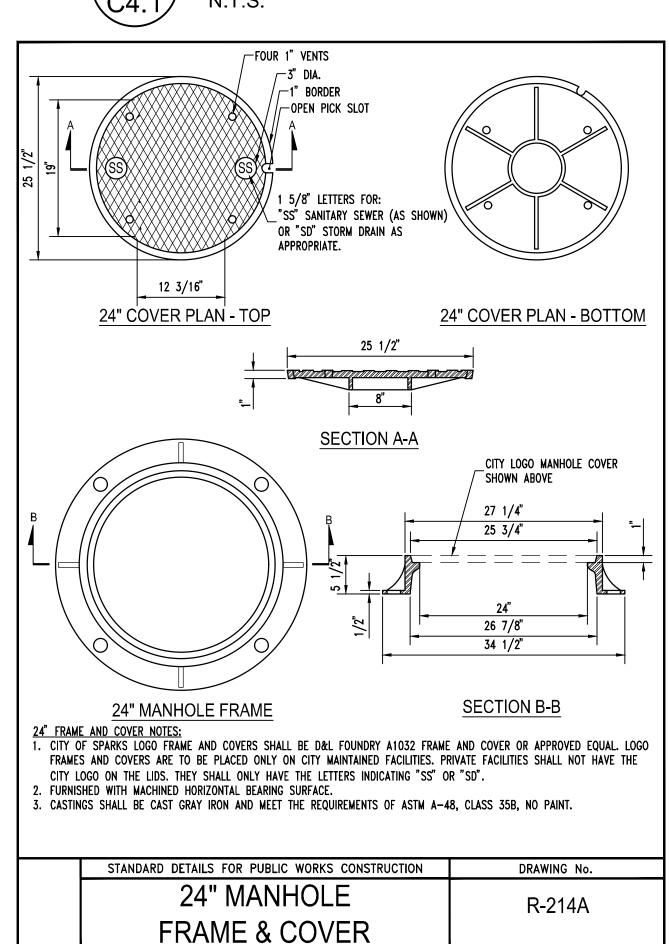

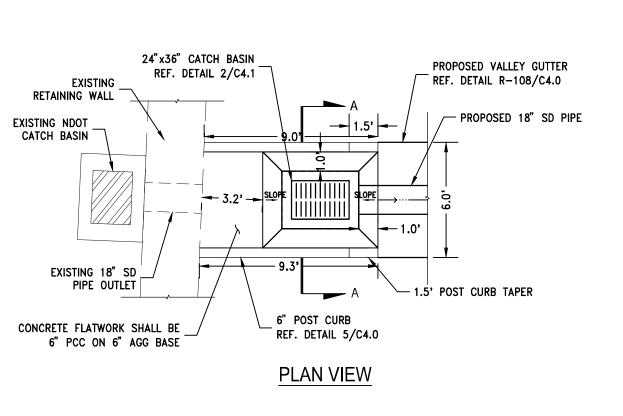

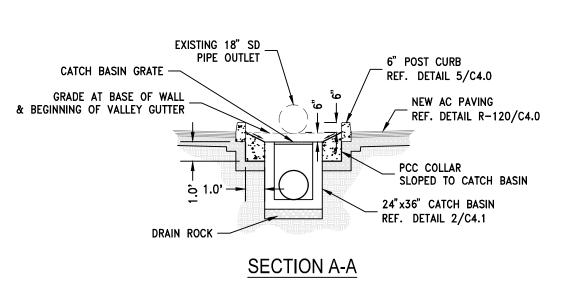

CATCH BASIN DEPRESSED COLLAR

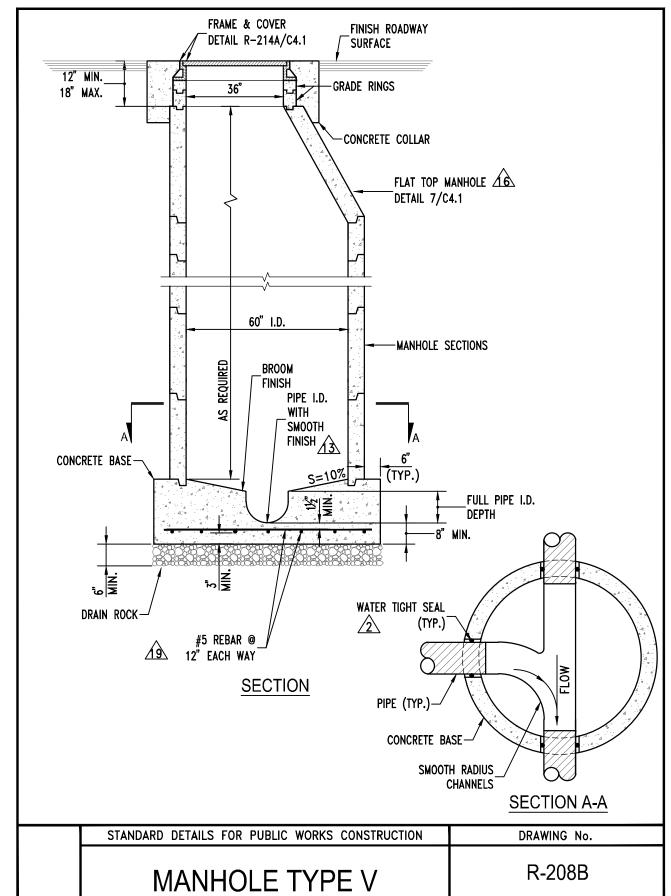
— 72" О.D. —

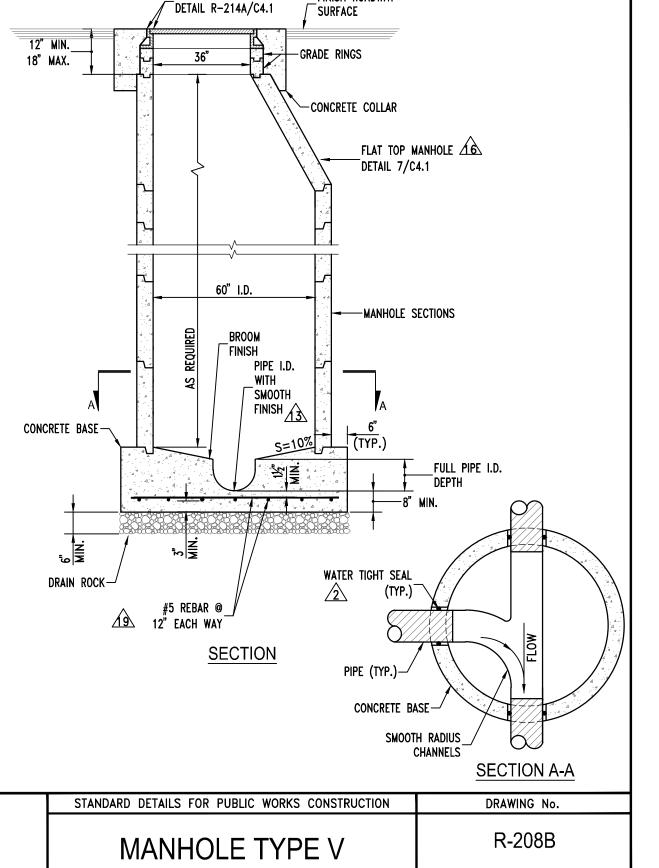
TOP VIEW

SIDE SECTION VIEW

7/6/06 60_6W_FLATTOP_CONC_B.dwg © 2006 Janeen Precest

GRADE RING/RISER







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CAUTION - NOTICE TO CONTRACTOR . THE CONTRACTOR IS SPECIFICALLY CAUTIONED THAT THE LOCATION AND/OR ELEVATION OF EXISTING UTILITIES AND FEATURES AS SHOWN ON THESE PLANS IS BASED ON THE BEST INFORMATION AVAILABLE TO THE ENGINEER. THE INFORMATION IS NOT TO BE RELIED ON AS BEING EXACT OR

2. IT SHALL BE THE CONTRACTOR'S RESPONSIBILITY TO VERIFY THESE LOCATIONS AND/OR ELEVATIONS AT THE PROPOSED POINTS OF CONNECTION AND IN AREAS OF POSSIBLE CONFLICT PRIOR TO BEGINNING CONSTRUCTION. SHOULD THE CONTRACTOR FIND ANY DISCREPANCIES BETWEEN THE CONDITIONS EXISTING IN THE FIELD AND THE INFORMATION SHOWN ON THESE DRAWINGS, HE SHALL NOTIFY THE ENGINEER BEFORE PROCEEDING WITH CONSTRUCTION.

3. IT SHALL BE THE RESPONSIBILITY OF THE CONTRACTOR TO REMOVE OR RELOCATE ALL EXISTING UTILITIES AND FEATURES WHICH CONFLICT WITH THE PROPOSED IMPROVEMENTS SHOWN ON THE PLANS. CONTRACTOR SHALL OBTAIN APPROVALS FROM THE GOVERNING AGENCIES, THE ENGINEER, AND THE UTILITY COMPANIES PRIOR TO SUCH REMOVAL AND/OR RELOCATION. 4. THE CONTRACTOR ASSUMES ALL RISK FOR ANY CONSTRUC-

TION PERFORMED WITH PRELIMINARY OR NONAPPROVED PLANS. 5. CONTRACTOR TO PROVIDE TRAFFIC CONTROL IN CONFORM-ANCE WITH THE LATEST EDITION OF MUTCD WHENEVER CON— STRUCTION IS IN PROGRESS WITHIN THE PUBLIC TRAVEL WAY.

60" MANHOLE FLAT TOP

60" I.D. × 6" WALL

CONCENTRIC ACCESS

OPENING

CONCENTRIC

SIDE SECTION VIEW

6072FT-24C CON FLAT TOP 3088 LBS.

6072FT-36C CON FLAT TOP 2614 LBS.

FLAT TOPS AND BASE SLABS

ARE DESIGNED TO AASHTO

FOR COMPLETE DESIGN, AND PRODUCT INFORMATION

CONTACT JENSEN PRECAST.

HS-20 WHEEL LOADING.

CONFORMS TO ASTM SPECS C-478

and AASHTO No. M199.

APPROX. WT.

(24" DIA. ACCESS OPENING SHOWN)


FLAT TOP WITH

STANDARD DETAILS FOR PUBLIC WORKS CONSTRUCTION	DRAWING No.
TEMPORARY MANHOLE	R-214C
COVER	

DEBRIS FROM ENTERING SEWER SYSTEM. THE MANHOLE BASE COVER SHALL BE IN PLACE PRIOR TO PERFORMING ANY


ADJUSTMENTS OR GROUTING AND SHALL REMAIN IN PLACE WHILE ADJUSTMENTS OR GROUTING ARE BEING PERFORMED.

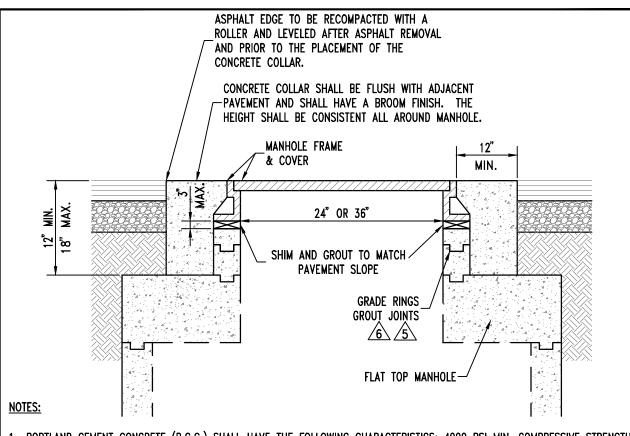REMOVE BASE COVER UPON ADJUSTMENT APPROVAL BY CITY OF SPARKS.



- PORTLAND CEMENT CONCRETE (P.C.C.) SHALL HAVE THE FOLLOWING CHARACTERISTICS: 4000 PSI MIN. COMPRESSIVE STRENGTH AT 28 DAYS, MIN. 6 SACKS OF CEMENT PER CUBIC YARD WITH MAX. WATER-CEMENT RATIO OF 0.45, AIR ENTRAINMENT 6% $\pm 1.5\%$, SLUMP AT 1 TO 4 INCHES. MIX DESIGN SHALL CONFORM TO THE REQUIREMENTS OF SECTION 337 OF STANDARD SPECIFICATIONS OF PUBLIC WORKS CONSTRUCTION (SSPWC). CEMENT SHALL BE TYPE II. ALL CEMENT CONCRETE SHALL HAVE A COARSE AGGREGATE GRADATION CONFORMING TO SIZE No. 67. ALL MATERIALS SHALL CONFORM TO SSPWC.
- . CIRCUMSTANCES MAY REQUIRE THE NEED FOR SPECIAL TYPES OF TOP OF MANHOLE CONFIGURATIONS SUCH AS FLAT TOP, ABOVE GROUND, ETC. AS DIRECTED BY THE CITY OF SPARKS. DETAILED PLANS OF ANY SPECIAL TOP OF MANHOLE CONFIGURATIONS AND ASSOCIATED COLLARS MUST BE APPROVED BY THE ENGINEER.
- 3. IN UNPAYED AREAS, IT SHALL BE NECESSARY TO SET THE MANHOLE RIM APPROXIMATELY 6 INCHES ABOVE THE SURROUNDING AREA. INSTALL A 6 INCH THICK RING OF CONCRETE, TAPERED AT A 3:1 SLOPE, FROM THE TOP, OUTSIDE EDGE OF THE COLLAR TO THE EXISTING GROUND SURFACE.
- 4. EXISTING SANITARY SEWER MANHOLE LIDS LOCATED IN GUTTER PANS, SHALL HAVE NEW WATER TIGHT FRAMES AND COVERS.
- 5. ALL GRADE RING JOINTS ARE TO BE GROUTED WITH NON-SHRINK GROUT HAVING THE FOLLOWING CHARACTERISTICS: 3000 PSI MIN. COMPRESSIVE STRENGTH AT 28 DAYS, MIN. 6 SACKS OF CEMENT PER CUBIC YARD AND SLUMP AT 1 TO 4 INCHES. ALL MATERIAL SHALL CONFORM TO SSPWC.
- 6. ALL GRADE RINGS SHALL BE PORTLAND CEMENT CONCRETE. PVC GRADE RINGS ARE NOT ALLOWED.

STANDARD DETAILS FOR PUBLIC WORKS CONSTRUCTION	DRAWING No.
MANHOLE COLLAR	R-218A

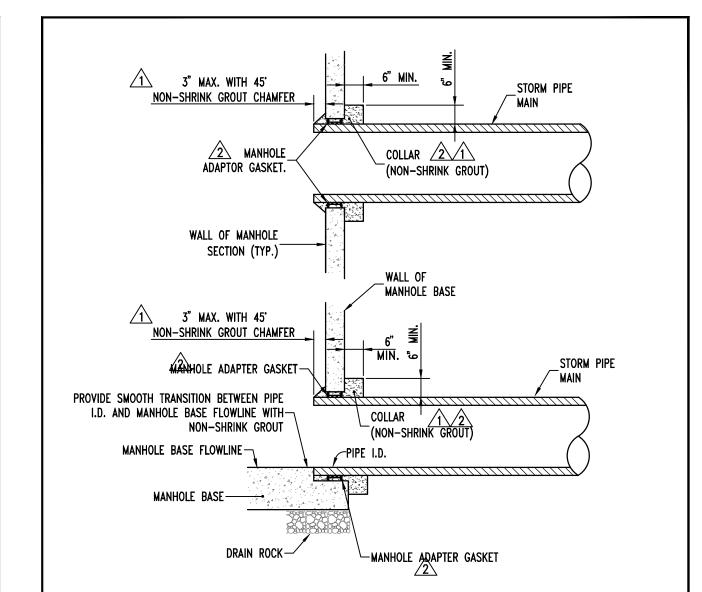


- NON-SHRINK GROUT SHALL HAVE THE FOLLOWING CHARACTERISTICS: 3000 PSI MIN. COMPRESSIVE STRENGTH AT 28 DAYS, MIN. 6 SACKS OF CEMENT PER CUBIC YARD AND SLUMP AT 1 TO 4 INCHES. ALL MATERIAL SHALL CONFORM TO SSPWC
- STORM DRAIN PIPE CONNECTIONS TO MANHOLE BASES AND SECTIONS REQUIRE AN AGENCY-APPROVED FORM OF SEAL OR WATER STOP AND IS REQUIRED ON ALL STORM DRAIN INSTALLATIONS TO PROVIDE A WATERTIGHT CONNECTION. UTILIZE A ROMAC STYLE "LCT" MANHOLE ADAPTER GASKET OR APPROVED EQUAL IN CONJUNCTION WITH THE NON-SHRINK GROUT.

A RESILIENT FLEXIBLE CONNECTOR INSTALLED IN ACCORDANCE WITH STANDARD DETAIL R-223C MAY BE USED TO SATISFY

- THE REQUIREMENTS OF NOTE 2 ABOVE.
- ALL PIPE OPENINGS TO NEW MANHOLES MUST BE EITHER CAST-IN-PLACE OR PRE-FORMED AND PIPE OPENINGS TO EXISTING MANHOLES MUST BE CORE DRILLED.

CTIVIDAD DETAILS FOR DUDIES WARVE COMPANIATION	
STANDARD DETAILS FOR PUBLIC WORKS CONSTRUCTION	DRAWING No.
STORM DRAIN PIPE TO MANHOLE CONNECTION	R-223B

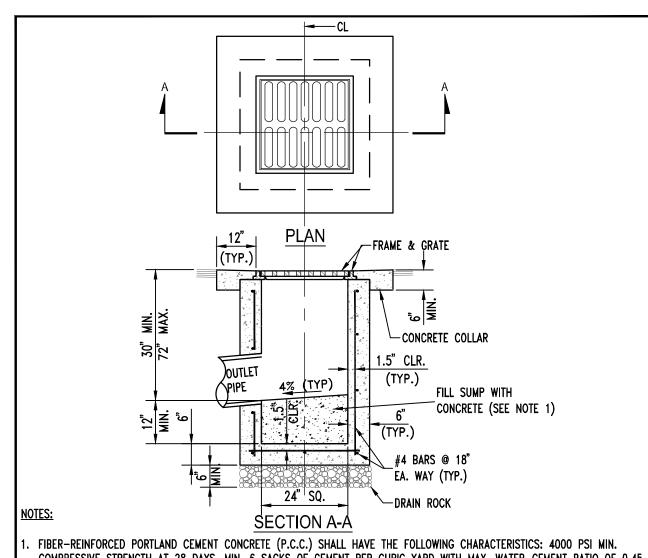

COMPRESSIVE STRENGTH AT 28 DAYS, MIN. 6 SACKS OF CEMENT PER CUBIC YARD WITH MAX. WATER-CEMENT RATIO OF 0.45, AIR ENTRAINMENT $6\% \pm 1.5\%$, SLUMP AT 1 TO 4 INCHES. MIX DESIGN SHALL CONFORM TO THE REQUIREMENTS OF SECTION 337 OF STANDARD SPECIFICATIONS OF PUBLIC WORKS CONSTRUCTION (SSPWC). CEMENT SHALL BE TYPE II. ALL CEMENT CONCRETE SHALL HAVE A COARSE AGGREGATE GRADATION CONFORMING TO SIZE No. 67. POLYPROPYLENE OR CELLULOSE FIBERS SHALL BE ADDED TO THE P.C.C. AT 1.5 LBS. PER CUBIC YARD. ALL MATERIALS SHALL CONFORM TO SSPWC.

- . REINFORCING STEEL SHALL BE GRADE 40 AND HAVE 1.5" CLEAR COVER.
- CONCRETE STRUCTURE MAY BE A PRE-CAST CONCRETE UNIT. BASE OF PRE-CAST CONCRETE UNIT SHALL BE PLACED ON 6" COMPACTED DRAIN ROCK.
- . FRAME & GRATE SHALL BE D&L I-9226 OR APPROVED EQUAL.
- 5. CATCH BASIN SHALL BE TRAFFIC-RATED AND USED ONLY AT LOW POINTS IN ALLEYS OR PARKING AREAS.
- . ALL CATCH BASINS, PUBLIC OR PRIVATE, SHALL BE PROVIDED WITH A "SUR-TRAP" OIL/WATER SEPARATOR OR APPROVED

STANDARD DETAILS FOR PUBLIC WORKS CONSTRUCTION	DRAWING No.
CATCH BASIN	R-205
TYPE 3-R	

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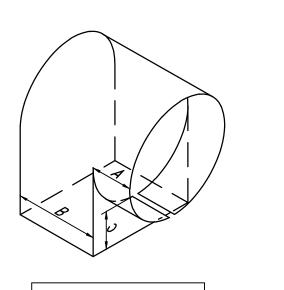
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4. THE CONTRACTOR ASSUMES ALL RISK FOR ANY CONSTRUC-TION PERFORMED WITH PRELIMINARY OR NONAPPROVED PLANS. 5. CONTRACTOR TO PROVIDE TRAFFIC CONTROL IN CONFORM-



DIMENSIONS				
SIZE	A	В	С	
4"	3"	3"	3"	
6"	4"	5"	4"	
8"	4"	6.5"	4"	
10"	4"	8"	4"	
12"	5"	10"	4"	
15"	6"	10.5"	6.5"	

<u>NOTES:</u>


- ALL CATCH BASINS, PUBLIC OR PRIVATE, SHALL BE PROVIDED WITH A "SUR-TRAP" OIL/WATER SEPARATOR OR APPROVED
- INSTALL OIL/WATER SEPARATOR WITH THE BOTTOM EDGE PARALLEL TO THE WATER SURFACE AND THE RECTANGULAR OPENING FACING DOWNWARD AND THE CIRCULAR END PLACED INSIDE THE OUTLET PIPE.


STANDARD DETAILS FOR PUBLIC WORKS CONSTRUCTION	DRAWING No.
CATCH BASIN	R-213
OIL /WATER SEPARATOR	

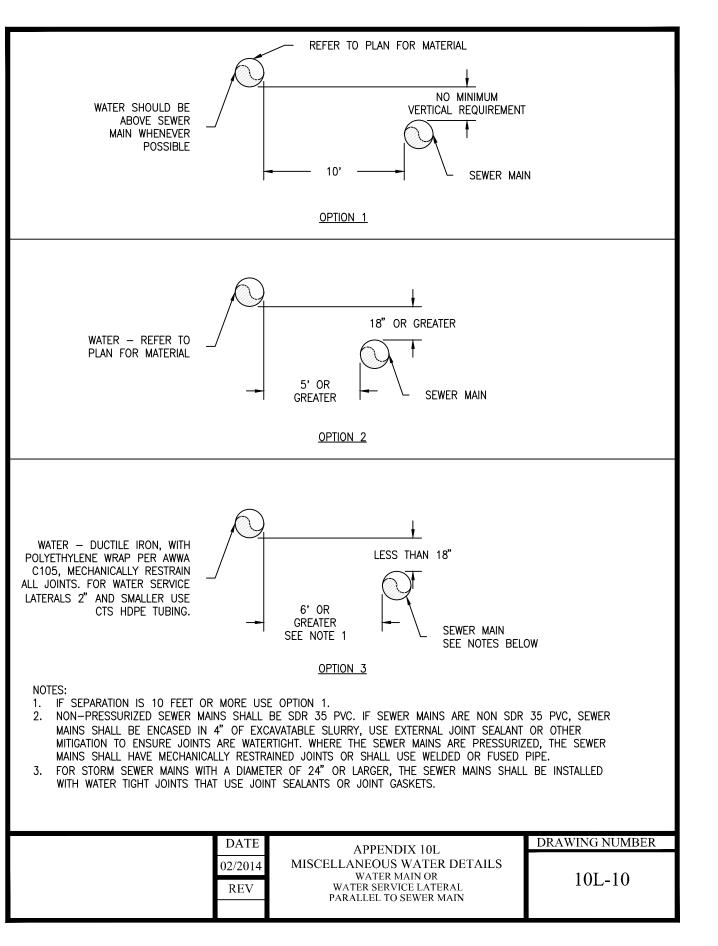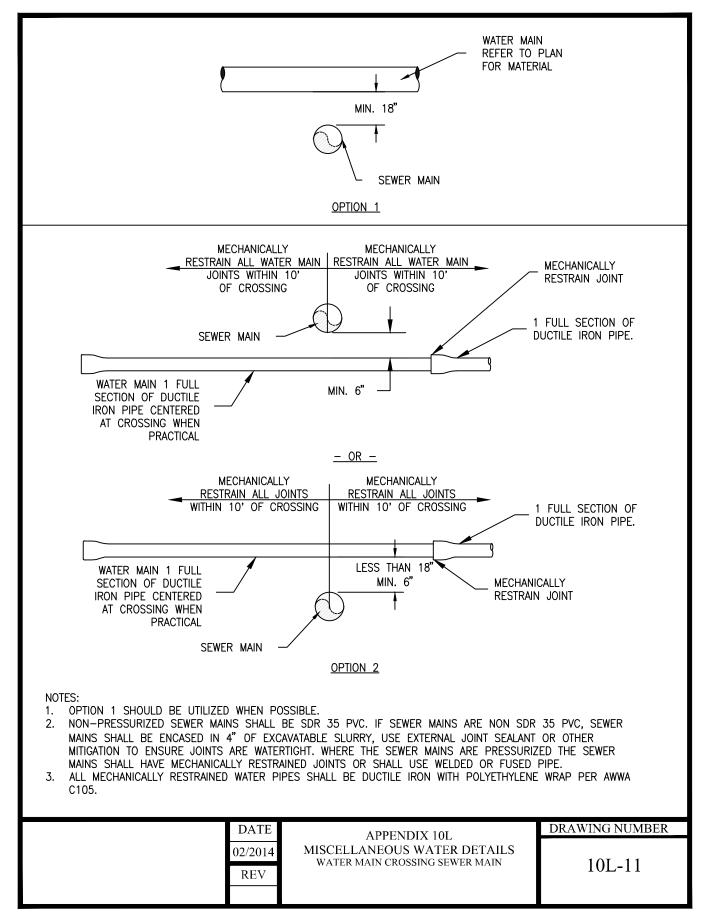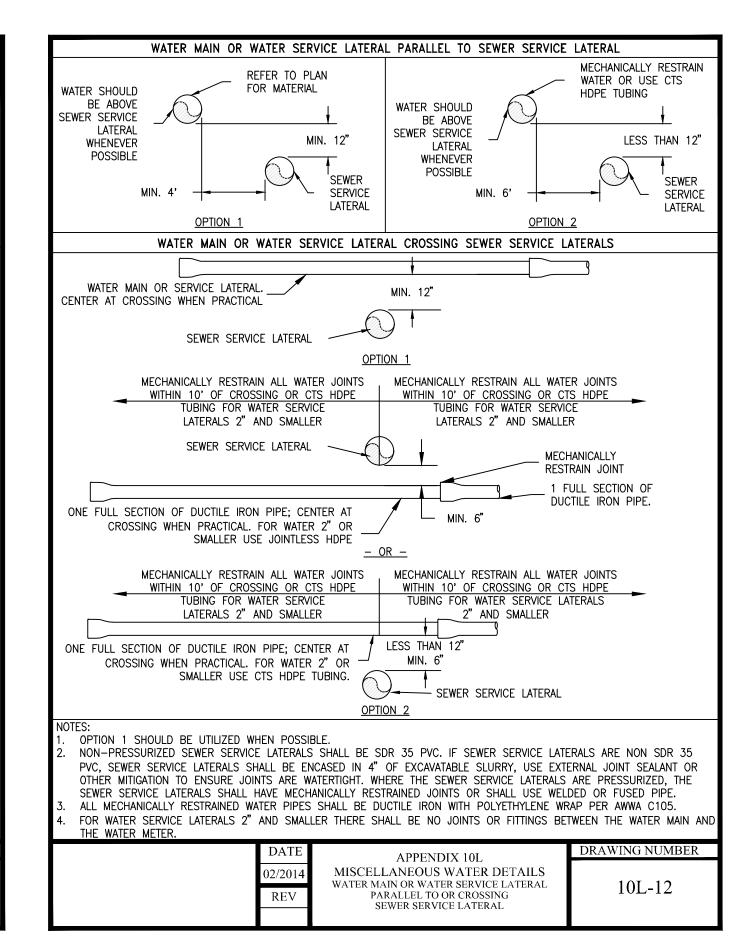
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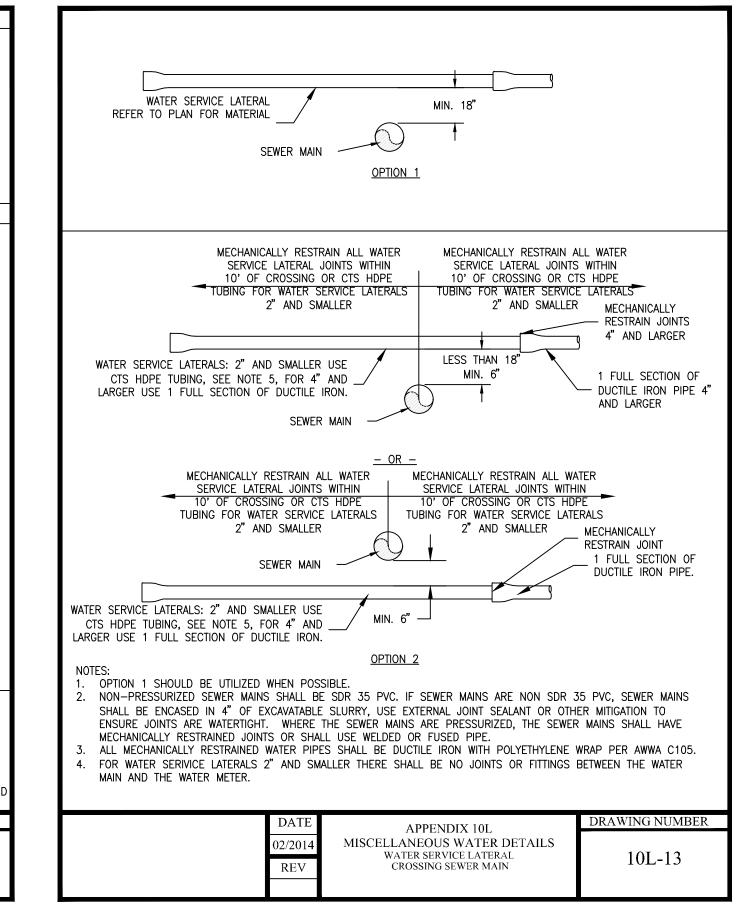


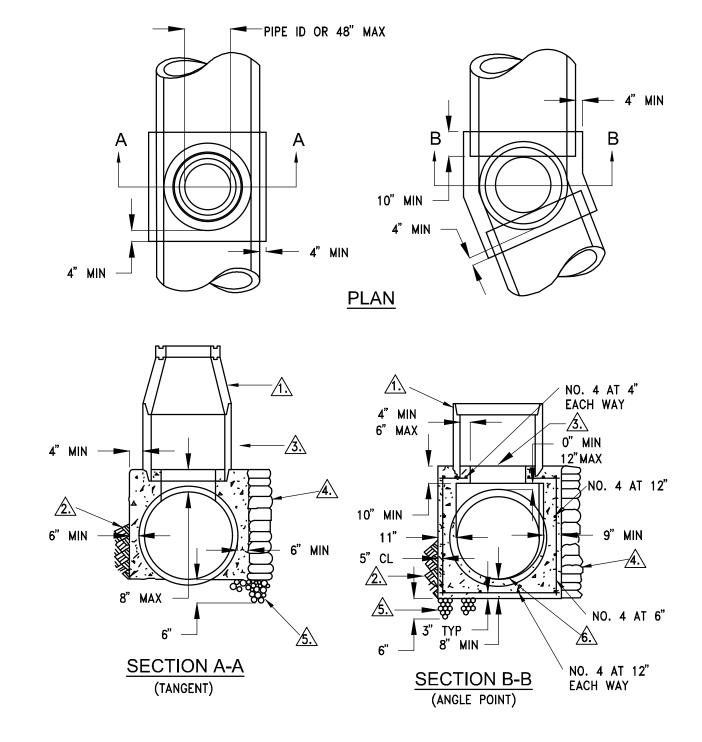
ANCE WITH THE LATEST EDITION OF MUTCD WHENEVER CON—STRUCTION IS IN PROGRESS WITHIN THE PUBLIC TRAVEL WAY.

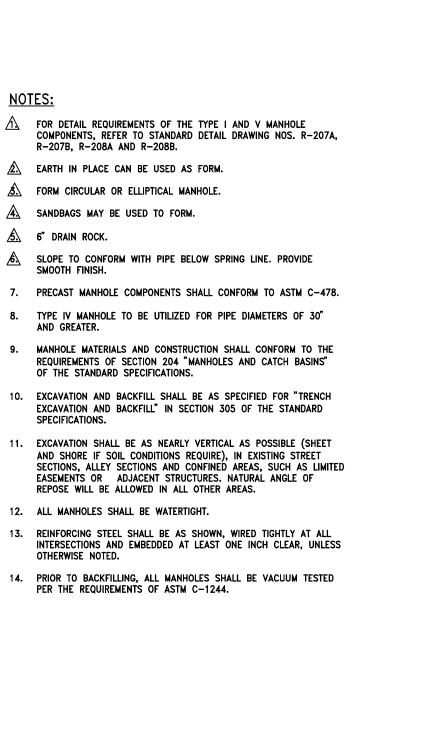














5. 6" DRAIN ROCK.

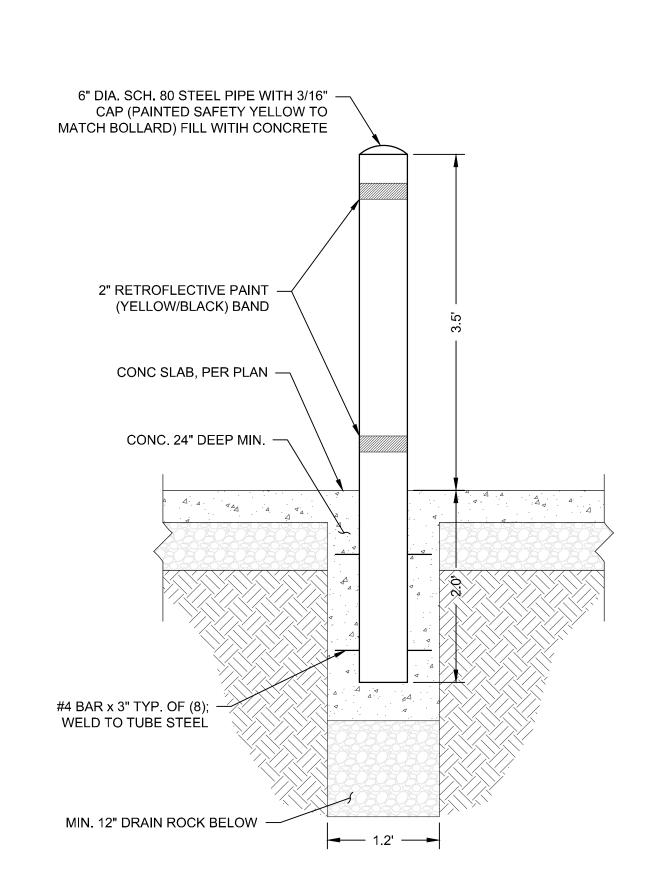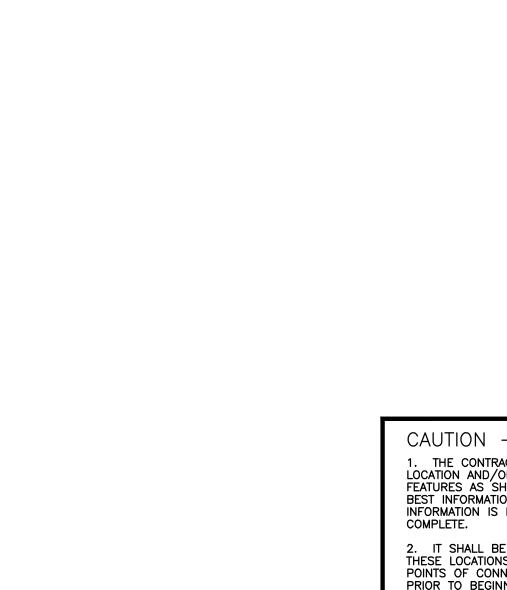AND GREATER.





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TYPE IV MANHOLE DETAIL N.T.S. - NDOT STANDARD R-4.3.2

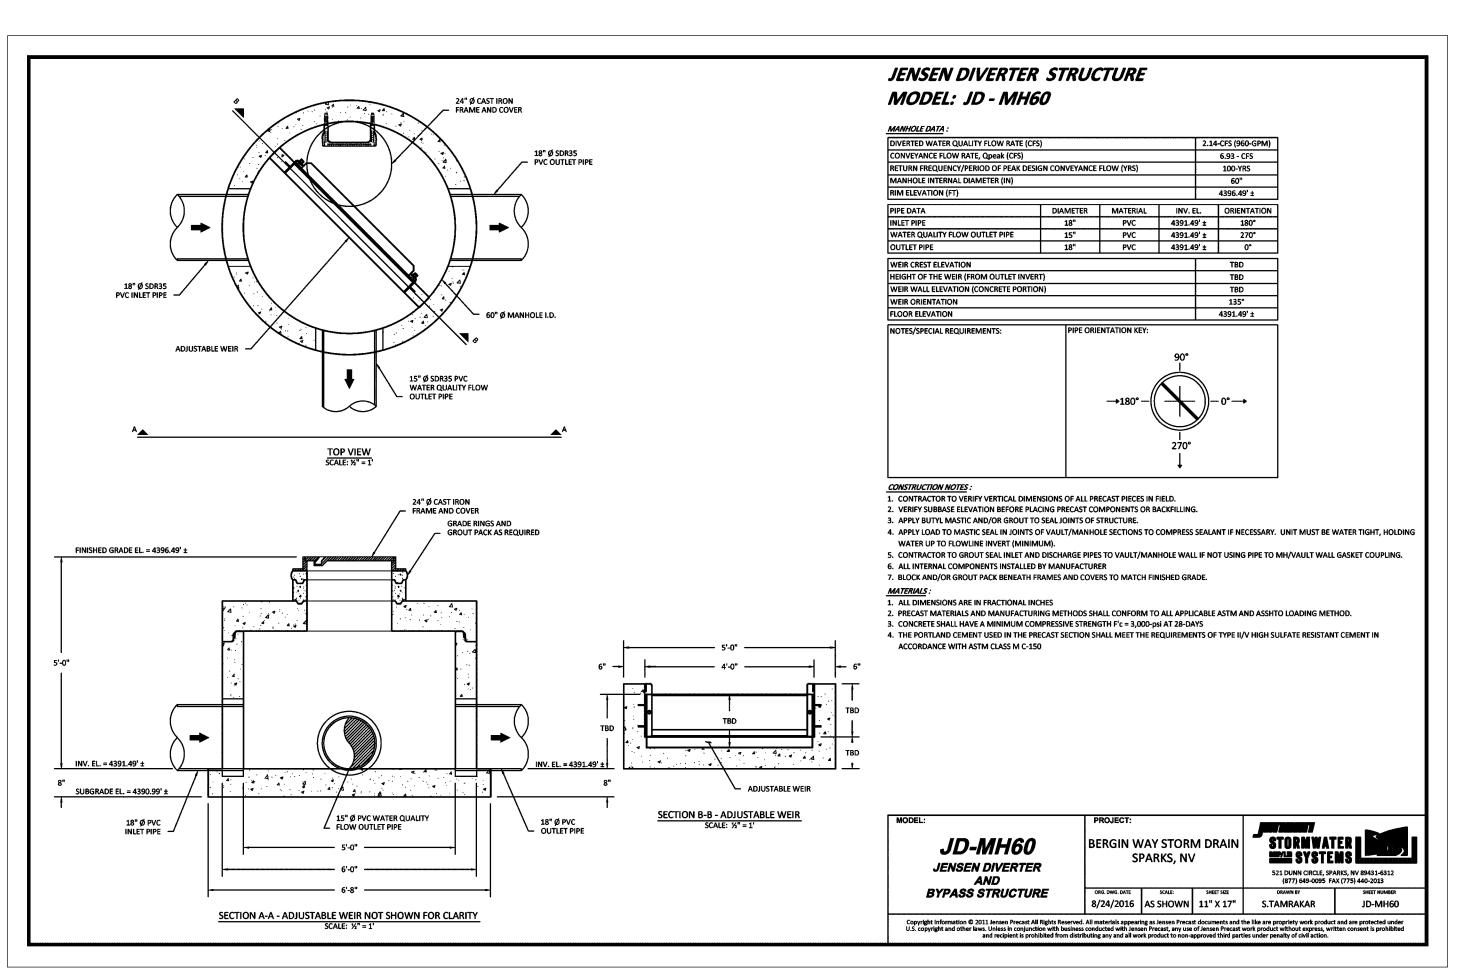
MANHOLE TYPE IV

NOT TO SCALE

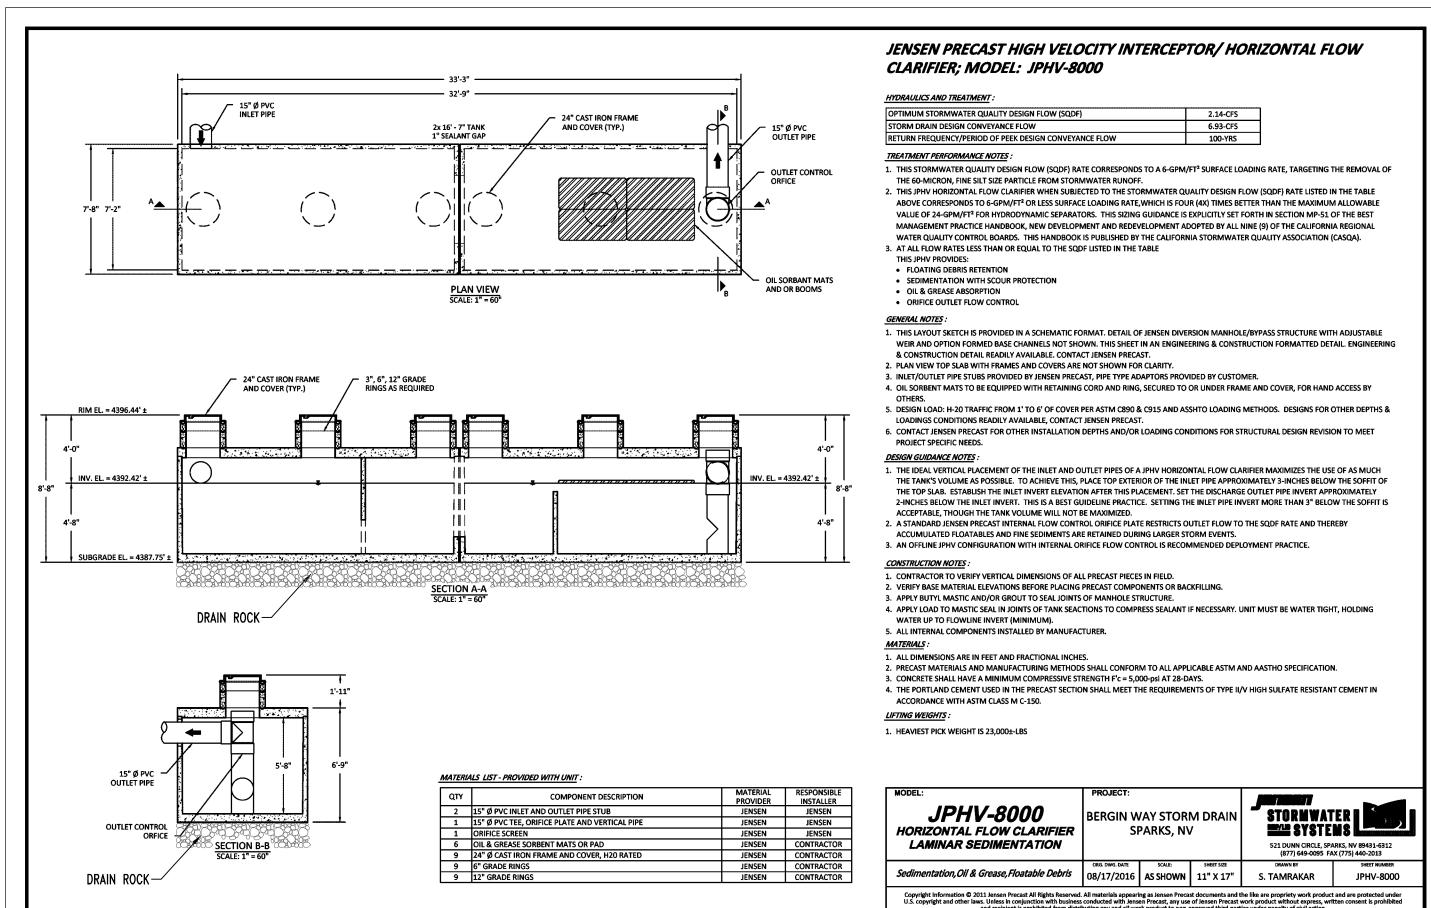
BOLLARD DETAIL

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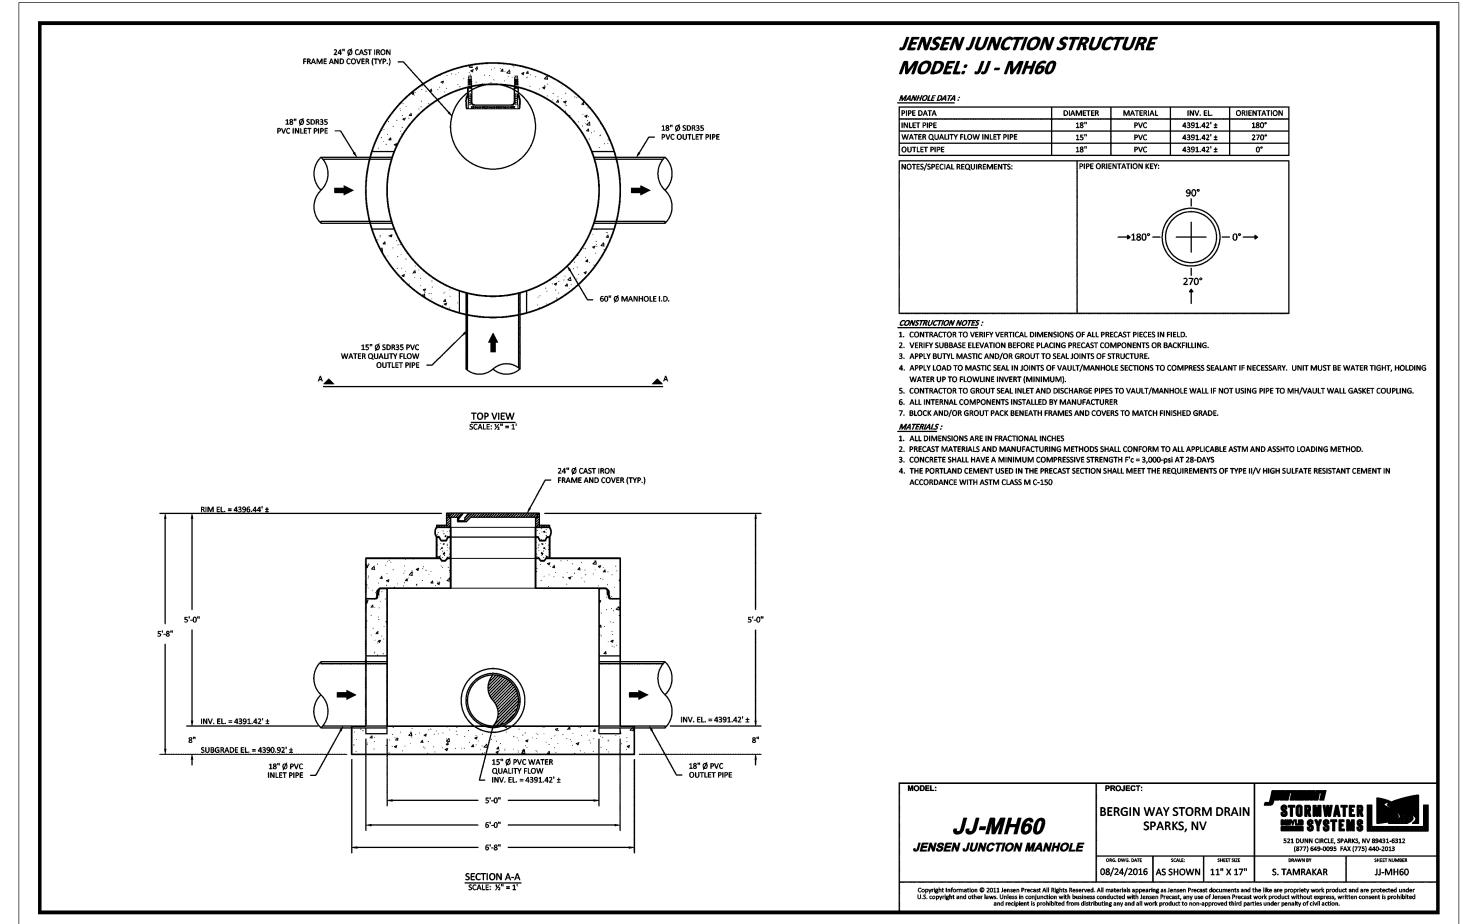
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JPHV-8000 STORMWATER INTERCEPTOR (OR APPROVED EQUAL)



JJ-MH60 JUNCTION MANHOLE (OR APPROVED EQUAL)

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