Vicinity Map

GENERAL NOTES

I. ALL CONSTRUCTION SHALL BE DONE IN ACCORDANCE WITH THE STANDARD SPECIFICATIONS FOR PUBLIC WORKS (ORANGE BOOK), LATEST EDITION, AND LATEST STANDARD DETAILS FOR PUBLIC WORKS

3. THE CONTRACTOR SHALL MAINTAIN A DUST CONTROL PROGRAM TO INCLUDE WATERING OF OPEN AREAS

4. THE EXISTING UTILITIES SHOWN ON THESE IMPROVEMENT PLANS ARE FOR THE CONTRACTOR'S INFORMATION AND WERE OBTAINED FROM UTILITY COMPANY RECORDS. IT IS THE CONTRACTOR'S RESPONSIBILITY TO FIELD

A) THE CONTRACTOR SHALL MAINTAIN ALL EXISTING DRAINAGE FACILITIES WITHIN THE CONSTRUCTION AREA UNTIL NEW DRAINAGE IMPROVEMENTS ARE IN PLACE AND FUNCTIONING.

6. IN ORDER TO EXPEDITE THE INSPECTION AND TESTING OF MATERIALS, THE CONTRACTOR SHALL FURNISH COMPLETE STATEMENTS TO THE ENGINEER AS TO THE ORIGIN, COMPOSITION AND MANUFACTURE OF ALL

MATERIALS TO BE USED IN THE WORK. SUCH STATEMENTS SHALL BE FURNISHED PROMPTLY AFTER EXECUTION OF THE CONTRACT, BUT IN ALL CASES PRIOR TO DELIVERY OF SUCH MATERIALS.

7. ALL EXCAVATION AND EMBANKMENT SHALL BE IN ACCORDANCE WITH THE LATEST EDITION OF STANDARD SPECIFICATIONS FOR PUBLIC WORKS CONSTRUCTION.

QUESTIONS REGARDED THE STATED OR IMPLIED MEANING OF THESE PLANS, THE CONTRACTOR IS DIRECTED

9. ALL AREAS DISTURBED AND LEFT UNDEVELOPED FOR A PERIOD OF MORE THAN THIRTY (30) DAYS SHALL BE STABILIZED BY THE APPLICATION OF DUST PALLIATIVE.

IO. SHOULD ANY PREHISTORIC REMAINS OR ARTIFACTS BE DISCOVERED DURING SITE DEVELOPMENT, WORK SHALL TEMPORARILY BE HALTED AT THE SPECIFIC SITE AND THE DEPARTMENT OF CONSERVATION AND

12. NO MATERIALS OF ANY KIND SHALL BE STOCKPILED OR CONSTRUCTION EQUIPMENT PARKED ON CONCRETE OR ASPHALT SURFACES. STOCKPILING OF MATERIALS AND PARKING OF VEHICLES OR EQUIPMENT SHOULD ONLY OCCUR IN NON-PLANTED AREAS OR AROUND THE OUTSIDE PERIMETER OF THE DRIP LINE OF ANY

IS. EXCESS OR UNSUITABLE MATERIAL WHICH CANNOT BE USED ONSITE, SHALL BE DISPOSED OF OFFSITE AT THE SOLE COST AND EXPENSE OF THE CONTRACTOR, AND IN CONFORMANCE WITH CITY OF SPARKS PUBLIC

14. ALL EXISTING FEATURES IN CONFLICT WITH PROPOSED IMPROVEMENTS SHALL BE REMOVED, RELOCATED, AND/OR REPLACED. CONTRACTOR SHALL OBTAIN APPROVAL FROM THE ENGINEER AND THE GOVERNING

15. ALL P.C.C. CURB, GUTTER, SIDEMALK, AND SLOPE PAVING SHALL BE CLASS AA OR DA CONCRETE (4000

16. ALL CONCRETE CURB AND GUTTER SHALL HAVE 1/2" EXPANSION JOINTS EVERY 30 FOOT INTERVAL, AT ALL POINTS ABUTTING BUILDINGS OR STRUCTURES, AND AT ALL CURB RETURNS UNLESS OTHERWISE APPROVED

SILICONE APPLIED TO THE JOINT TO PREVENT WATER INTRUSION. WEAKENED PLANE JOINTS SHALL BE EVERY

17. CONCRETE SIDEWALKS SHALL HAVE 1/2" EXPANSION JOINTS AT ALL POINTS ABUTTING BUILDINGS AND STRUCTURES, EVERY 30 FOOT INTERVAL, AT ALL SIDEWALK RETURNS, AND OPPOSITE EXPANSION JOINTS IN ADJACENT CURB. EXPANSION JOINTS ABUTTING BUILDINGS AND STRUCTURES SHALL HAVE SILICONE APPLIED

18. IN AREAS WHERE NEW CURB, GUTTER OR SIDEWALK IS TO MATCH EXISTING, THE CONTRACTOR SHALL

19. THE CONTRACTOR SHALL ASSUME SOLE AND COMPLETE RESPONSIBILITY FOR JOB SITE CONDITIONS DURING THE COURSE OF CONSTRUCTION FOR THIS PROJECT, INCLUDING SAFETY OF ALL PERSONS AND

HOURS, AND THAT THE CONTRACTOR SHALL DEFEND, INDEMNIFY, AND HOLD THE OWNER, LANDSCAPE ARCHITECT, AND ENGINEER HARMLESS FROM ANY AND ALL LIABILITY, REAL OR ALLEGED, IN CONNECTION

TO THE JOINT TO PREVENT WATER INTRUSION, WEAKENED PLANE JOINTS SHALL BE LOCATED AT INTERVALS NOT EXCEEDING 1.2 TIMES THE WIDTH AND NO MORE FREQUENTLY THAN 0.8 TIMES THE WIDTH. IN NO CASE

PROPERTY; THAT THIS REQUIREMENT SHALL APPLY CONTINUOUSLY, AND NOT BE LIMITED TO NORMAL WORKING

21. THE CONTRACTOR SHALL PURSUE THE WORK IN A CONTINUOUS AND DILIGENT MANNER, CONFORMING TO ALL

23. THE CONTRACTOR SHALL PROTECT FROM DAMAGE EXISTING IMPROVEMENTS ON AND AROUND THE SITE INCLUDING, BUT NOT LIMITED TO, PAVEMENT, CURB AND GUTTER, SIDEWALK, LANDSCAPING, SIGNAGE, STORM

AND SANITARY SEMERS, UTILITIES, TELEPHONE, AND CABLE TELEVISION. THE CONTRACTOR SHALL ASSUME SOLE RESPONSIBILITY FOR THE REPAIR AND/OR REPLACEMENT OF ANY IMPROVEMENTS (NEW OR EXISTING)

I. THE CONTRACTOR IS CAUTIONED THAT THE LOCATION AND/OR ELEVATION OF EXISTING UTILITIES AND FEATURES AS SHOWN ON THESE PLANS IS BASED ON THE BEST INFORMATION AVAILABLE TO THE LANDSCAPE

PROPOSED POINTS OF CONNECTION AND IN AREAS OF POSSIBLE CONFLICT PRIOR TO BEGINNING

3. IT SHALL BE THE RESPONSIBILITY OF THE CONTRACTOR TO REMOVE OR RELOCATE ALL EXISTING UTILITIES AND FEATURES WHICH CONFLICT WITH THE PROPOSED IMPROVEMENTS SHOWN ON THE PLANS.

THE FIELD AND THE INFORMATION SHOWN ON THESE DRAWINGS, HE SHALL NOTIFY THE OWNER'S

2. IT IS BE THE CONTRACTOR'S RESPONSIBILITY TO VERIFY THESE LOCATIONS AND/OR ELEVATIONS AT THE

CONSTRUCTION. SHOULD THE CONTRACTOR FIND ANY DISCREPANCIES BETWEEN THE CONDITIONS EXISTING IN

CONTRACTOR SHALL OBTAIN APPROVALS FROM THE GOVERNING AGENCIES, THE OWNER'S REPRESENTATIVE,

DAMAGED THROUGHOUT THE COURSE OF CONSTRUCTION, EITHER AS A DIRECT RESULT OF HIS ACTIVITIES OR

WITH THE PERFORMANCE OF WORK ON THIS PROJECT, EXCEPTING FOR LIABILITY ARISING FROM THE SOLE

20. THE CONTRACTOR SHALL BE RESPONSIBLE FOR ALL EXCAVATION AND SHORING PROCEDURES AND

THE PERTINENT SAFETY REGULATIONS, TO INSURE A TIMELY COMPLETION OF THE PROJECT. 22. THE CONTRACTOR SHALL OBTAIN ALL NECESSARY PERMITS REQUIRED FOR THE WORK.

ARCHITECT. THE INFORMATION IS NOT TO BE RELIED ON AS BEING EXACT OR COMPLETE.

AND THE UTILITY COMPANIES PRIOR TO SUCH REMOVAL AND/OR RELOCATION.

IN WRITING BY THE ENGINEER, EXPANSION JOINTS ABUTTING BUILDINGS AND STRUCTURES SHALL HAVE

IO FEET AND STRUCK-THRU AS THE SPECIFICATIONS FOR PUBLIC WORKS CONSTRUCTION INDICATES.

SHALL REGULAR INTERVALS OF WEAKENED PLANE JOINTS IN EITHER DIRECTION EXCEED IO FEET.

NATURAL RESOURCES, DIVISION OF HISTORIC PRESERVATION AND ARCHEOLOGY, SHALL BE NOTIFIED TO RECORD AND PHOTOGRAPH THE SITE. THE PERIOD OF TEMPORARY DELAY SHALL BE LIMITED TO A MAXIMUM

II. A PRECONSTRUCTION MEETING WILL BE HELD WITH CITY OF SPARKS PRIOR TO ANY CONSTRUCTION

EXISTING OR PROPOSED TREE. NATURAL AREAS SHOULD RECEIVE NO COMPACTION DAMAGE

AGENCIES PRIOR TO SUCH REMOVAL, RELOCATION, AND/OR REPLACEMENT.

REMOVE THE EXISTING CURB, GUTTER, OR SIDEWALK TO THE CLOSEST JOINT.

NEGLIGENCE OF THE OWNER, LANDSCAPE ARCHITECT, OR THE ENGINEER.

CONFORM TO THE LATEST O.S.H.A. REQUIREMENTS.

HIS FAILURE TO ADEQUATELY PROTECT THE IMPROVEMENTS.

Existing Site Data Notes:

REPRESENTATIVE BEFORE PROCEEDING WITH CONSTRUCTION.

8. IT IS THE INTENT OF THESE SPECIFICATIONS AND IMPROVEMENT PLANS THAT THE WORK PERFORMED UNDER THE CONTRACT SHALL RESULT IN A COMPLETE OPERATING SYSTEM IN SATISFACTORY WORKING CONDITION WITH RESPECT TO THE FUNCTIONAL PURPOSES OF THE INSTALLATION. IF THERE ARE ANY

B) NO FENCE OR OTHER OBSTRUCTION WHICH INTERFERES WITH DRAINAGE SHALL BE CONSTRUCTED OR

VERIFY LOCATION, SIZE, TYPE, ETC. THE ENGINEER ASSUMES NO RESPONSIBILITY FOR THE UTILITIES NOT SHOWN OR NOT IN THE LOCATION SHOWN ON THESE PLANS. THE CONTRACTOR IS DIRECTED TO NOTIFY THE PROJECT ENGINEER IN CASE OF ANY CONFLICT BETWEEN NEW AND EXISTING UTILITIES.

CONSTRUCTION, EXCEPT AS MODIFIED BY THESE PLANS OR SPECIAL PROVISION

2. CALL USA 48 HRS. PRIOR TO INITIATING WORK 1-800-227-2600

TO CONTACT THE CONSULTING LANDSCAPE ARCHITECT IMMEDIATELY

OF TWO WORKING DAYS FROM THE DATE OF NOTIFICATION.

PSI), WITH BROOM FINISH, UNLESS OTHERWISE INDICATED.

1552 C STREET SPARKS, NEV. 89431

APRIL, 2017

PARK/SITE SPARKS NOT TO SCALE

CITY OF SPARKS APPROVAL

Jon R/ Ericson, P.E. PIOE City of Sparks Engineer

PROJECT TEAM:

City of Sparks, Parks and Recreation Department Contact: Chris Cobb, PE 98 Richards Way, Sparks, NV 89431 Ph. (775)353-2376

Landscape Architect LA Studio Nevada Contact: Dale Doerr, R.L.A. 1552 C Street, Sparks, Nevada 89431 Ph. (775) 323-2223

Civil Engineer Wood Rodgers Contact: Mike Davidson, P.E. Reno, NV 89502 Ph. (775) 823-4062

Electrical Engineer PK Electric, Inc. Contact: Joey Ganser, P.E. Reno, NV 89511 Ph. (775) 826-9010

SHEET INDEX:

- L-1 Cover Sheet
- L-2 Reference Plan
- L-3 Reference Plan

Civil Engineering

- **Grading Plan**
- Site Plan
- **Detail Sheet**
- **Erosion Control Plan**

Landscape Architecture

- Landscape Planting Plan
- Landscape Planting Plan
- Reclaimed Irrigation Plan
- Reclaimed Irrigation Plan
- Reclaimed Irrigation Details & Specs
- Landscape Planting Details & Specs
- Playground Specification Sheet


Electrical Engineering


E-0 Electrical Legend, Oneline Diagram, Panel Schedule, & Drawing Schedule

Electrical Notes & Diagram

Electrical Site Plan

BID SET

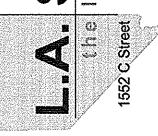

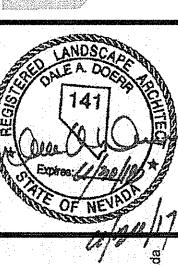


Revision Date

LA No: 257-504-08-16

Designed: DD Drawn: 655

Checked: RNH

Date: 6/20/17 Sheet

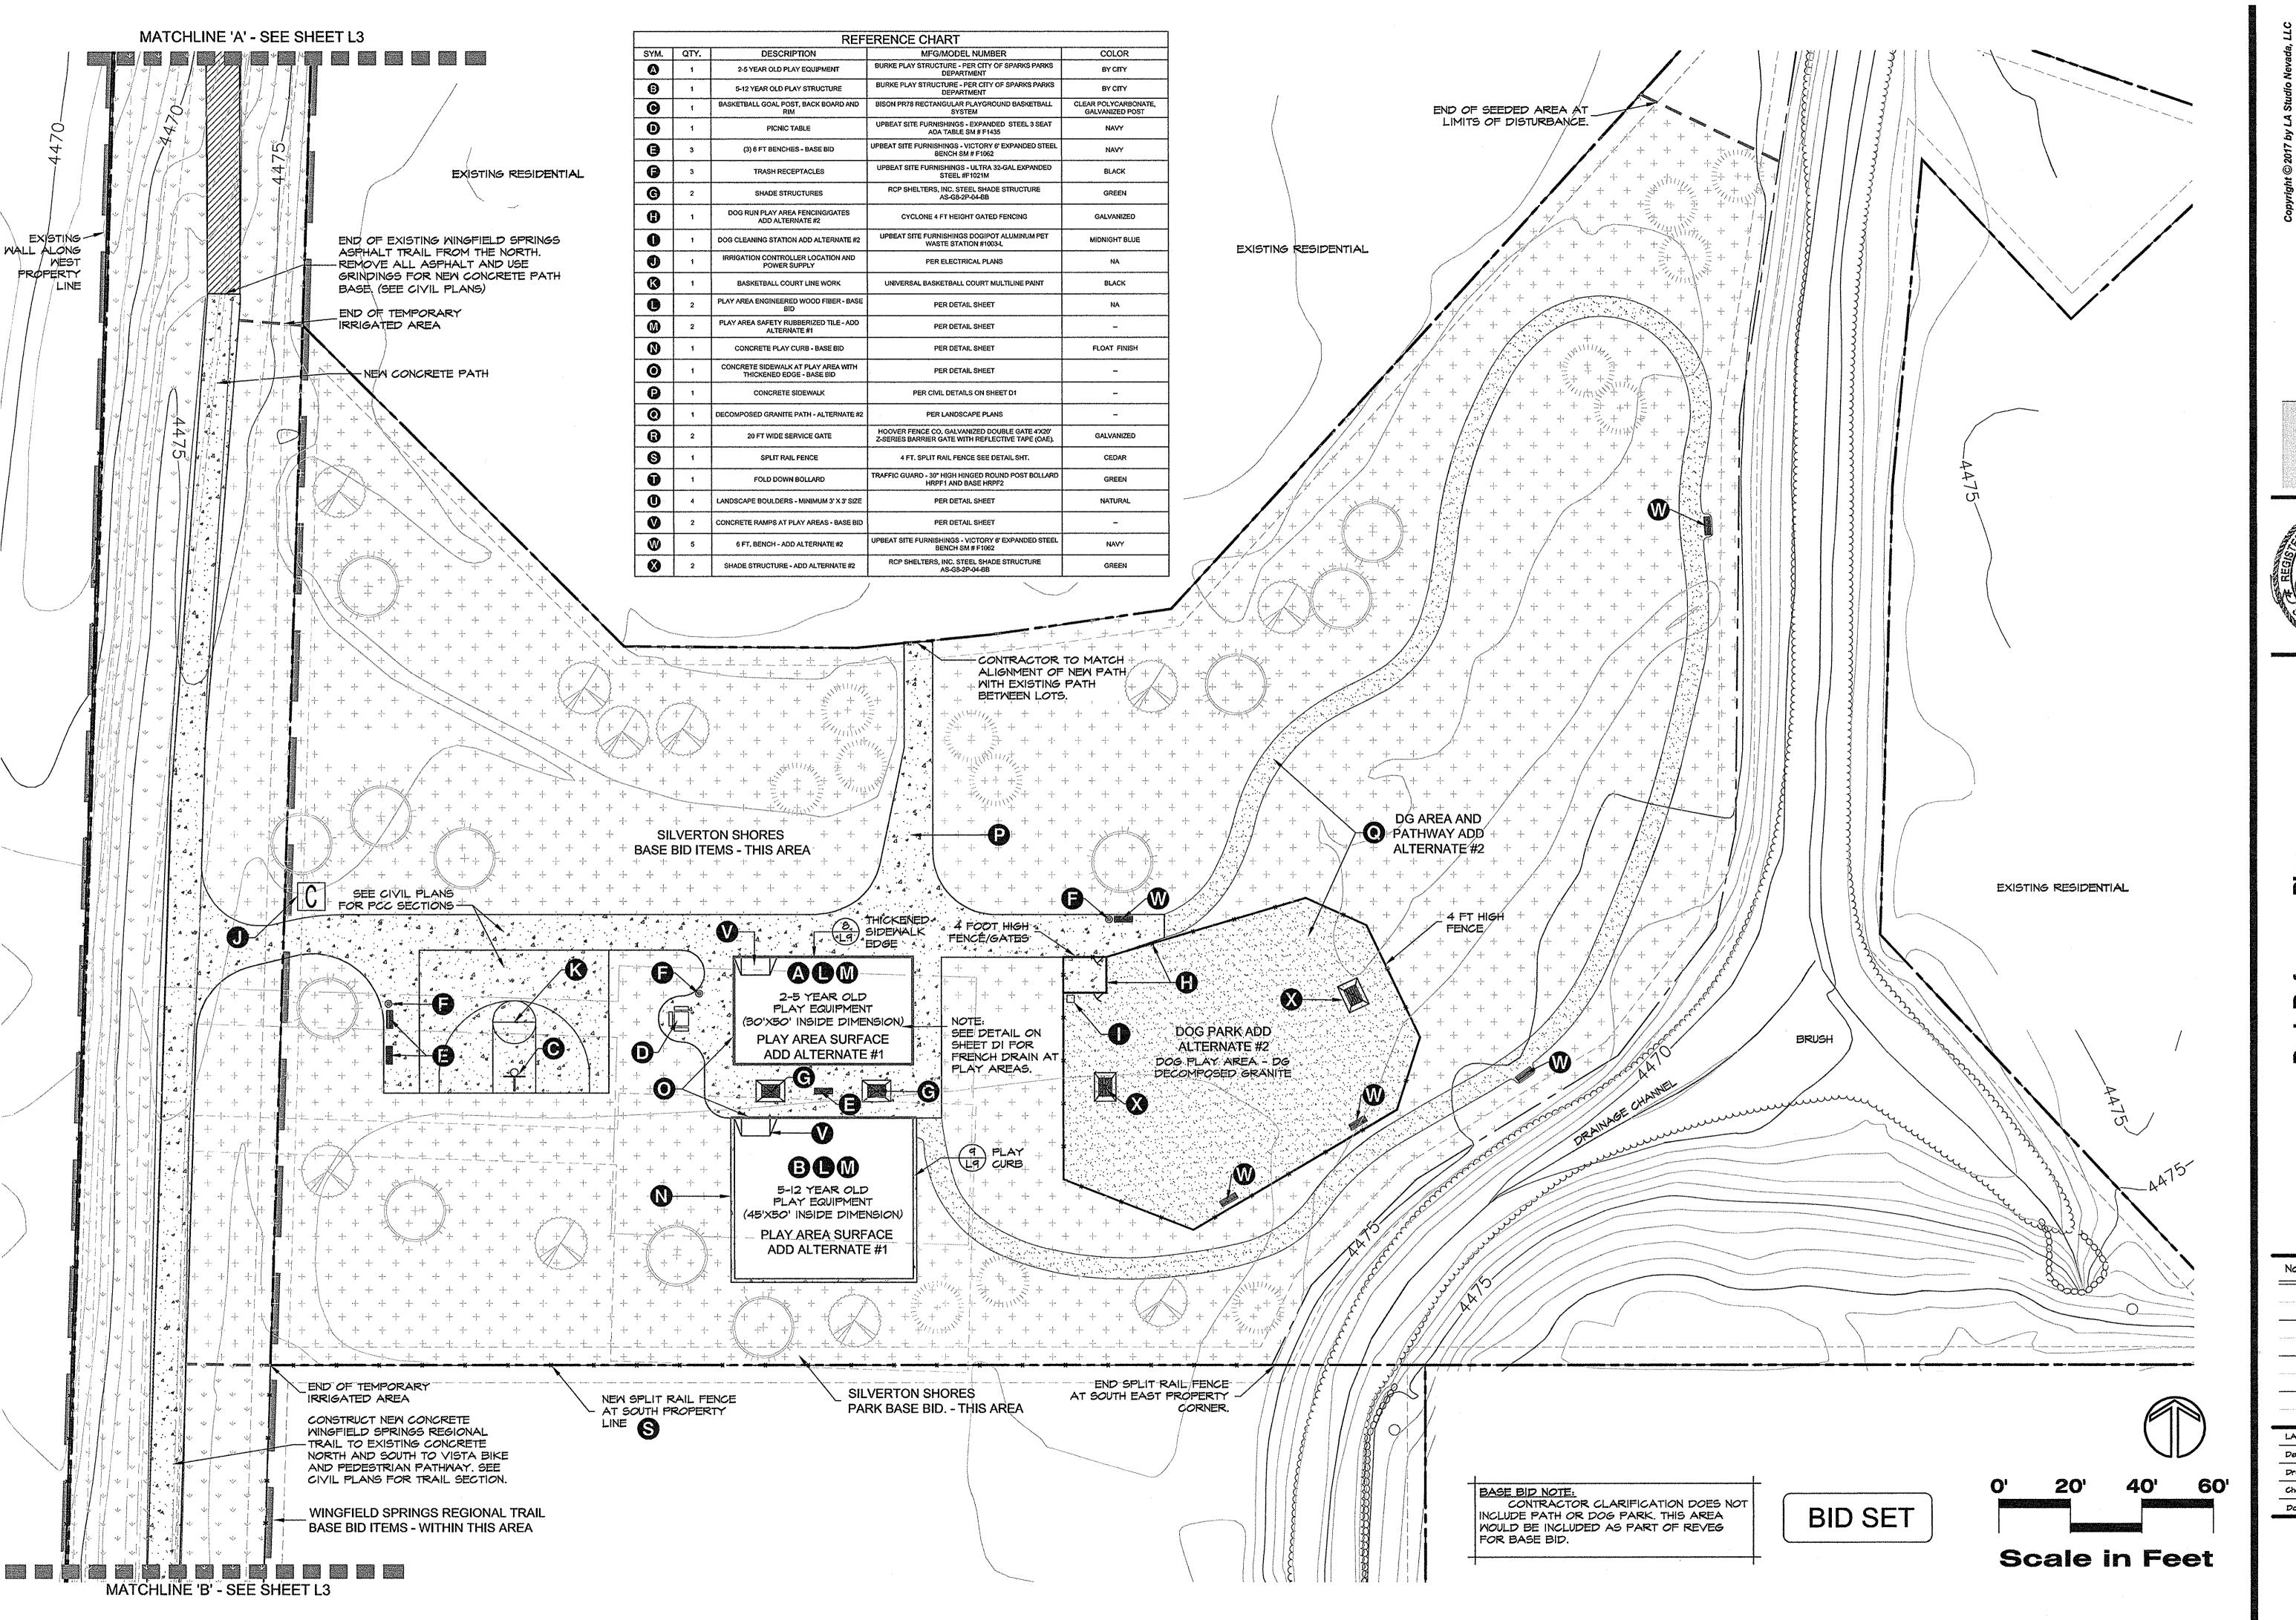



No. Revision Date


LA No: 257-504-08-16


Designed: DD


Drawn: 699 Checked: RMH


Date: 6/20/17 Sheet


L2

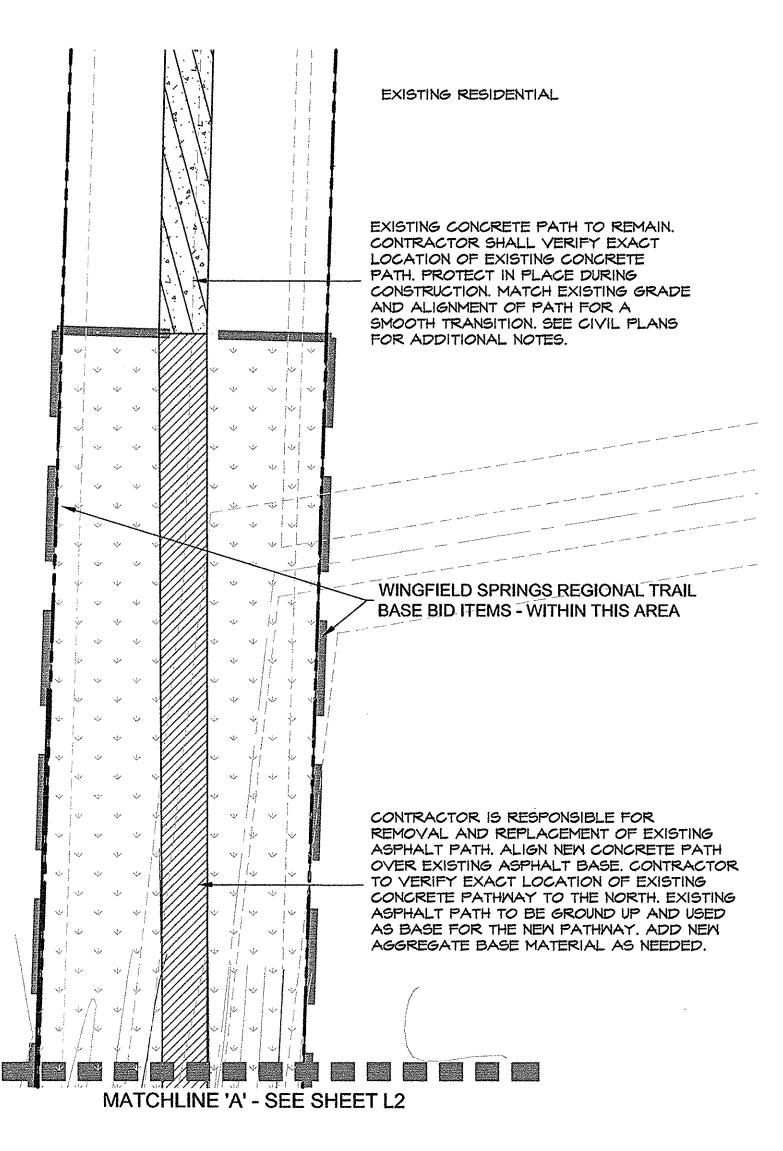

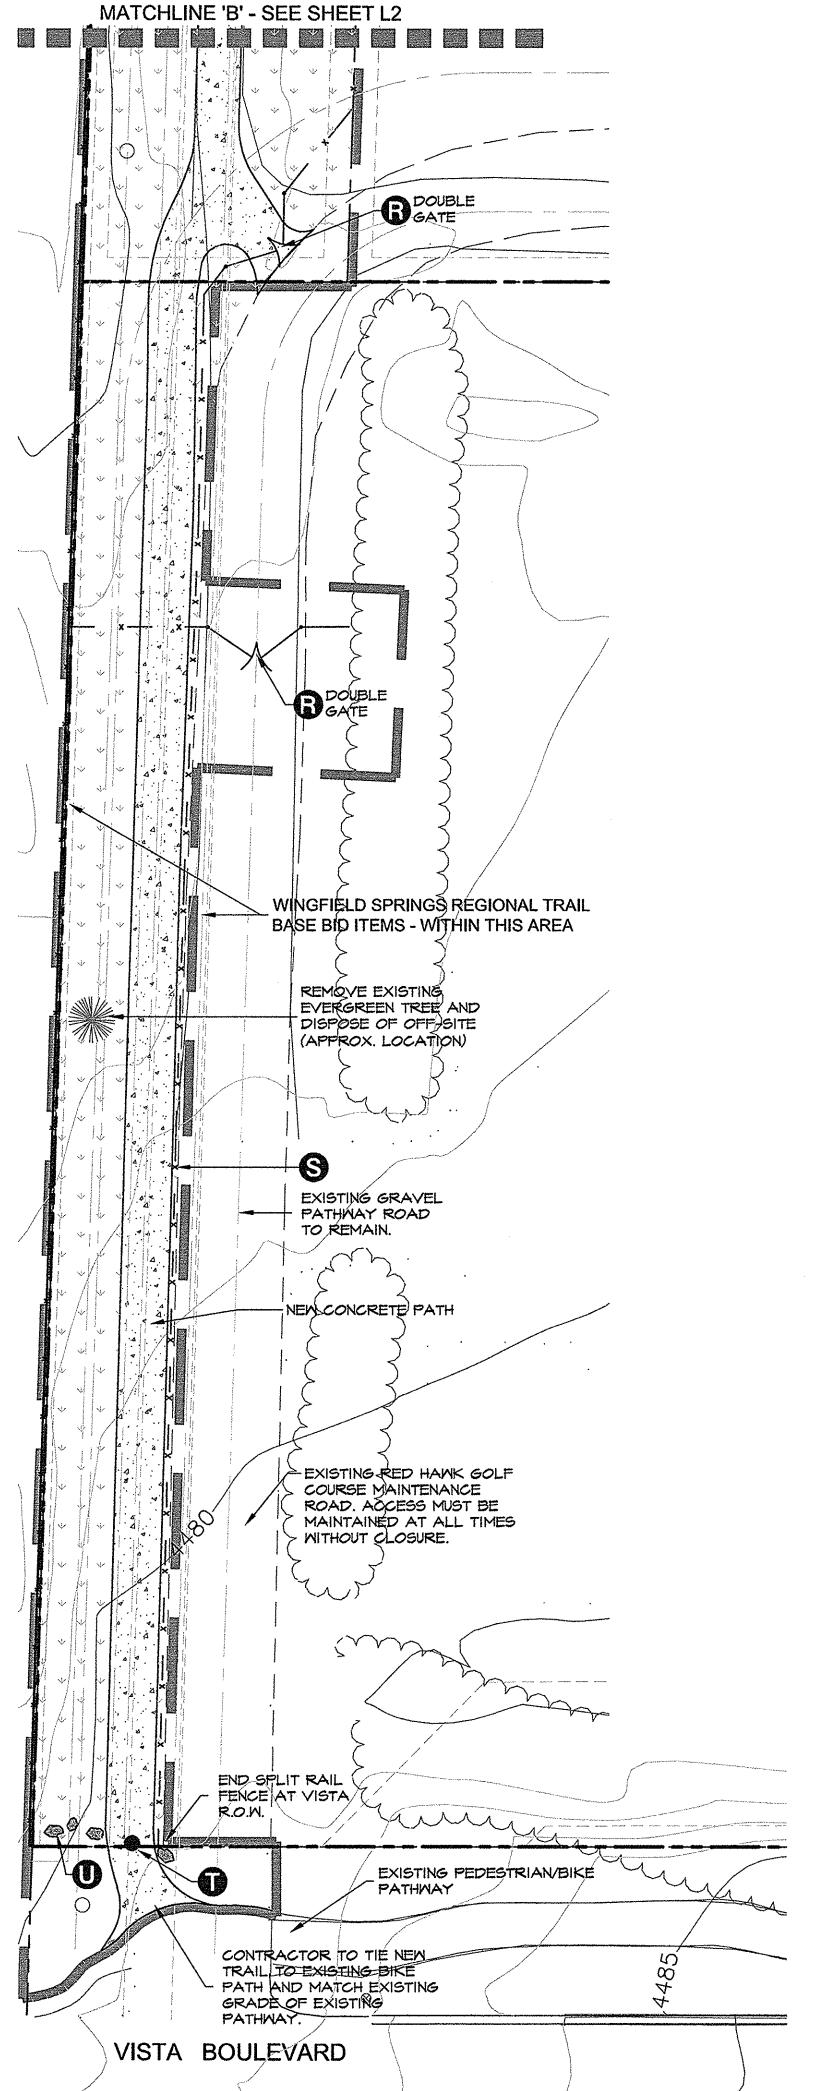

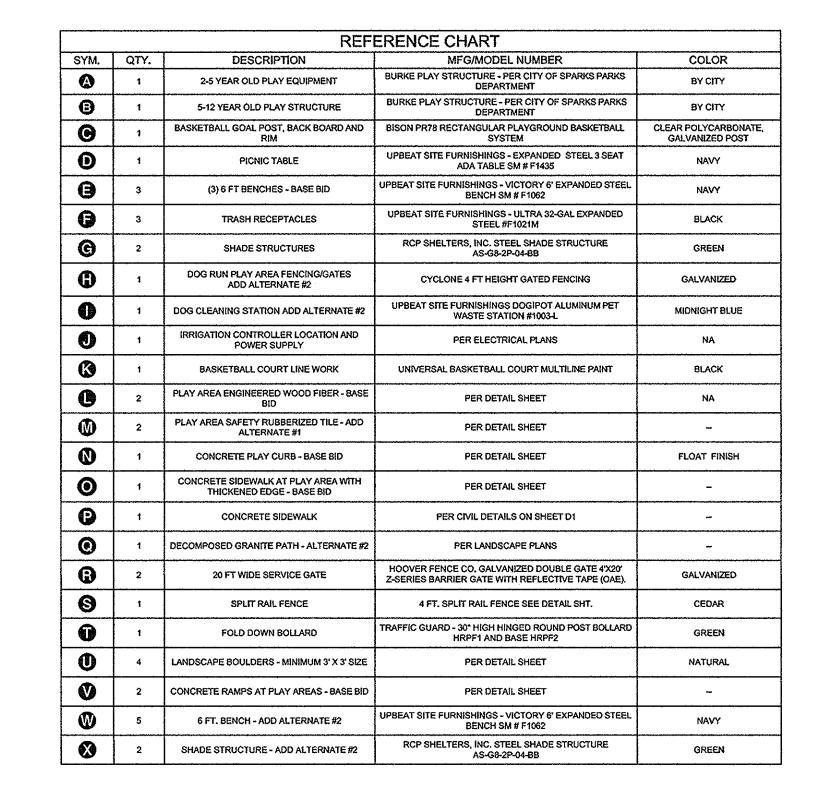

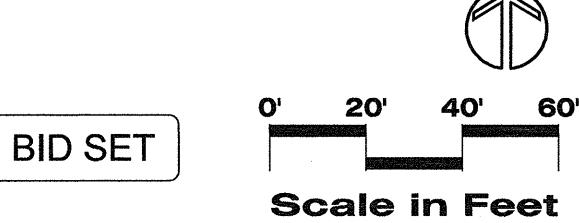

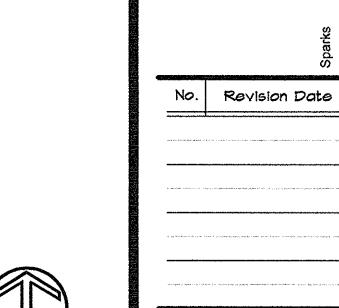

LA No: 257-304-08-16

Designed: DD

Drawn: 665

Checked: RWH

Date: 6/20/17

Sheet


Sheet **L3**


> of 16


Ē


TON SHORES PA


City of Spar

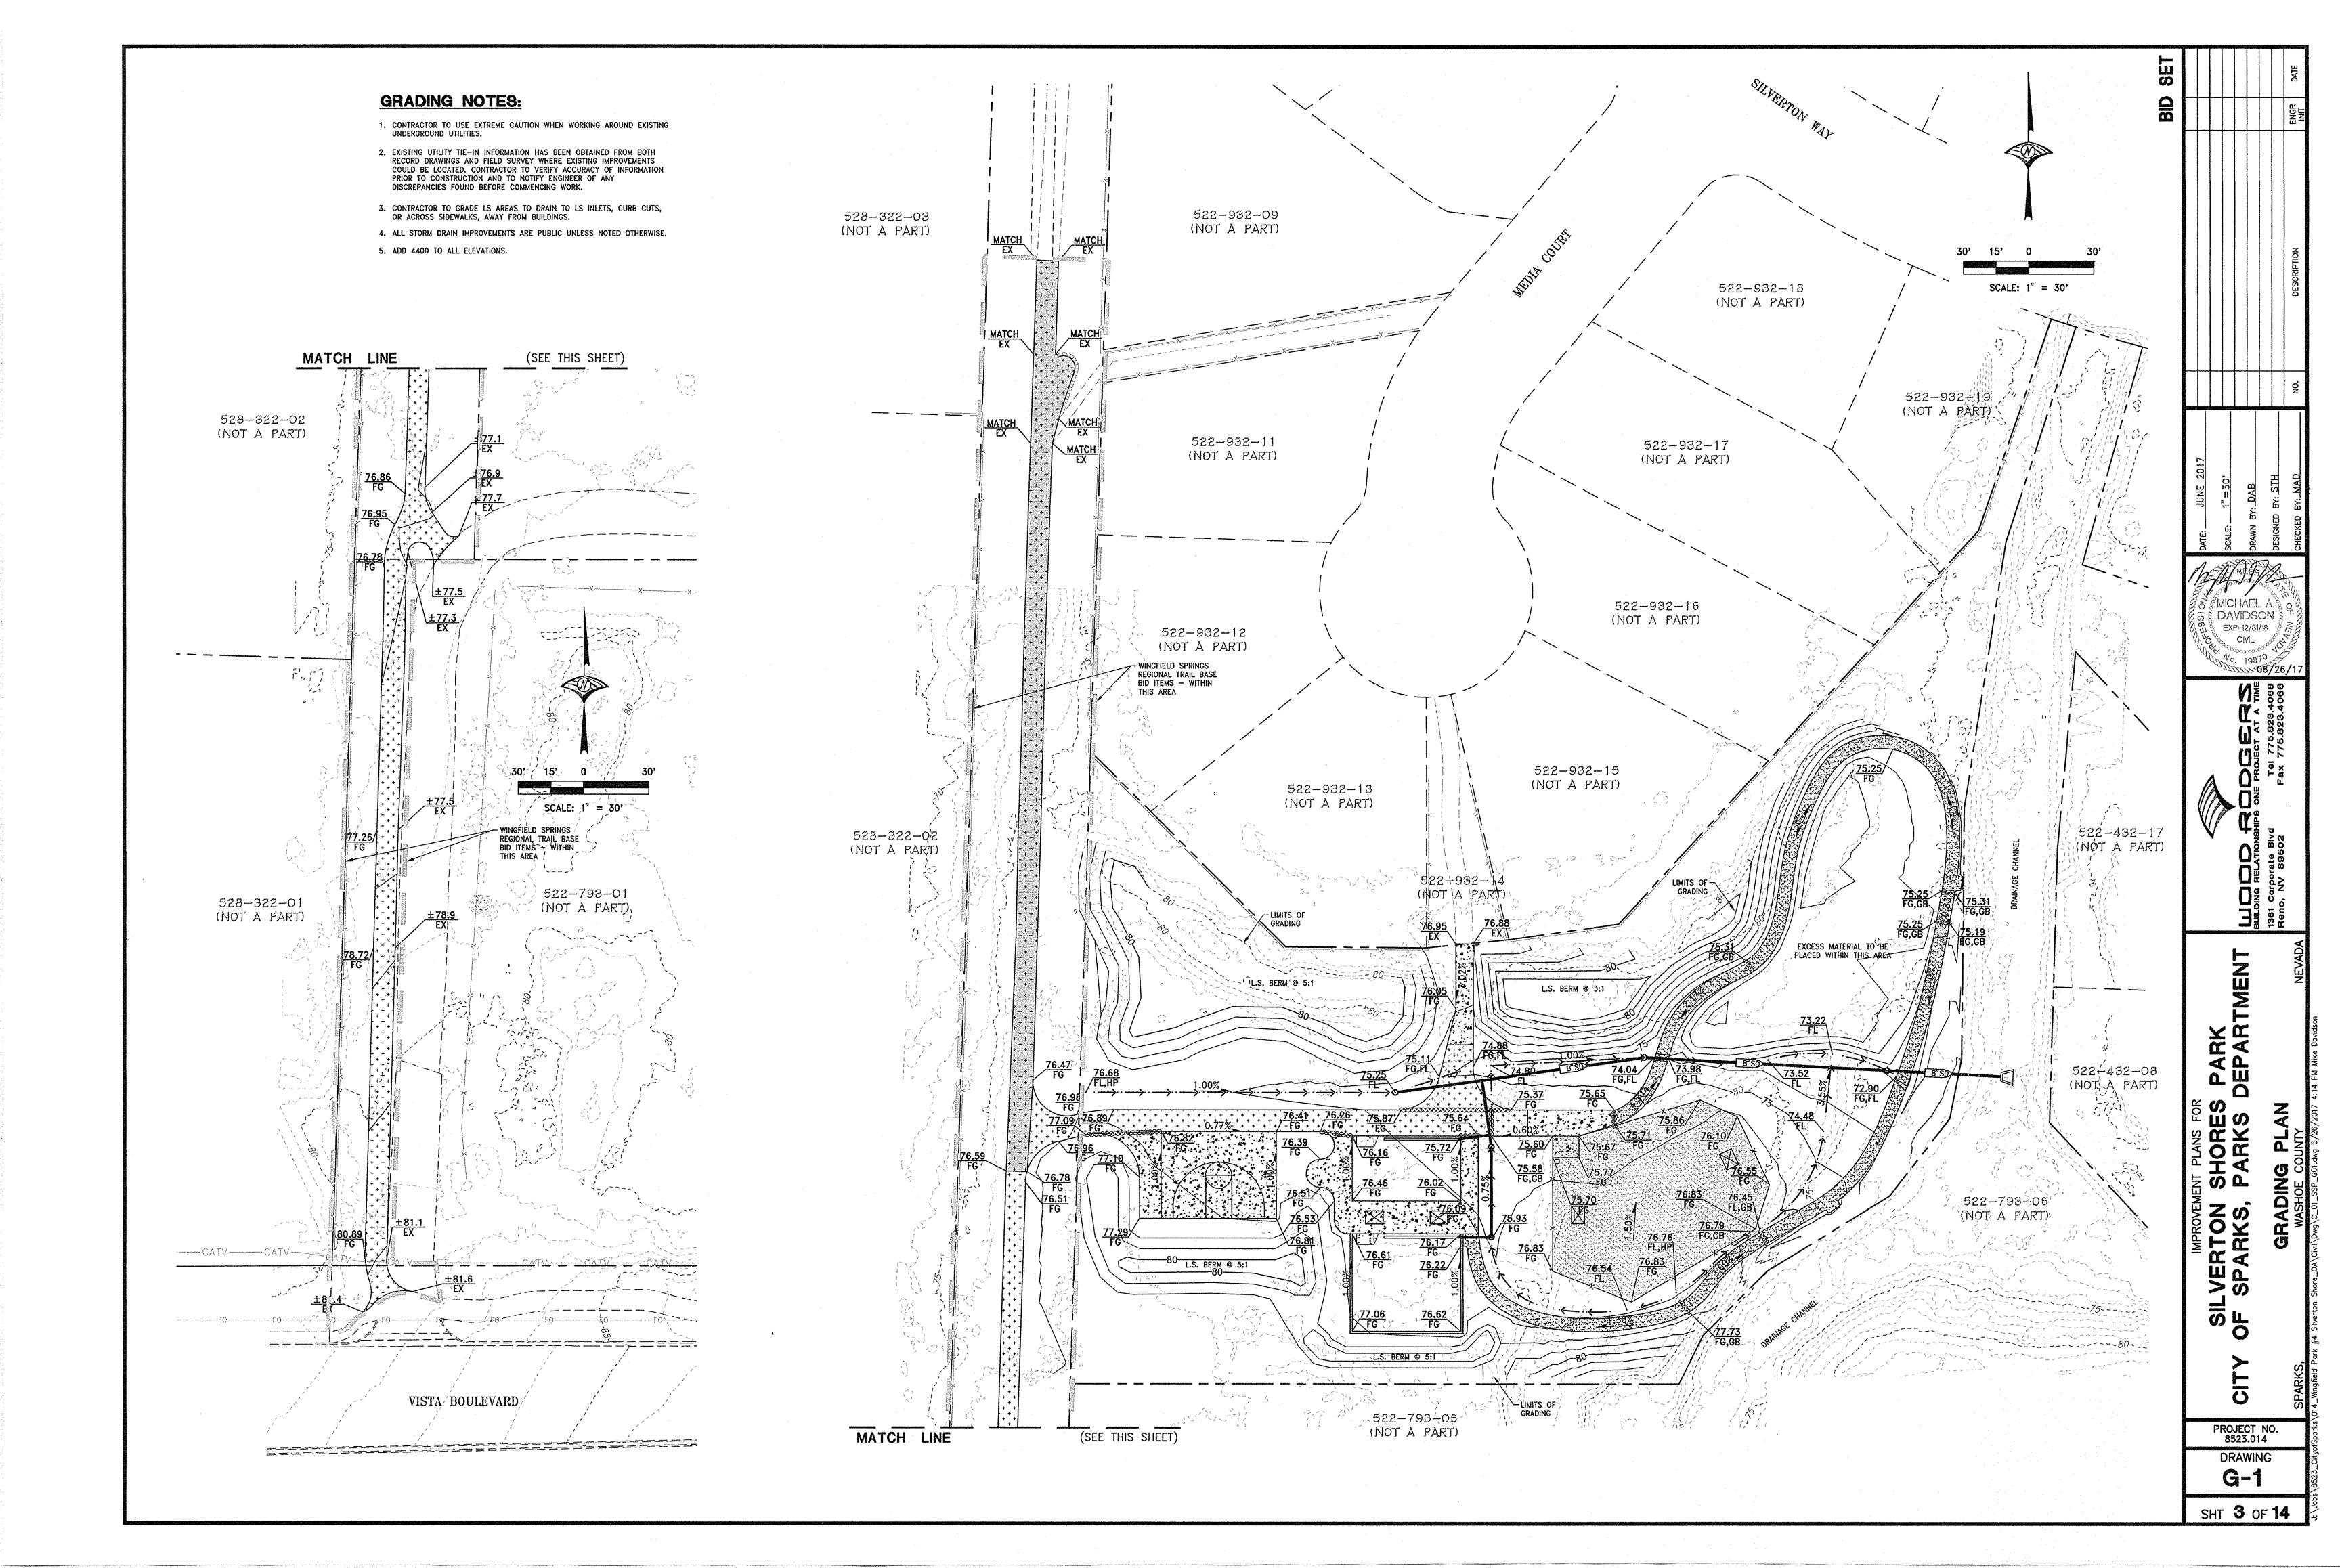

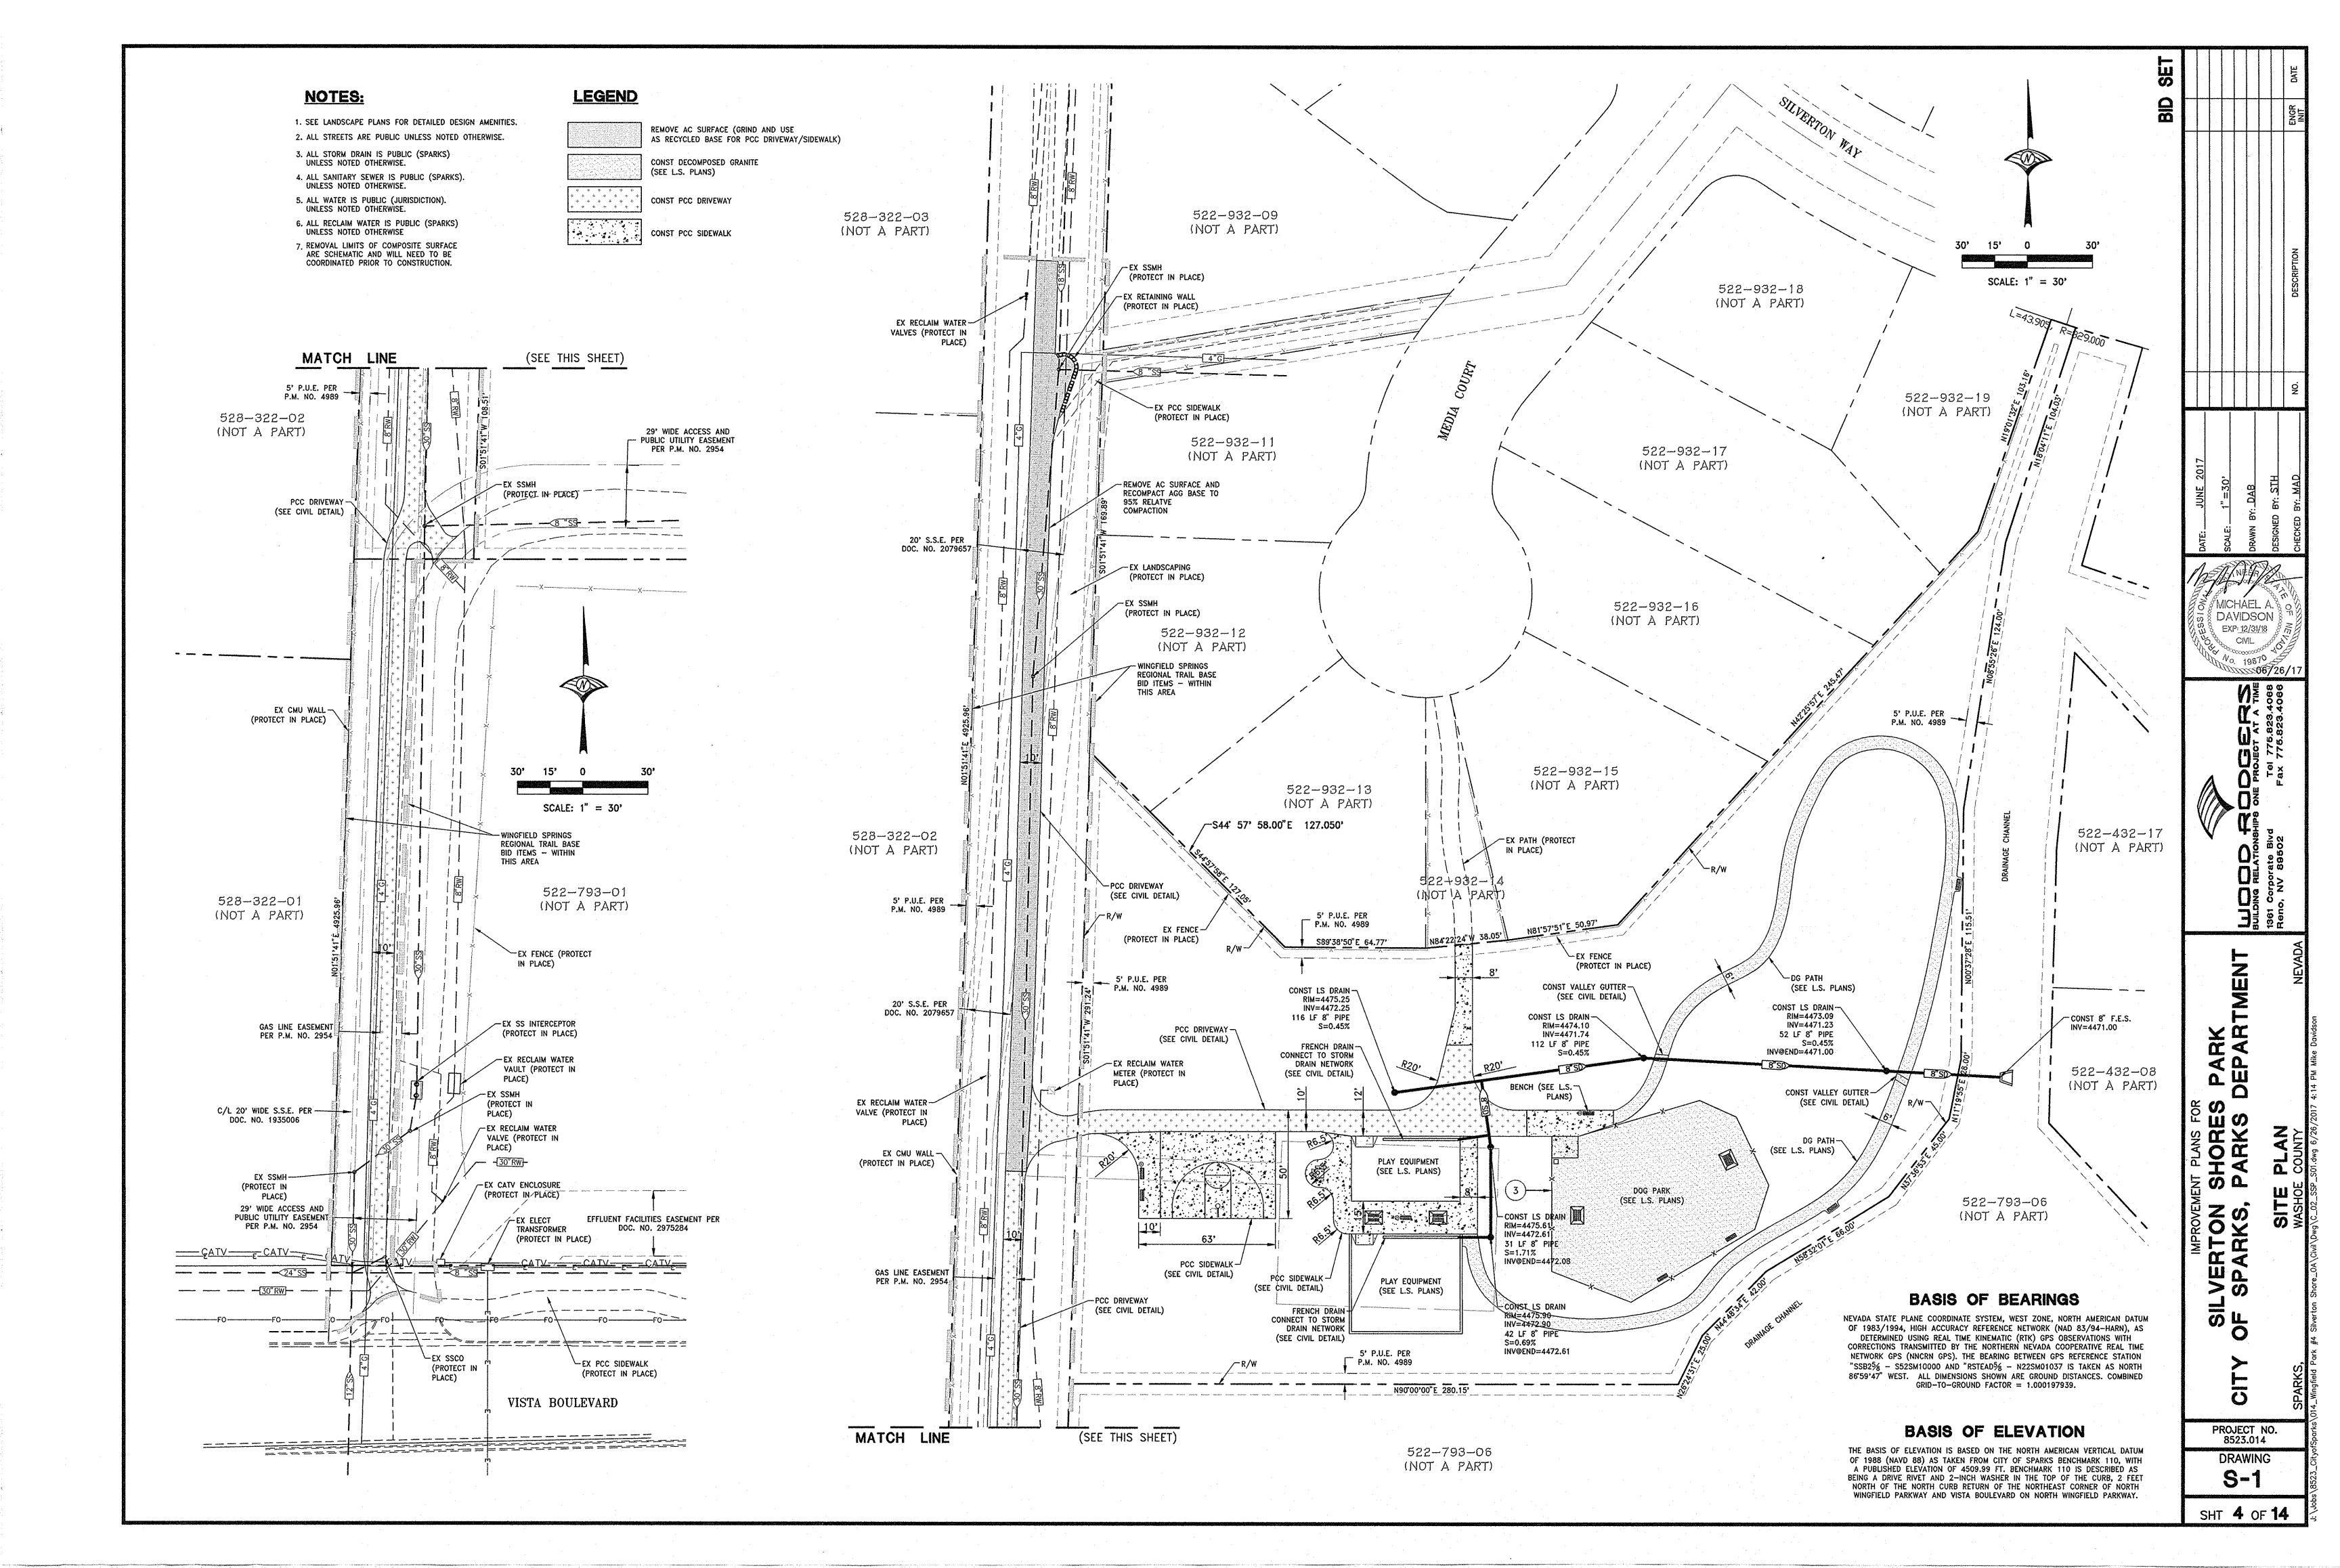

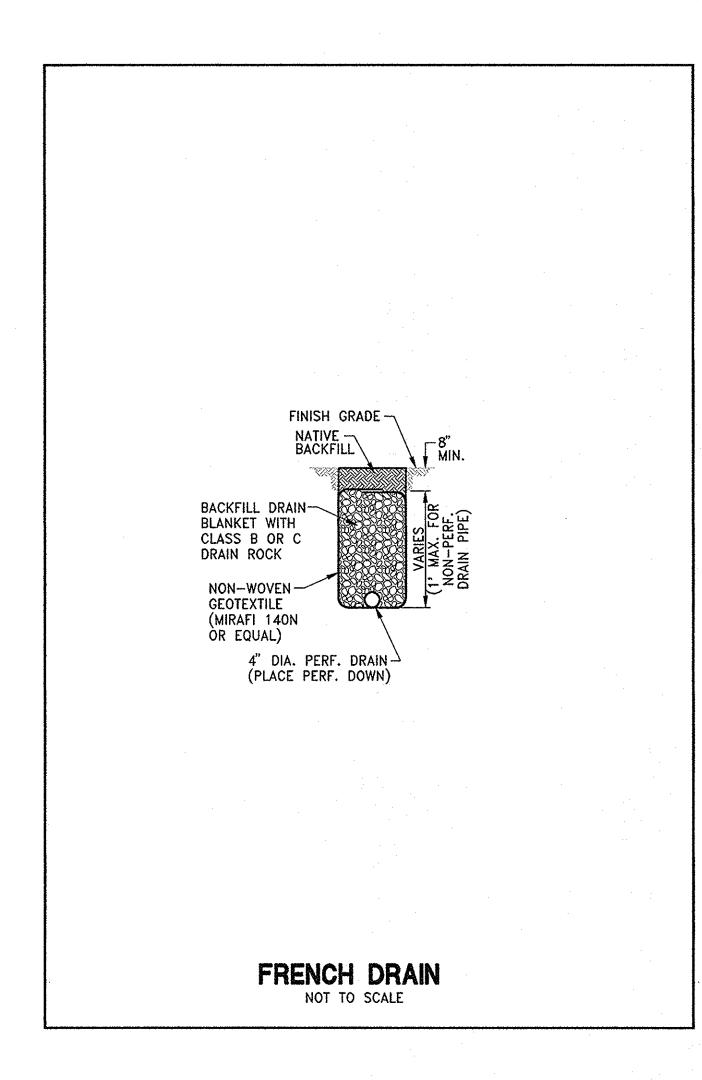

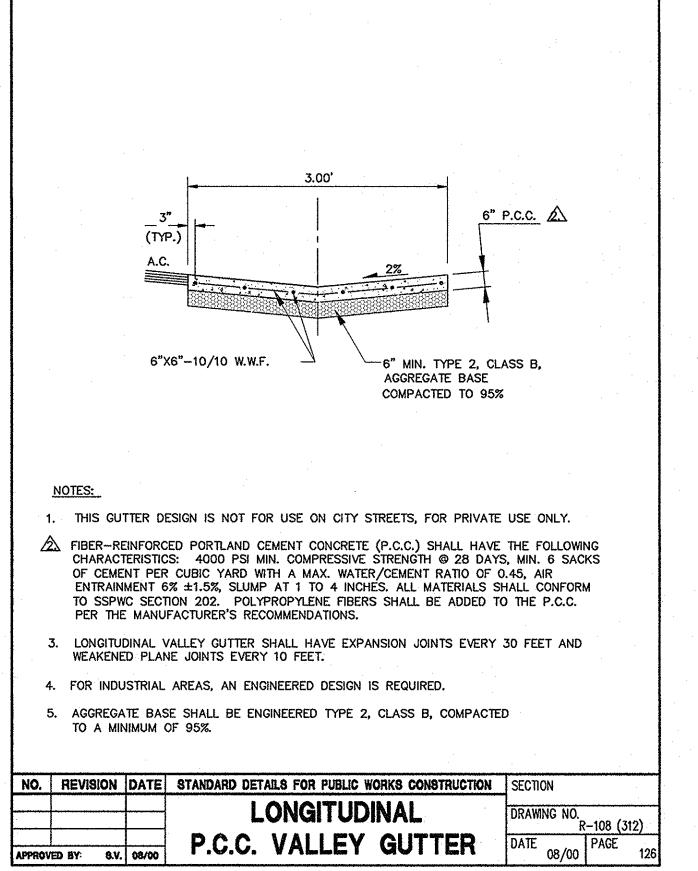

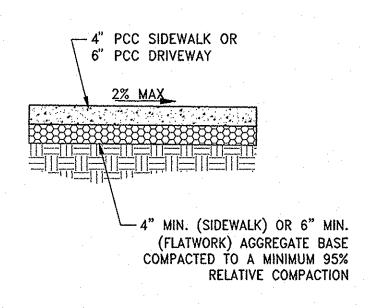


(BOLT DOWN)

- 1. FIBER-REINFORCED PORTLAND CEMENT CONCRETE (P.C.C.) SHALL HAVE THE FOLLOWING CHARACTERISTICS: 4000 PSI MIN. COMPRESSIVE STRENGTH AT 28 DAYS, MIN. 6 SACKS OF CEMENT PER CUBIC YARD WITH MAX. WATER-CEMENT RATIO OF 0.45, AIR ENTRAINMENT 6% ±1.5%, SLUMP AT 1 TO 4 INCHES. MIX DESIGN SHALL CONFORM TO THE REQUIREMENTS OF SECTION 337 OF STANDARD SPECIFICATIONS OF PUBLIC WORKS CONSTRUCTION (SSPWC). CEMENT SHALL BE TYPE II. ALL CEMENT CONCRETE SHALL HAVE A COARSE AGGREGATE GRADATION CONFORMING TO SIZE No. 67. POLYPROPYLENE OR CELLULOSE FIBERS SHALL BE ADDED TO THE P.C.C. AT 1.5 LBS. PER CUBIC YARD. ALL MATERIALS SHALL CONFORM TO SSPWC.
- 2. AGGREGATE BASE MATERIAL UNDER DRIVEWAYS AND SIDEWALKS SHALL BE TYPE 2, CLASS B CRUSHED AGGREGATE BASE. ALL MATERIALS SHALL CONFORM TO SSPWC SECTION 200.
- 3. PCC DRIVEWAYS TO HAVE #4 BARS AT 18" ON CENTER LONGITUDINALLY & TRANSVERSE. MINIMUM 2" CONCRETE COVER FOR ALL REINFORCING BARS.
- 4. ALL ADJACENT CONCRETE REMOVAL SHALL BE TO NEAT SAW CUT LINES AT RIGHT ANGLES. DOWEL INTO EXISTING ADJACENT CONCRETE DRIVEWAY OR SIDEWALK WITH (2) No. 4 REINFORCEMENT BARS EQUALLY SPACED ACROSS WIDTH "W". DOWELS SHALL PENETRATE A MINIMUM OF 4" INTO EXISTING CONCRETE.
- 5. WEAKENED PLANE JOINTS SHALL BE CONSTRUCTED AT 5 FT INTERVALS AND IN ACCORDANCE WITH SECTION 312 OF THE SSPWC.

PCC DRIVEWAY/SIDEWALK

NOT TO SCALE

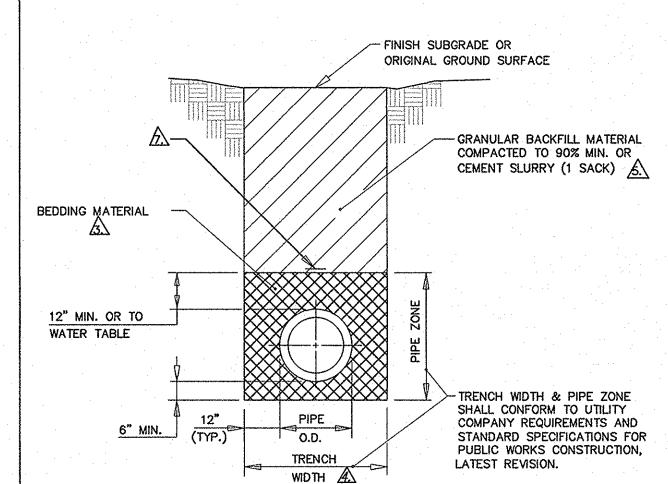

1. A PERMIT MUST BE OBTAINED FROM THE CITY ENGINEER PRIOR TO CUTTING ANY PUBLIC RIGHT-OF-WAY. 24 HOURS PRIOR TO TRENCH EXCAVATION, THE PERMITTEE MUST NOTIFY THE CITY EXCAVATION PERMIT INSPECTOR OR APPLICABLE ENGINEER OF RECORD. SEE RELATED STANDARD DETAIL DRAWING NOS. R-103 (141), R-204 (306), R-119 (312), R-120 (305.320) AND R-121 (305.320).

2. ALL MATERIALS AND INSTALLATION PROCEDURES SHALL BE IN ACCORDANCE WITH STANDARD SPECIFICATIONS FOR PUBLIC WORKS CONSTRUCTION, LATEST REVISION.

BEDDING MATERIAL SHALL CONFORM TO OWNING-UTILITY COMPANY REQUIREMENTS AS

APPROVED BY THE CITY OF RENO. FOR CITY-OWNED UTILITIES, BEDDING MATERIAL SHALL BE CLASS "A", "B", OR "C", COMPACTED TO 90% MINIMUM. FOR TRAFFIC/ELECTRICAL CONDUIT TRENCHES LESS THAN 12" IN WIDTH, INCLUDING VERMIER TRENCHES, BEDDING SHALL BE CLASS "A" MATERIAL. BACKFILL SHALL BE CEMENT SLURRY (ONE SACK). CEMENT SLURRY BEDDING/BACKFILL MAY BE USED AS AN ALTERNATE TO CLASS "A", "B" OR "C" MATERIAL WITH WRITTEN APPROVAL FROM THE CITY ENGINEER FOR EACH SPECIFIC

ALL EXCAVATIONS SHALL CONFORM TO THE LATEST O.S.H.A. REQUIREMENTS. SHORING OR SLOPED CUT MAY BE NECESSARY, BUT THERE WILL BE NO PAYMENT FOR ADDITIONAL


5 SEE STANDARD DETAIL DRAWING NOS. R-123A (305), R-123B (305) AND R-123C (305) FOR TRENCH SLURRY BACKFILL SPECIFICATIONS. 6. EDGE OF 4" ROCK WHEEL TRENCHES FOR CONDUIT SHALL BE LOCATED A MINIMUM OF

9" FROM GUTTER LIP.

APIPE TAPE IDENTIFICATION OF UTILITY SHALL BE INSTALLED.


EXCAVATION, BEDDING, BACKFILL, OR SHORING.

۲.	<u> </u>	· IDENTII	TOTALLE DE MASTALLE.	
NO.	REVISION	DATE	STANDARD DETAILS FOR PUBLIC WORKS CONSTRUCTION	SECTION
			TRENCH	DRAWING NO.
APPRO	VED BY: 8.V.	08/00	EXCAVATION / BACKFILL	DATE 08/00 PAGE 26

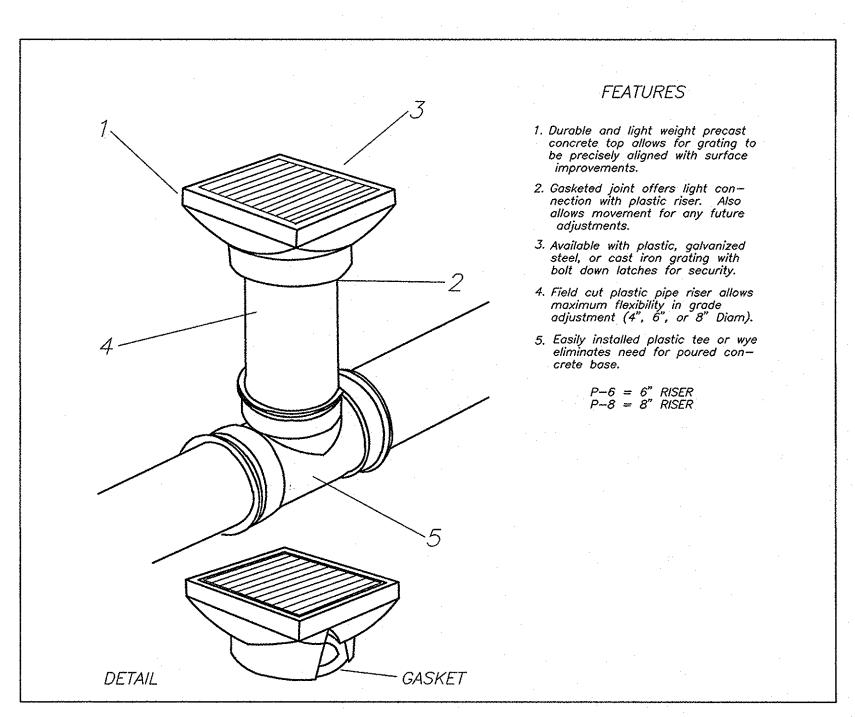


INLET NOTES:

- 1. P6 AND P8 REFERS TO THE SIZE OF THE RISER TUBE. P6 EQUALS 6" RISER AND P8 EQUALS 8" RISER. 2. ALL GRATES ARE 12" X 12". EITHER PLASTIC, GALVANIZED STEEL OR CAST IRON. GRATES SHALL BE BOLT DOWN TYPES.
- 3. MANUFACTURER BY PHOENIX OR EQUAL.
- 4. INSTALLATION SHALL BE BY ONE OF THE ABOVE METHODS.

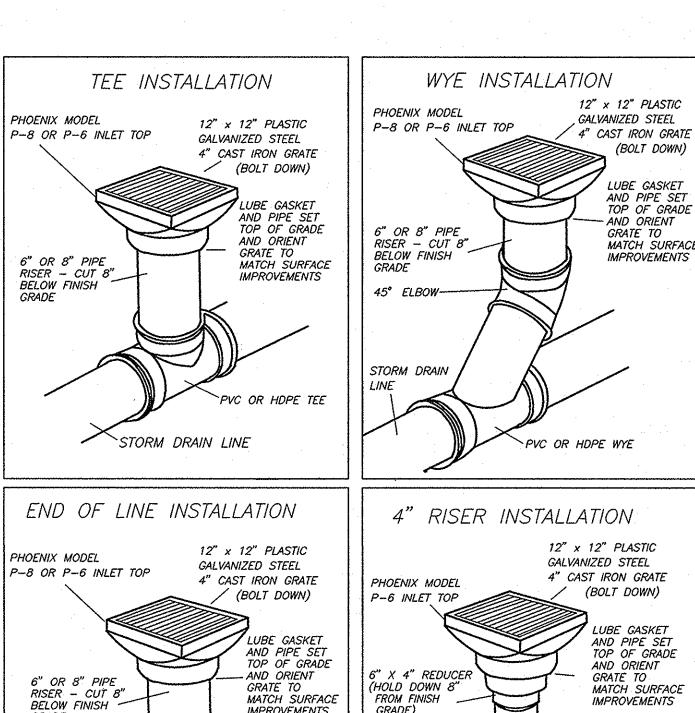

STORM DRAIN LINE


YARD DRAIN NOT TO SCALE

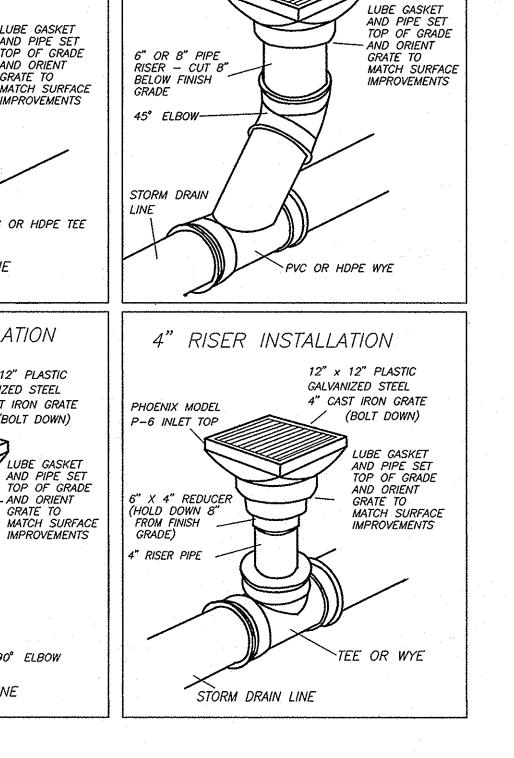


MICHAEL A. & DAVIDSON EXP: 12/31/18 CIVIL 19870 XXXXX06/26/1 田田の SHORI M CA FATON PARKS, CIVIL > 0

> PROJECT NO. 8523.014 DRAWING

SHT 5 OF 14

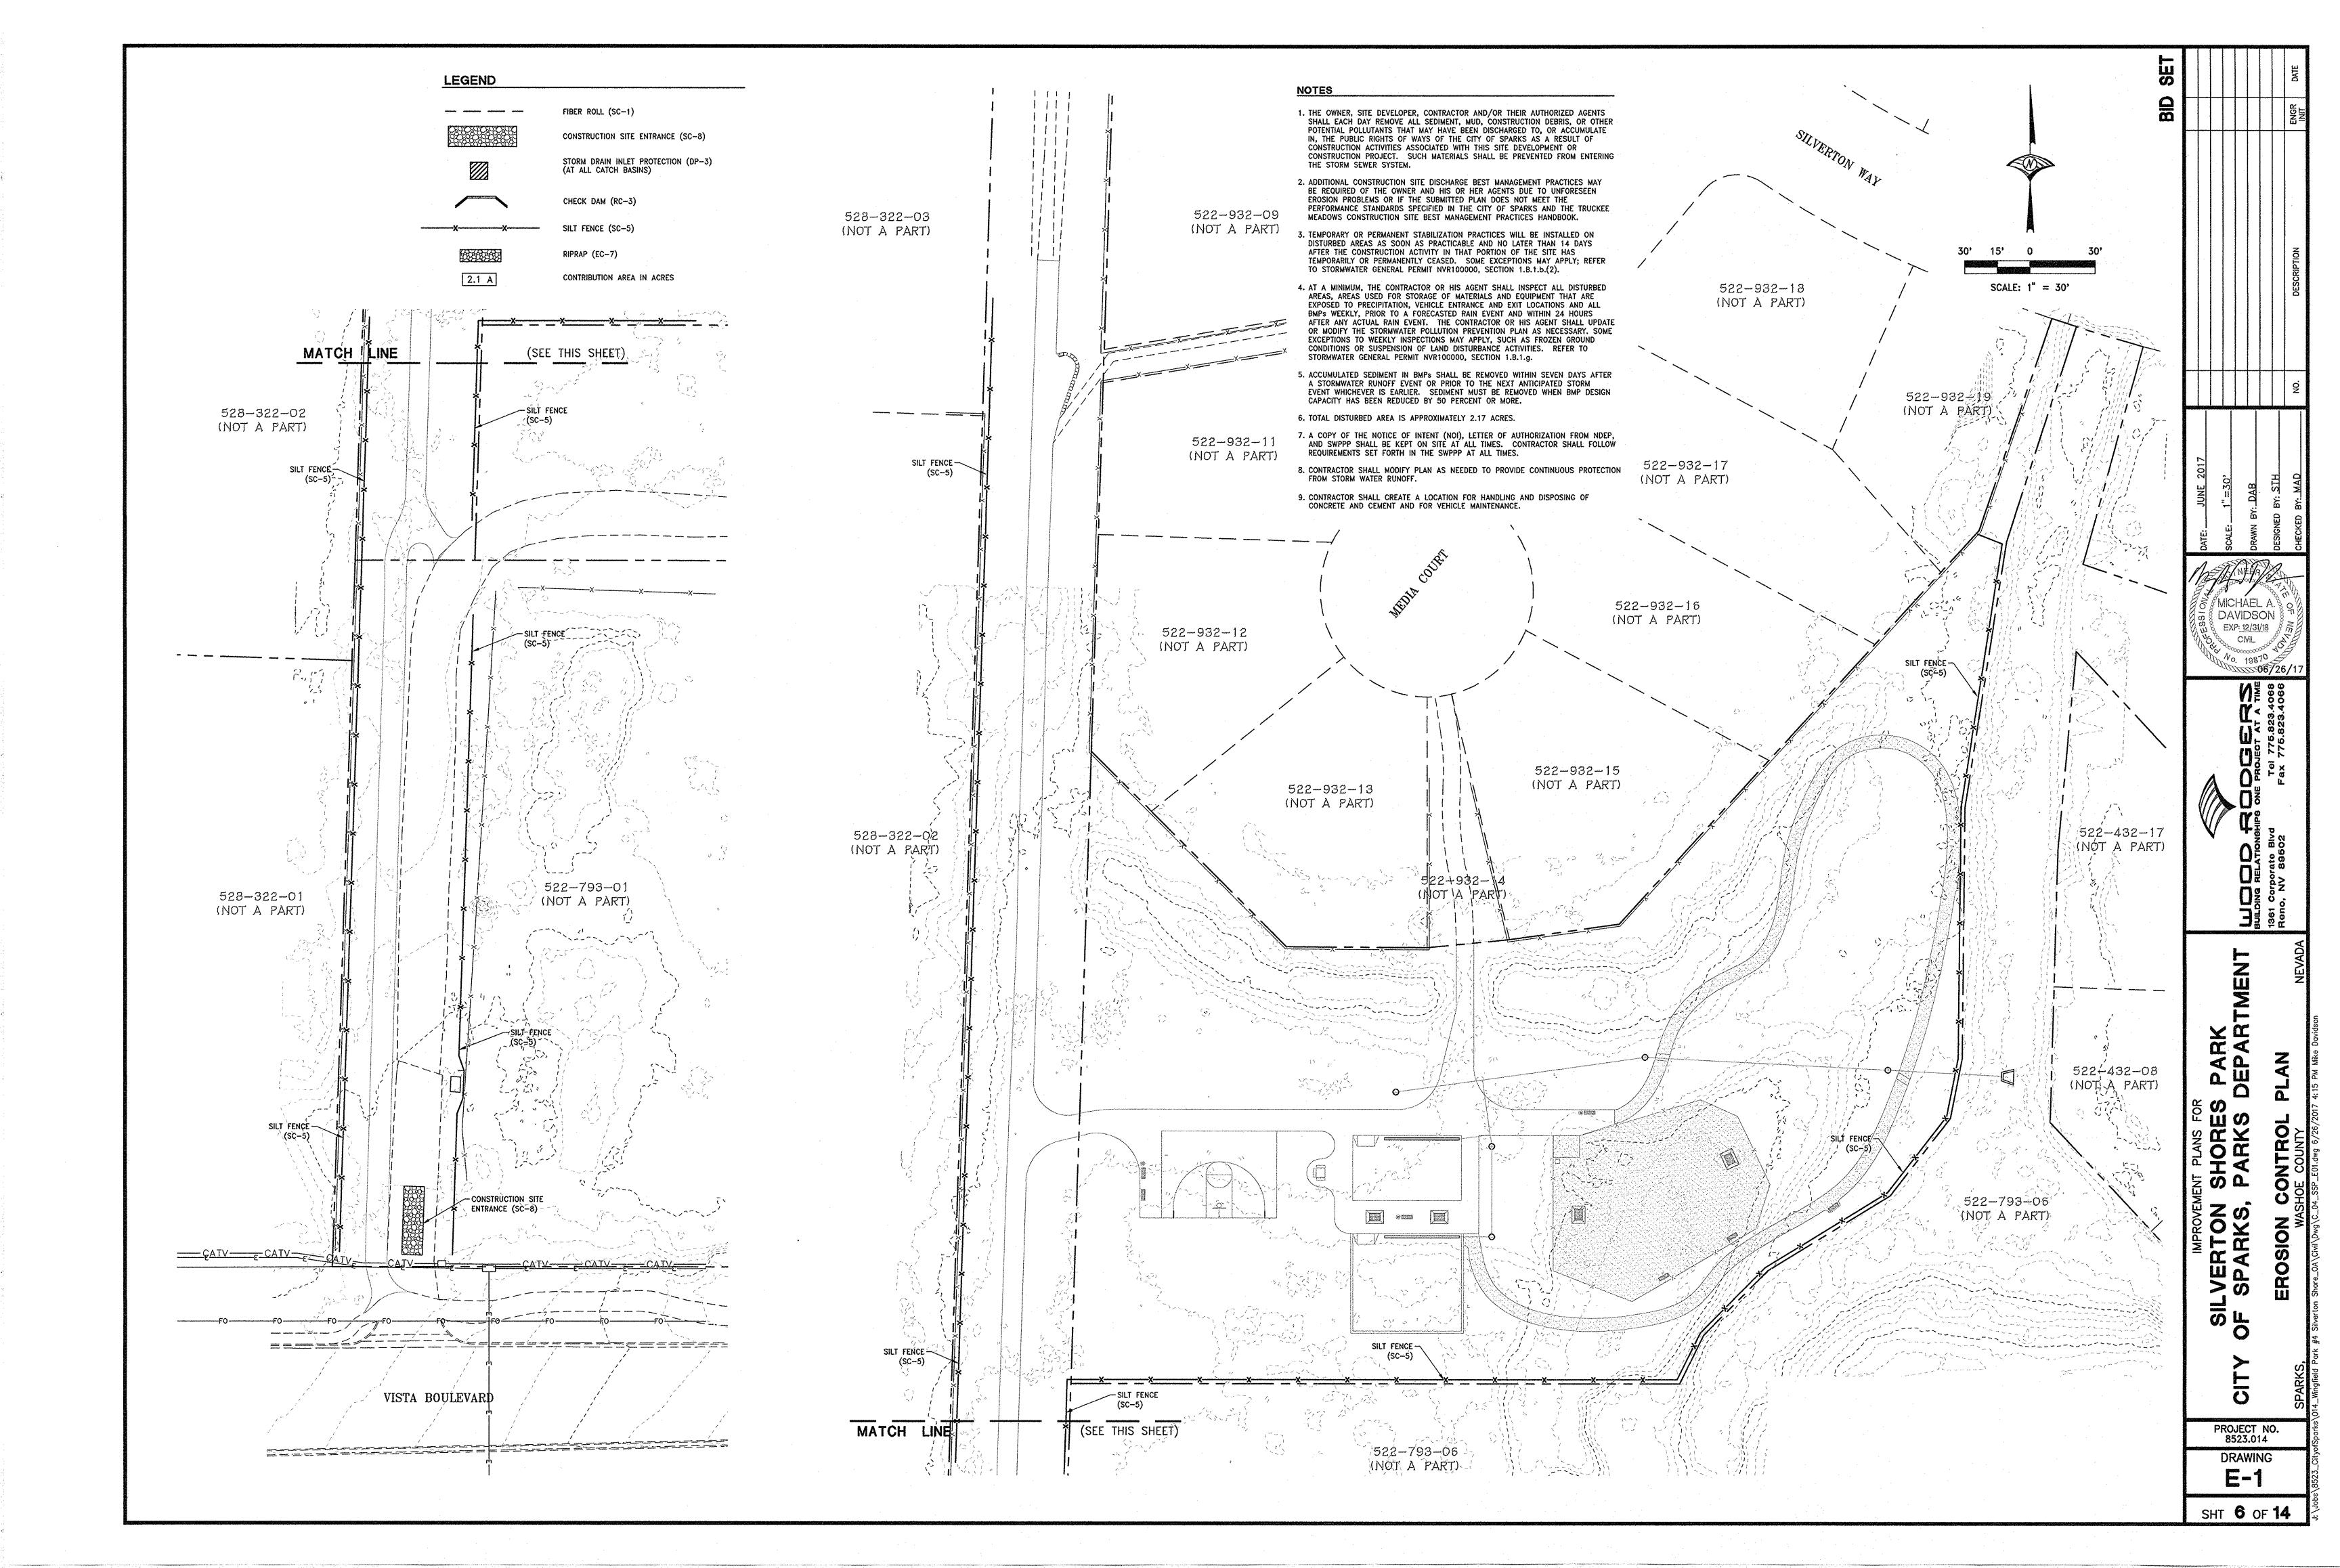

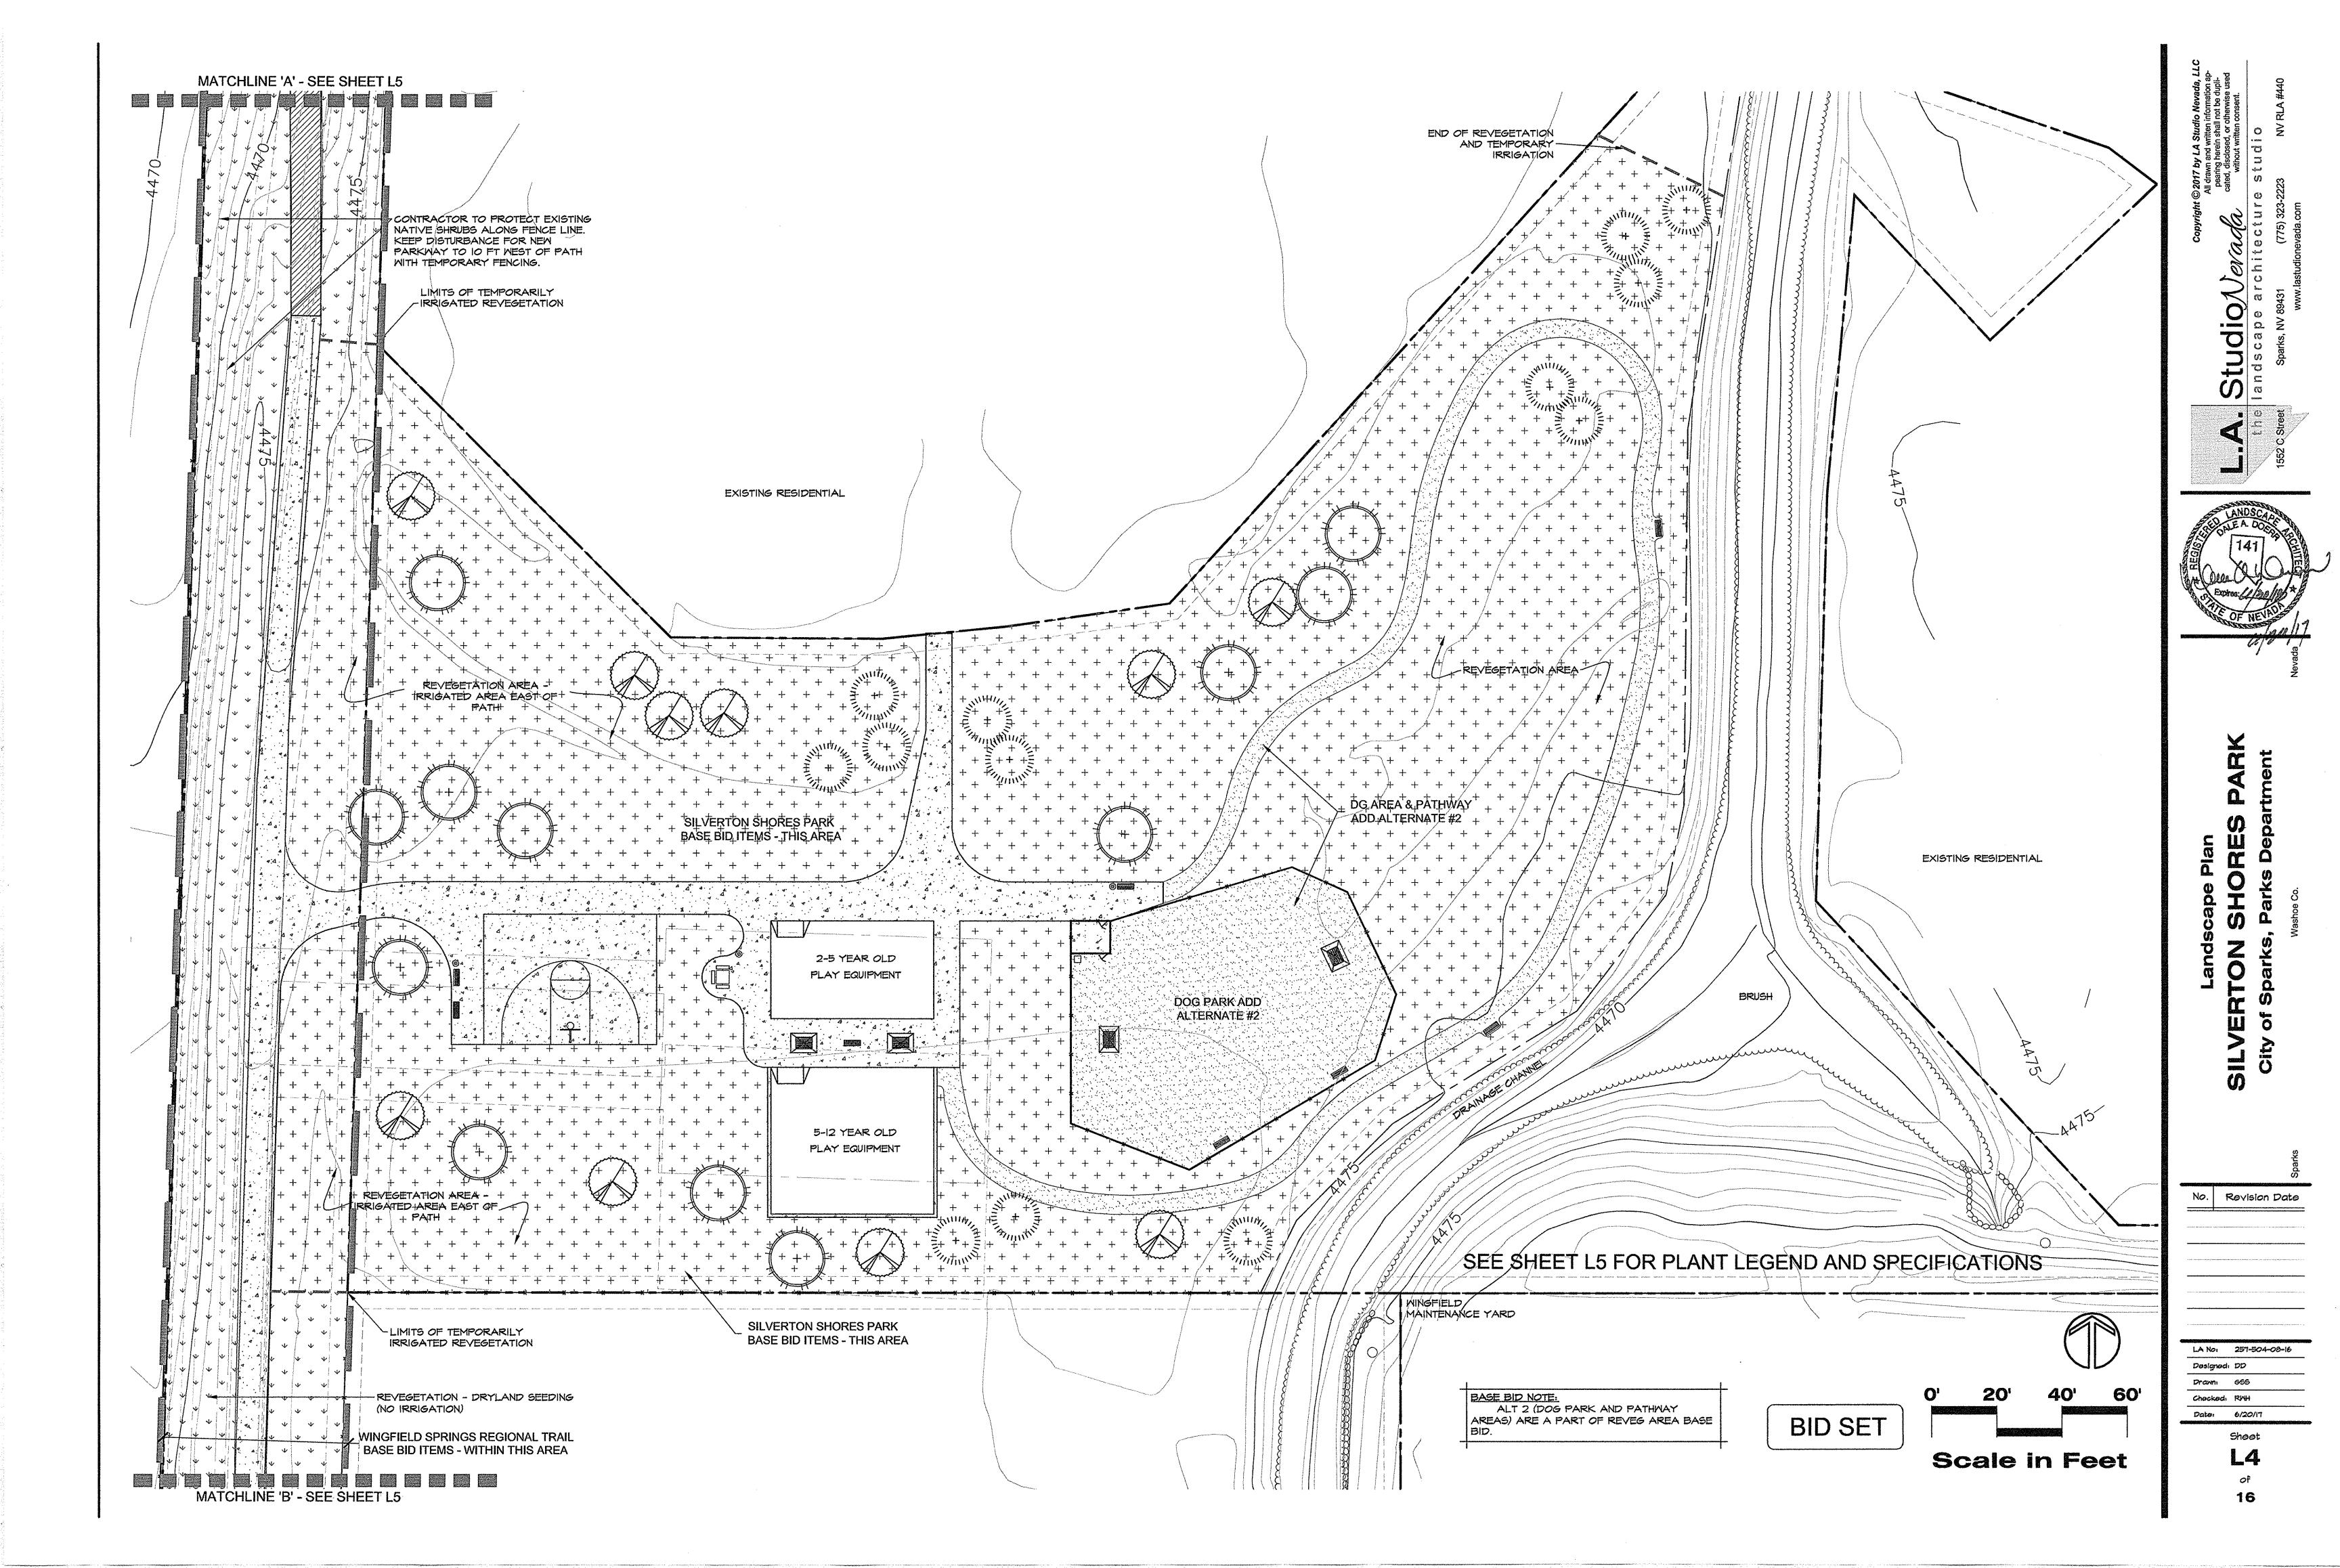

PLANT LIST

EVERGREEN TREES

CALOCEDRUS DECURRENS/INCENSE CEDAR

BY MIN. HT.

PINUS JEFFREYII/JEFFREY PINE

BY MIN. HT.

PINUS PONDEROSA/PONDEROSA PINE

BY MIN. HT.

REVEGETATION SEED BLEND

DRYLAND NON-IRRIGATED SEEDING - INSTALL PER SPECIFICATIONS.

TEMPORARY IRRIGATED SEEDING - INSTALL PER SPECIFICATIONS.

SPECIES CONTROL		PLS #/ACRE
GRASSES WHEATGRASS STREAMBANK	SODAR	4.00
BLUEGRASS SANDBERG	YNS	3.00
WILDRYE GREAT BASIN	YNS	2.00
FESCUE SHEEP	COVAR	3.00
INDIAN RICEGRASS	VNS	5.00
SHRUBS		
SAGEBRUSH WYOMING		.50
RABBITBRUSH RUBBER	•	.50
SALTBUSH FOURWING		2.00
MORMON TEA GREEN		.50
BITTERBRUSH		1.00
SPINY HOPSAGE		.50
DESERT PEACH		1.00
FLONERS		
DRYLAND AGGRESSIVE BLEND	*.	2.00
NURSE CROP		
RYEGRASS ANNUAL	VNS	6.00
TOTAL PL	31.00	

SEED AVAILABLE FROM: COMSTOCK SEED 917 HIGHWAY 88 GARDNERVILLE, NV. 89410 775-265-0090

SEEDING SPECIFICATIONS

- I. STRIP AND STOCKPILE EXISTING 6" OF NATIVE TOPSOIL. PROVIDE DUST CONTROL FOR STOCKPILED TOPSOIL AS REQUIRED BY REGULATORY AGENCIES.
- 2. FOLLOWING COMPLETION OF ROUGH GRADING, RE-APPLY A MINIMUM OF 4" OF STOCKPILED TOPSOIL TO REVEGETATION AREAS. SCARIFY TOPSOIL AS NEEDED TO CREATE FRIABLE CONDITIONS.
- 3. INSTALL NATIVE SHRUB PLUGS OR SUPER CELLS AT DENSITIES SPECIFIED BELOW IN #6.
- 4. HYDROSEED THE PREPARED SLOPES WITH A SLURRY MIX CONSISTING OF THE FOLLOWING:

FERTILIZER: O-IO-IO @ 200 LBS PER ACRE
TACKIFIER: PLAS-TEX SOIL STABILIZER (OAE) @ 2 TONS PER ACRE
MULCH: 10% FIBER/30% PAPER MULCH BLEND @ I TON PER ACRE
REVEGETATION SEED BLEND AT 31 LBS PER ACRE

- 5. PROVIDE MINIMUM OF 50% IRRIGATION COVERAGE TO ALL REVEGETATED AREAS UNTIL REVEGETATION IS ESTABLISHED TO A MINIMUM OF 80% GROUND COVERAGE (A MINIMUM OF ONE FULL GROWING SEASON). ALL IRRIGATION SHALL REMAIN IN PLACE AND IN GOOD OPERATING CONDITION UNTIL RECEIPT OF FINAL WRITTEN APPROVAL OF THE AREAS FROM THE REVIEW AGENCY.
- 6. ALL TEMPORARY IRRIGATION WILL BE OPERATED BY AUTOMATIC ELECTRIC CONTROL VALVES AND WIRED TO THE CONTROLLER.
- 7. SET IRRIGATION SCHEDULE AS NEEDED TO MAINTAIN MOIST SOIL SURFACE CONDITIONS DURING GERMINATION AND ESTABLISHMENT. THE WATERING SCHEDULE SHALL INCLUDE SHORT, FREQUENT WATERING CYCLES CONDUCIVE TO CREATING A MOIST SOIL SURFACE WHILE MINIMIZING ANY SURFACE RUNOFF OR RILLS.
- 8. REPAIR ANY SURFACE EROSION/RILLS UPON DISCOVERY.

SHRUB PLUGS SPECIES:

SHRUB FLUGS SFLOILS:	PLUGS/ACRE
A. WYOMING BIG SAGEBRUSH	50/ACRE
B. FOURWING SALTBUSH	25/ACRE
C. ANTELOPE BITTERBRUSH	25/ACRE
D. RABBIT BRUSH	
E. SPINY HOPSAGE	25 ACRE
	175 PLUGS/ACRE

SCATTER PLUGS THROUGHOUT THE SEEDED AREA WHEN PLANTING.

LANDSCAPE SPECIFICATIONS

GENERA

I. PLAN IS DIAGRAMMATIC ONLY. ALL LOCAL GOVERNING CODES SHALL BE MET. EXACT LOCATION OF TREES AND SHRUBS SHALL BE DETERMINED IN THE FIELD (INSTALL AS PER DETAILS) AND APPROVED BY THE OWNER'S REPRESENTATIVE.

2. A MINIMUM OF TWO WORKING DAYS BEFORE PERFORMING ANY DIGGING, CALL UNDERGROUND SERVICE ALERT FOR INFORMATION ON THE LOCATION OF NATURAL GAS LINES, ELECTRIC CABLES, TELEPHONE CABLES, ETC. THE CONTRACTOR SHALL BE RESPONSIBLE FOR LOCATION AND PROTECTION OF ALL UTILITIES, AND REPAIR OF ANY DAMAGE RESULTING FROM HIS WORK AT NO ADDITIONAL COST TO THE OWNER.

3. DAMAGES: CONTRACTOR SHALL PROMPTLY REPAIR ALL DAMAGES TO EXISTING SITE AT NO COST TO CUINER

4. CONTRACTOR SHALL COORDINATE ALL WORK WITH OTHER TRADES (I.E., PAVING, PLUMBING, ELECTRICAL,

5. THE CONTRACTOR SHALL BE RESPONSIBLE TO FIELD VERIFY SITE CONDITIONS PRIOR TO CONSTRUCTION AND TO NOTIFY THE OWNER'S REPRESENTATIVE SHOULD CONDITIONS EXIST WHICH PREVENT CONSTRUCTION AS PER THESE PLANS. COMMENCEMENT OF WORK SHALL CONSTITUTE ACCEPTANCE OF CONDITIONS AND

6. CONTRACTOR AGREES THAT, IN ACCORDANCE WITH GENERALLY ACCEPTED CONSTRUCTION PRACTICES, CONTRACTOR ASSUMES SOLE AND COMPLETE RESPONSIBILITY FOR JOB SITE CONDITIONS DURING THE COURSE OF CONSTRUCTION OF THE PROJECT, INCLUDING SAFETY OF ALL PERSONS AND PROPERTY, THAT THIS REQUIREMENT SHALL BE MADE TO APPLY CONTINUOUSLY AND SHALL NOT BE LIMITED TO NORMAL WORKING HOURS AND CONTRACTOR FURTHER AGREES TO DEFEND, INDEMNIFY AND HOLD HARMLESS THE OWNER FROM ANY AND ALL LIABILITY, REAL OR ALLEGED, IN CONNECTION WITH THE PERFORMANCE OF WORK ON THE PROJECT.

PLANTING

7. THE CONTRACTOR SHALL BE RESPONSIBLE FOR FINISH GRADING THROUGHOUT ALL LANDSCAPE AREAS SUCH THAT THERE ARE NO HUMPS OR DEPRESSIONS AND POSITIVE DRAINAGE OCCURS THROUGHOUT.

8. THE CONTRACTOR SHALL PROVIDE SOIL TEST RESULTS FOR EXISTING SITE SOIL INCLUDING: TEXTURE CLASSIFICATION, PH, NITROGEN, POTASSIUM, PHOSPHORUS, SODIUM HAZARD, SALINITY HAZARD, AND FERTILIZATION RECOMMENDATION FOR THE INTENDED USE. CONTRACTOR SHALL FOLLOW RECOMMENDATIONS OF SOIL TEST.

9. INSTALL ALL PLANT MATERIALS AS PER DETAILS AND SOIL AND PLANT LAB REPORT. INFORMATION IN SOILS AND PLANT LAB REPORT SHALL PREVAIL OVER NOTES AND DETAILS.

10. SOIL AMENDMENT SHALL BE HUMUS COMPOSED OF TOPSOIL, BARK HUMUS, AND COMPOST. SUBMIT TO OUNER'S REPRESENTATIVE FOR APPROVAL.

II. CONTRACTOR IS RESPONSIBLE FOR PROVIDING PLANT MATERIAL PER SYMBOLS AND SPACING INDICATED ON PLAN. SYMBOLS PREVAIL OVER NUMBERS ON PLANT LIST. NO SUBSTITUTIONS WILL BE ACCEPTED WITHOUT EXPRESSED WRITTEN CONSENT OF THE OWNER'S REPRESENTATIVE. SEE SUBMITTALS.

12. ALL PLANTS NOT MEETING OR EXCEEDING REQUIREMENTS AND RECOMMENDATIONS OF THE LATEST EDITION OF THE ANSI ZGO.1 "AMERICAN STANDARD FOR NURSERY STOCK" BY THE AMERICAN ASSOCIATION OF NURSERYMEN SHALL BE REJECTED. CONTRACTOR SHALL RECEIVE ON-SITE APPROVAL OF PLANT MATERIAL BY OWNER'S REPRESENTATIVE PRIOR TO PLANTING. FAILURE TO RECEIVE PRIOR APPROVAL MAY RESULT IN REJECTION OF PLANT MATERIAL FOLLOWING INSTALLATION. THE OWNER'S REPRESENTATIVE RESERVES THE RIGHT TO INSPECT AND EVALUATE PLANT MATERIAL THROUGHOUT THE CONSTRUCTION AND MAINTENANCE

13. ALL PLANTING BEDS SHALL RECEIVE TOP-DRESSING OF MULCH AS FOLLOWS:

- DECOMPOSED GRANITE (DG) INSTALL FOUR-INCH DEPTH OF 1/6" COARSE OXBORROW DG (OAE) DO NOT INSTALL WEED FABRIC UNDER DECOMPOSED GRANITE MULCH.
- DRAINAGE SWALES INSTALL FOUR-INCH DEPTH MINIMUM OF 12-INCHMINUS RIVER ROCK INSTALLED OVER LANDSCAPE FABRIC.
- GRANULAR PRE-EMERGENT FOLLOWING MULCH PLACEMENT, APPLY GRANULAR PRE-EMERGENT TO ALL DECOMPOSED GRANITE AREAS AND WATER IN BEFORE ROLLING.

EDGE DRAINS/SITE DRAINAGE

21. PRIOR TO CONSTRUCTION THE CONTRACTOR SHALL OBTAIN A COPY OF THE PROJECT GEOTECHNICAL REPORT. CONTRACTOR WILL INCORPORATE ALL SITE DRAINAGE AND PLANT PLACEMENT RECOMMENDATIONS PER THAT REPORT.

INSPECTIONS/APPROVALS/SUBMITTALS

22. CONTRACTOR IS RESPONSIBLE FOR NOTIFYING OWNER'S REPRESENTATIVE, A MINIMUM OF 48 HOURS IN ADVANCE, FOR THE FOLLOWING SITE OBSERVATIONS AND/OR MEETINGS:

- A. PRECONSTRUCTION MEETING WITH ALL PARTIES B. PLANT MATERIAL ON SITE, PRIOR TO INSTALLATION
- C. FINAL PROJECT WALK-THROUGH D. ADDITIONAL SITE OBSERVATIONS AS DEEMED NECESSARY BY THE OWNER'S REPRESENTATIVE
- 23. SUBMIT AMENDMENT AND MULCH SAMPLES TO OWNER'S REPRESENTATIVE FOR APPROVAL PRIOR TO INSTALLATION. FAILURE TO COMPLY MAY RESULT IN REJECTION OF MULCH OR AMENDMENT PRIOR TO OR
- INSTALLATION. FAILURE TO COMPLY MAY RESULT IN REJECTION OF MULCH OR AMENDMENT PRIOR TO FOLLOWING INSTALLATION.

 24. IT IS THE RESPONSIBILITY OF THE CONTRACTOR TO LOCATE AND PROVIDE PLANT MATERIAL AS
- SPECIFIED ON THIS PLAN. THE CONTRACTOR MAY SUBMIT A REQUEST TO PROVIDE SUBSTITUTIONS FOR THE SPECIFIED PLANT MATERIAL UNDER THE FOLLOWING CONDITIONS:

 A. ANY SUBSTITUTIONS PROPOSED SHALL BE SUBMITTED TO THE PROJECT OWNER'S REPRESENTATIVE WITHIN TWO WEEKS OF THE AWARD OF CONTRACT. SUBSTITUTIONS MUST MEET EQUIVALENT DESIGN AND FINCTIONAL GOALS OF THE ORIGINAL MATERIALS AS DETERMINED BY THE OWNER'S REPRESENTATIVE. ANY
- WITHIN TWO WEEKS OF THE AWARD OF CONTRACT. SUBSTITUTIONS MUST MEET EQUIVALENT DESIGN AND FUNCTIONAL GOALS OF THE ORIGINAL MATERIALS AS DETERMINED BY THE OWNER'S REPRESENTATIVE. ANY CHANGES MUST HAVE THE APPROVAL OF THE OWNER'S REPRESENTATIVE.

 B. THE REQUEST WILL BE ACCOMPANIED BY AT LEAST THREE NOTICES FROM PLANT MATERIAL SUPPLIERS THAT THE PLANT MATERIAL SPECIFIED IS NOT AVAILABLE AND WILL NOT BE AVAILABLE PRIOR TO CONSTRUCTION

25. SUBMIT REQUIRED SOIL REPORT, AND SAMPLE OF PROPOSED SOIL AMENDMENTS TO OWNER'S REPRESENTATIVE PRIOR TO INSTALLATION.


26. RECORD (AS-BUILT) DRAWINGS: FOLLOWING COMPLETION OF PROJECT INSTALLATION, AND PRIOR TO FINAL APPROVAL, CONTRACTOR SHALL PREPARE AND SUBMIT RECORD DRAWINGS DEPICTING A COMPLETE LANDSCAPE AND IRRIGATION INSTALLATION. PROCURE FROM OWNER FULL-SIZE SEPIAS OF CONTRACT DRAWINGS. CONSTRUCTION DRAWINGS SHALL BE ON THE PROJECT SITE AT ALL TIMES DURING INSTALLATION. CONTRACTOR SHALL MAKE A DAILY RECORD OF ALL WORK INSTALLED DURING EACH DAY. ACTUAL LOCATION OF TREES AND SHRUB BEDS, IRRIGATION VALVES, AND ALL IRRIGATION AND DRAINAGE PIPING SHALL BE SHOWN ON THE PRINTS BY DIMENSIONS FROM EASILY IDENTIFIED PERMANENT FEATURES, SUCH AS BUILDING, CURBS, FENCES, WALKS, OR PROPERTY LINES. DRAWINGS SHALL SHOW MANUFACTURER'S NAME AND CATALOG NUMBER. THE DRAWINGS SHALL BE TO SCALE. ALL INFORMATION NOTED ON THE PRINT SHALL BE TRANSFERRED TO THE COPIES BY CONTRACTOR AND ALL INDICATIONS SHALL BE RECORDED IN A NEAT, ORDERLY WAY. THE RECORD SEPIA SHALL BE TURNED OVER TO THE OWNER'S REPRESENTATIVE.

GUARANTEES/WARRANTY

27. ALL PLANTED AREAS SHALL BE MAINTAINED FOR A PERIOD OF SIXTY DAYS FOLLOWING WRITTEN ACCEPTANCE BY OWNER'S REPRESENTATIVE. LANDSCAPE CONTRACTOR WILL GUARANTEE ALL PLANT MATERIAL (INCLUDING BUT NOT LIMITED TO TREES, SHRUBS, GROUNDCOVER, AND GRASSES) FOR A PERIOD OF ONE FULL YEAR FOLLOWING FINAL ACCEPTANCE OF THE LANDSCAPE INSTALLATION BY THE OWNER'S AUTHORIZED REPRESENTATIVE. IN BIDDING AND INSTALLING THE PLANT MATERIAL SPECIFIED ON THESE PLANS, THE LANDSCAPE CONTRACTOR AGREES THAT THE PLANT MATERIAL SPECIFIED IS SUITABLE TO THE PROJECT SITE. FURTHERMORE, THE LANDSCAPE CONTRACTOR AGREES TO HONOR THE WARRANTY AND, IF NECESSARY, REPLACE SPECIES WITH A MORE HARDY PLANT TYPE IF DEEMED NECESSARY DUE TO EXCESSIVE DIE OUT. IF THE LANDSCAPE CONTRACTOR DOES NOT BELIEVE CERTAIN PLANT MATERIAL IS SUITABLE FOR THE SITE AND/OR ITS MICRO-CLIMATES, THE LANDSCAPE CONTRACTOR SHALL REQUEST TO MAKE PLANT MATERIAL SUBSTITUTIONS IN WRITING TO THE LANDSCAPE ARCHITECT PRIOR TO THE START OF INSTALLATION. PROPOSED SUBSTITUTIONS WILL RESULT IN NO ADDED COST.



BID SET

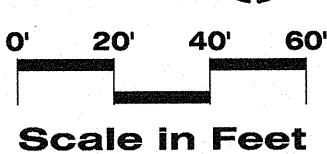


© 2017 by LA Studio Nevada, I All drawn and written information ap pearing herein shall not be duplicated, disclosed, or otherwise used

Copyright © 2017 by LA Studion of the studion of th

idio/Verada cape architectu arks, NV 89431 (775) 32

Studie I and s c a p

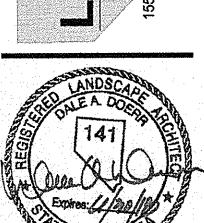

VERTON SHORES PARK by of Sparks, Parks Department

Revision Date

LA No: 251-504-08-16

Designed: DD


Drawn: 695

Date: 6/20/17 Sheet

Checked: RWH

L5 of

of 16

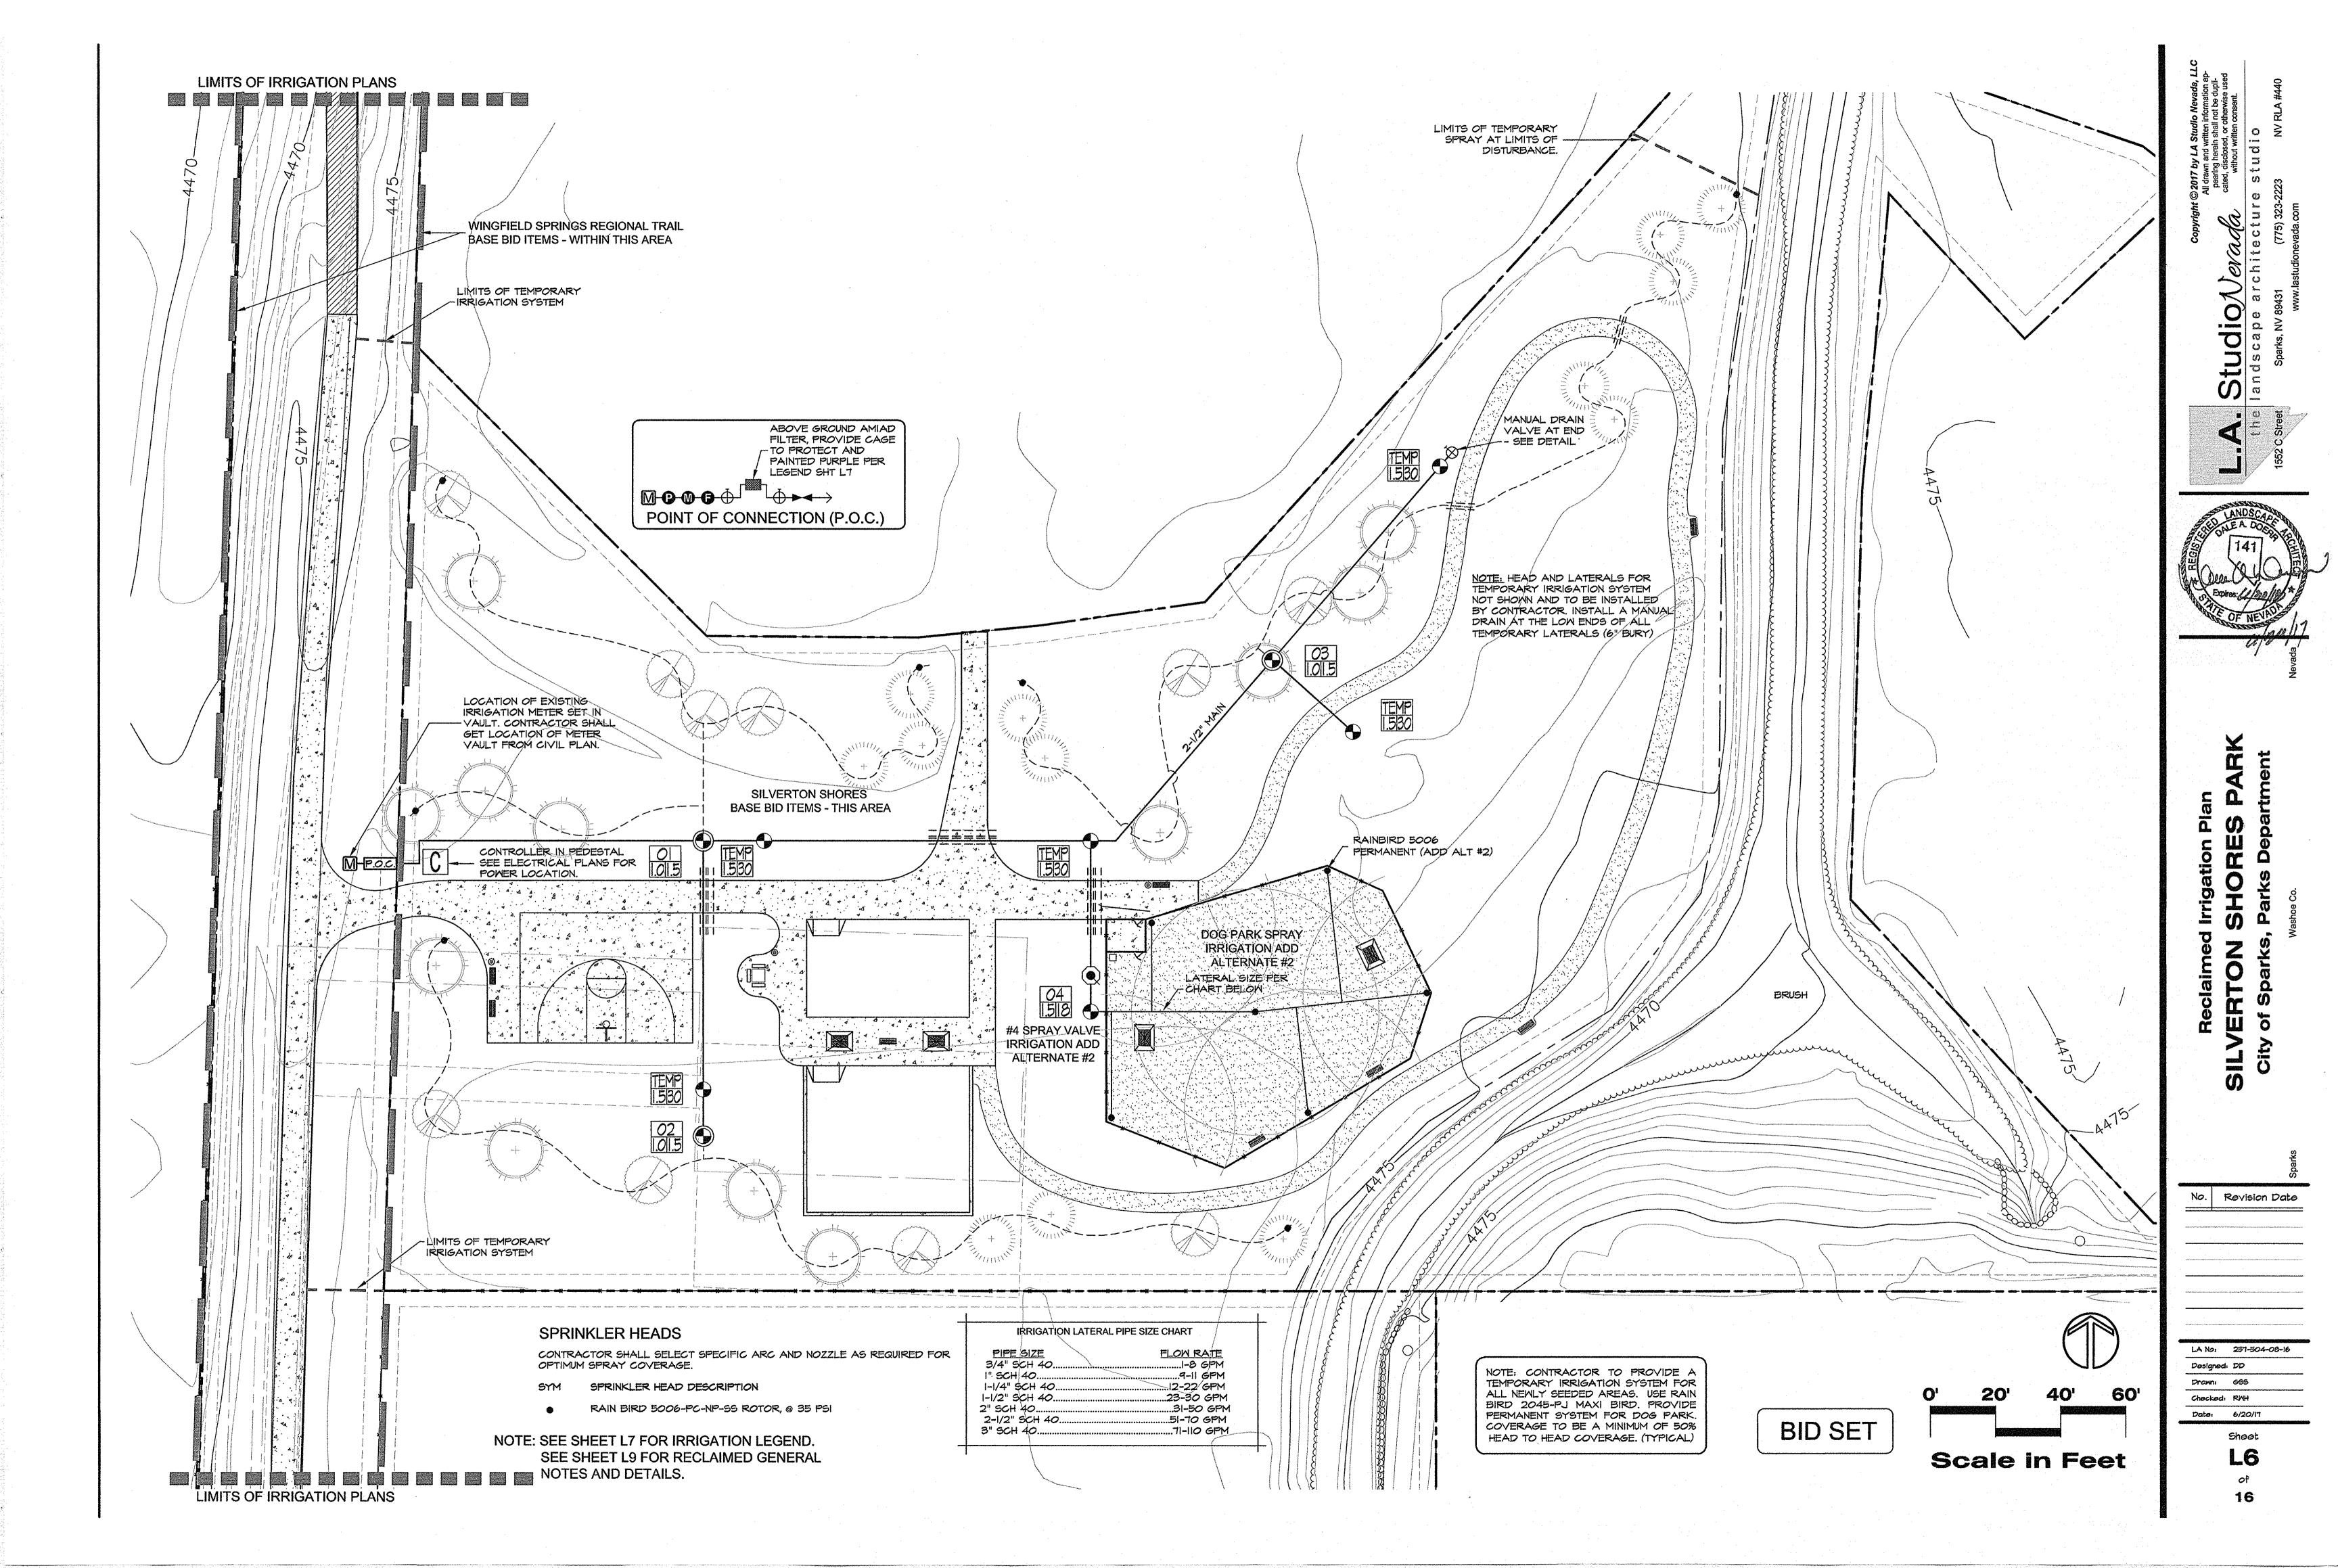

RECLAIMED WATER TREATED EFFLUENT

GENERAL NOTES:

I. ALL COVERS FOR METER BOXES, VALVE BOXES, FLUSH VALVES, PRESSURE REDUCING VAULTS, NR/VAC RELEASE ASSEMBLIES, AND ALL OTHER APPURTENANCES REQUIRING VAULTS OR BOXES SHALL BE PURPLE IN COLOR (PANTONE COLOR #512), LABELED 'RECLAIMED WATER' OR 'EFFLUENT', AND HAVE SECURED OR LOCKING LIDS. PURPLE COLORATION SHALL BE OBTAINED FROM THE MANUFACTURER OR BE APPLIED BY POWDER COATING OR EPOXY PAINT. ALL APPURTENANCES SHALL HAVE A PURPLE TAG ATTACHED WITH THE WORDING "WARNING RECYCLED/RECLAIMED WATER DO NOT DRINK" AND "AVISO AGUA IMPURA NO TOMAR" (T. CHRISTY ENTERPRISES, MAXI VALVE IDENTIFICATION TAG, ID-MAX-P2-RCOOG OR CITY OF SPARKS APPROVED EQUAL). A DEBRIS CAP WITH PURPLE COLORATION SHALL BE INSTALLED INSIDE OF ALL ROUND BOXES.

- 2. ALL ABOVE GROUND PIPING SHALL BE EPOXY PAINTED PURPLE (PANTONE COLOR #512) AND HAVE A PURPLE TAG ATTACHED WITH THE WORDING "WARNING RECYCLED/RECLAIMED WATER DO NOT DRINK" AND "AVISO AGUA IMPURA NO TOMAR" (T. CHRISTY ENTERPRISES. MAXI VALVE IDENTIFICATION TAG, ID-MAX-P2-RCOO6 OR CITY OF SPARKS APPROVED EQUAL).
- 3. ALL QUICK COUPLER VALVES SHALL HAVE PURPLE, LOCKABLE COVERS (RAIN BIRD 44NP OR CITY OF SPARKS APPROVED EQUAL).
- 4. ALL IRRIGATION CONTROLLER ENCLOSURES SHALL BE LABELED INSIDE AND OUTSIDE WARNING THAT THE SYSTEM USES RECLAIMED WATER (T. CHRISTY ENTERPRISES, CONTROLLER MARKING DECAL, PART NUMBER #ID-4100, OR CITY OF SPARKS APPROVED EQUAL).
- 5. DIRECT CONNECTIONS BETWEEN POTABLE WATER PIPING AND RECLAIMED WATER PIPING SHALL NOT EXIST UNDER ANY CONDITION, WITH OR WITHOUT BACKFLOW PROTECTION. REFERENCE SECTION 603.3.5 OF THE UNIFORM PLUMBING CODE, LATEST EDITION.
- 6. EACH EFFLUENT SERVICE CONNECTION SHALL INCLUDE A METER PROVIDED BY THE CITY OF SPARKS, UNLESS OTHERWISE STATED IN THE EFFLUENT AGREEMENT WITH THE CITY OF SPARKS.
- TRACER WIRE SHALL BE PROVIDED FOR ALL DISTRIBUTION RECLAIMED WATER LINES AND SERVICE LATERALS AND SHALL BE PLACED ON TOP OF PIPE AND ATTACHED WITH DUCT TAPE AT 6 FEET MAXIMUM INTERVALS. AT 500 FEET INTERVALS, TRACER WIRE SHALL BE EXTENDED INTO SEPARATE TEST STATIONS CONSISTING OF RISERS AND VALVE BOXES. TEST LEAD WIRE SHALL BE LONG ENOUGH TO EXTEND FOUR (4) FEET ABOVE GROUND LEVEL AND SHALL TERMINATE IN TEST STATION BOX. TRACER WIRE SHALL BE ATTACHED TO SERVICE LATERALS WITH DUCT TAPE AT 3 FEET MAXIMUM INTERVALS, AND SHALL BE LONG ENOUGH TO EXTEND FOUR (4) FEET ABOYE GROUND AND SHALL TERMINATE IN METER BOX. TRACER WIRE SHALL BE PROVIDED FOR ALL IRRIGATION RECLAIMED WATER PIPING 3-INCH DIAMETER AND LARGER, BOTH WITHIN PUBLIC RIGHT-OF-WAY AND PRIVATE PROPERTY, AND SHALL BE PLACED ON TOP OF PIPE AND ATTACHED WITH DUCT TAPE AT 6 FEET MAXIMUM INTERVALS. TRACER WIRE SHALL BE LONG ENOUGH TO EXTEND FOUR (4) FEET ABOVE GROUND AND SHALL TERMINATE IN APPROPRIATE IRRIGATION CONTROL/VALVE BOX AT MAXIMUM 500 FEET INTERVALS. WIRE SHALL BE #12 AWG, INSULATED, STRANDED COPPER, THIN 600V. PRIOR TO ACCEPTANCE OF THE RECLAIMED WATERLINE(S) BY THE CITY OF SPARKS. THE CONTRACTOR SHALL PERFORM A CONTINUITY TEST AFTER BACKFILLING THE TRENCH TO THE SATISFACTION OF THE CITY OF SPARKS INSPECTOR AND/OR ENGINEER.
- 8. ALL BURIED IRRIGATION PIPING UPSTREAM OF AN ELECTRICAL CONTROL VALVE SHALL BE PURPLE PLASTIC PIPE OR BE ENCASED IN PURPLE POLYETHYLENE OR BAGS LABELED "CAUTION: BURIED RECLAIMED WATER LINE BELOW" AT INTERVALS NO GREATER THAN 5 FEET. FOR POLYETHYLENE (PE) SERVICE PIPE, PURPLE STRIPES ARE ACCEPTABLE.
- 9. ALL PIPING DOWNSTREAM OF AN ELECTRIC CONTROL VALVE SHALL BE PURPLE PLASTIC OR HAVE PURPLE RECLAIMED WARNING TAPE PLACED ON TOP OF THE PIPE. THIS DOES NOT APPLY TO FLEXIBLE POLYETHYLENE TUBING USED IN DRIP ZONES.
- IO. BURIED WARNING AND IDENTIFICATION TAPE SHALL BE POLYETHYLENE PLASTIC, METALLIC CORE DETECTABLE WARNING TAPE. AWMA, APMA, ACID AND ALKALI RESISTANT. PERMANENT MARKING, UNAFFECTED BY MOISTURE OR SOIL. MINIMUM FIVE (5) MILS THICK BY 3-INCHES WIDE. WARNING TAPE SHALL BE MANUFACTURED SPECIFICALLY FOR LOCATING, WARNING, AND IDENTIFICATION OF BURIED UTILITY LINES. APMA COLOR COOED PURPLE FOR RECLAIMED WATER WITH WARNING AND IDENTIFICATION IMPRINTED IN BOLD BLACK LETTERS CONTINUOUSLY OVER THE ENTIRE TAPE LENGTH. WARNING AND IDENTIFICATION TO READ "CAUTION: BURIED RECLAIMED WATER LINE BELOW" OR SIMILAR.'
- II. SIGNAGE SHALL BE POSTED AT ALL POINTS OF PUBLIC ACCESS (GATES, DRIVEWAYS, ETC.) AND AT MINIMUM 300 FEET INTERVALS ALONG PROJECT FENCE LINE OR BORDER. IF RECLAIMED WATER IS STORED IN PONDS, PROVIDE SIGNAGE AT PONDS, SIGNS SHALL BE BILINGUAL IN ENGLISH AND SPANISH. MINIMUM SIGN SIZE SHALL BE 9" X 12'. REFERENCE CITY OF SPARKS EFFLUENT REUSE SYSTEM DETAIL SR-2.
- 12. RECLAIMED WATER LINES SHALL BE TREATED AS SEMER LINES AND ALL APPLICABLE SEPARATION FROM POTABLE WATER LINES SHALL BE MAINTAINED, UNLESS OTHERWISE AUTHORIZED.
- 13. HOSE BIBS SHALL NOT BE INSTALLED ON RECLAIMED WATER SYSTEMS.
- 14. CITY OF SPARKS INSPECTOR SHALL BE NOTIFIED BEFORE ANY SECTION OF PIPELINE IS BURIED TO ALLOW FOR INSPECTION AND POSITIONAL GPS OF THE FACILITIES.
- THE FOLLOWING REFERENCED DOCUMENT SHALL SERVE AS SITE STANDARDS:

 "CITY OF SPARKS RECLAIMED WATER TREATED EFFLUENT DESIGN &
 PERFORMANCE STANDARDS."

RECLAIMED IRRIGATION LEGEND

IRRIGATION CONTROL CLOCK: RAIN BIRD ESP-12LXMEF CONTROLLER W RAIN BIRD IQNCC3G CELLULAR CARTRIDGE. INSTALL CLOCK AND SENSOR PER MFG'S SPECIFICATIONS. PROVIDE A METAL CABINET AND PEDESTAL PER DETAIL 2, SHT L8. TEMP.SPRAY VALVE TO BE WIRED TO CONTROLLER

M I-1/2 INCH WATER METER - VERIFY SIZE AND LOCATION PER CIVIL DWGS.

INLINE PRESSURE REGULATOR: WILKENS 500 SERIES (OAE). INSTALL IF AVAILABLE WATER PRESSURE EXCEEDS 80 PSI. SIZE TO MATCH MAINLINE.

MASTER VALVE: BUCKNER SUPERIOR 3200-RW NORMALLY OPEN (2' MAX BURIAL DEPTH)

• AVAILABLE IN SIZES 3/4" TO 3"

RAIN BIRD FLOW SENSOR AND TRANSMITTERS - SIZE AND INSTALLATION PER MFG"S

MANUAL DRAIN VALVE: 3/4" CURB STOP VALVE. (MUELLER OR OAE) INSTALL AT ALL LOW

SPECIFICATIONS.

AMIAD 2" T-S MPT FILTER WITH 100 MICRON FILTRATION HOUSING (PVC SCH 80) AND

SCREEN WITH METAL COVER - GUARDSHACK ECONO-CAGE EC-I WITH EP-I PAD. NON-POTABLE PURPLE POWDERCOAT FINISH (OAE)

POINTS ALONG MAINLINE

WEDGE GATE VALVE WITH SQUARE TOP (OAE) FOR MAINLINE ISOLATION. SAME SIZE AS

SPRAY VALVE: RAIN BIRD PESB-R (WITH PRS-D MODULE TO PREVENT MISTING IF NEEDED DUE TO HIGH PRESSURE). (NON-POTABLE PURPLE) SIZE PER PLAN.

DRIP VALVE ASSEMBLY:
FLOWS UP TO 3 GPM INSTALL RAIN BIRD XCZ-LF-100-PRF LOW FLOW DRIP KIT.
(NON-POTABLE PURPLE)

QUICK COUPLER: RAIN BIRD 44-NP. PROVIDE OWNER WITH TWO VALVE KEYS (RAIN BIRD 44-K).

23-1 | VALVE I.D. - STATION #, VALVE SIZE, AND APPROX. G.P.M.

MAINLINE: ALL MAINLINES SHALL BE 2-1/2" SCH. 40 PURPLE PVC W/ SCH. 80 FITTINGS:

 ALL IRRIGATION CROSSINGS OVER WATER SERVICE LINES WILL BE JOINTLESS HDPE (HIGH DENSITY POLYETHYLENE) WITH FITTINGS AS NEEDED TO CONNECT TO SCH. 40 IRRIGATION MAINLINE.

INSTALL ALL MAINLINES AT 24 INCH MINIMUM DEPTH. SIZE PER PLAN.

LATERAL PIPES: SCH. 40 PURPLE PVC LATERAL W/ SCH. 40 FITTINGS. SIZE PER CHART. INSTALL PER DETAIL.

DRIP DISTRIBUTION TUBING: 3/4" RAIN BIRD XBS-PURPLE STRIPING IRRIGATION TUBING WITH RAIN BIRD MDCFCAP REMOVABLE FLUSH CAP.

<u>SLEEVES:</u> ALL IRRIGATION SLEEVES UNDER STREETS AND DRIVEWAYS SHALL BE 4 INCH MINIMUM SCH. 40 PURPLE PVC. SLEEVES FOR DRIP TUBING UNDER SIDEWALKS MAY BE 2 INCH MINIMUM SCH. 40 PURPLE PVC. PROVIDE ONE SLEEVE PER PIPE AND ONE SLEEVE FOR WIRING.

VALVE BOXES (NOT SHOWN): ALL VALVES SHALL BE LOCATED IN RAIN BIRD PVB PROFESSIONAL SERIES VALVE BOXES WITH PURPLE LIDS PER DETAILS. NOTE: ANY BOXES LOCATED IN PAVED AREAS (IF NEEDED) SHALL BE TRAFFIC RATED CONCRETE.

EMITTER SCHEDULE

DECIDUOUS & EVERGREEN TREES: (4) RAIN BIRD XERI-BUG 2 GPH PRESSURE COMPENSATING EMITTERS
#5 AND #1 SHRUBS: (2) RAIN BIRD XERI-BUG | GPH PRESSURE COMPENSATING EMITTERS

GROUND COVER/PERENNIALS: (1) RAIN BIRD XERI-BUG I GPH PRESSURE COMPENSATING EMITTER.

SPRINKLER HEADS

CONTRACTOR SHALL SELECT SPECIFIC ARC AND NOZZLE AS REQUIRED FOR OPTIMUM SPRAY COVERAGE.

SPRINKLER HEAD DESCRIPTION

RAIN BIRD 5006-PC-NP-SS ROTOR, @ 35 PSI

DESIGN PRESSURE NOTE:

ASSUMED AVAILABLE WATER PRESSURE AT P.O.C. IS 90 PSI. ASSUMED FLOW IS 18 GPM @ 5 FPS. CONTRACTOR TO VERIFY PRIOR TO SYSTEM INSTALLATION. FUTURE PRESSURES MAY VARY DUE TO NEW DEVELOPMENT AND/OR OTHER UNFORESEEN CIRCUMSTANCES. LANDSCAPE ARCHITECT SHALL BEAR NO RESPONSIBILITY FOR FUTURE DEVIATIONS IN PRESSURE AND ANY RESULTING EFFECTS ON THE PERFORMANCE OF THE IRRIGATION SYSTEM.

IRRIGATION MAINLINES ARE SHOWN IN STREET/PAVED AREAS FOR GRAPHIC CLARITY ONLY. WHERE POSSIBLE, ALL IRRIGATION COMPONENTS SHALL BE LOCATED IN PLANTING BEDS.

MAINLINE CROSSINGS OVER WATER SERVICE LINES

- ALL IRRIGATION PIPE (MAINLINE, LATERAL LINE, AND DRIP TUBING) SHALL BE KEPT A MINIMUM OF IO FT AWAY FROM ALL HYDRANTS WITH DRAINS, AND 6 FT AWAY FROM THE CITY WATER SERVICE UPSTREAM FROM THE BACKFLOW PREVENTER.
- ALL IRRIGATION PIPE SHALL BE SLEEVED AT ALL CROSSINGS OVER
 POTABLE WATER SERVICE LINES, WITH THE SLEEVE EXTENDING A MINIMUM
 OF 10 FT IN BOTH DIRECTIONS FROM THE OUTSIDE EDGES OF THE SERVICE
 LINE.

IRRIGATION LATERAL PIPE SIZE CHART							
PIPE SIZE	FLOW RATE						
3/4" SCH 40	I-8 GPM						
1" SCH 40	9-11 GPM						
1-1/4" SCH 40	12-22 GPM						
1-1/2" SCH 40	23-30 GPM						
	31-50 GPM						
2-1/2" SCH 40	51-70 GPM						
3" SCH 40	TI-110 GPM						

IRRIGATION SPECIFICATIONS

GENERA

I. PLAN IS DIAGRAMMATIC ONLY. FINAL LOCATION OF LINES AND HEADS SHALL BE DETERMINED IN THE FIELD AND APPROVED BY THE OWNER'S REPRESENTATIVE. LINES SHALL BE IN A COMMON TRENCH WHEREVER POSSIBLE. THE POINT-OF-CONNECTION SHALL BE AS INDICATED ON THE PLAN.

2. THE CONTRACTOR SHALL VERIFY EXISTING SITE CONDITIONS AND ENSURE THAT ALL LOCAL CODES ARE

3. THE CONTRACTOR SHALL APPLY AND PAY FOR ALL PERMITS REQUIRED FOR INSTALLATION OF THE IRRIGATION SYSTEM AS DEPICTED ON THESE PLANS.

4. CONTRACTOR SHALL VERIFY AVAILABLE FLOW AND PRESSURE DOWNSTREAM FROM THE POINT-OF-CONNECTION PRIOR TO SYSTEM INSTALLATION. CONTRACTOR SHALL NOTIFY OWNER'S REPRESENTATIVE IMMEDIATELY IF AVAILABLE FLOW IS LESS THAN REQUIRED TO RUN THE LARGEST ZONE. CONTRACTOR SHALL NOT PROCEED ANY FURTHER WITH INSTALLATION OF THE SYSTEM UNTIL NECESSARY DESIGN REVISIONS HAVE BEEN DETERMINED BY OWNER'S REPRESENTATIVE.

5. THE CONTRACTOR SHALL NOT WILLFULLY INSTALL THE IRRIGATION SYSTEM AS SHOWN ON THE DRAWINGS WHEN IT IS OBVIOUS IN THE FIELD THAT UNKNOWN OBSTRUCTIONS OR DIFFERENCES IN DIMENSIONS EXIST THAT MIGHT HAVE BEEN UNKNOWN DURING ENGINEERING. SUCH OBSTRUCTIONS SHALL BE BROUGHT TO THE ATTENTION OF THE OWNER'S AUTHORIZED REPRESENTATIVE. IN THE EVENT THIS NOTIFICATION IS NOT PERFORMED, THE CONTRACTOR SHALL ASSUME FULL RESPONSIBILITY FOR ANY REVISIONS NECESSARY AT NO ADDITIONAL COST

6. ALL SPRINKLER EQUIPMENT NOT OTHERWISE DETAILED OR SPECIFIED SHALL BE INSTALLED PER MANUFACTURER'S RECOMMENDATIONS AND SPECIFICATIONS.

T. CONTRACTOR SHALL COORDINATE THE INSTALLATION OF ALL IRRIGATION MATERIAL, INCLUDING PIPE, WITH THE LANDSCAPE DRAWINGS TO AVOID INTERFERING WITH THE PLANTING OF TREES, SHRUBS, OR OTHER PLANTINGS.

8. ALL VALVES ARE TO BE LOCATED IN PLANTING AREAS WHEREVER POSSIBLE.

9. ALL ELECTRICAL WIRE FROM CONTROLLER TO VALVES SHALL BE 12 GAUGE UL DIRECT BURIAL OR LARGER AS REQUIRED BY LENGTH PER MANUFACTURER'S SPECIFICATIONS.

IO. BACKFILL FOR TRENCHING SHALL BE COMPACTED TO A DRY DENSITY EQUAL TO THE UNDISTURBED ADJACENT SOIL AND SHALL CONFORM TO ADJACENT GRADES WITHOUT DIPS, HUMPS, OR OTHER IRREGULARITIES.

II. A MINIMUM OF TWO WORKING DAYS PRIOR TO PERFORMING ANY DIGGING, CALL UNDERGROUND SERVICE ALERT AT 1-800-227-2600 FOR INFORMATION ON THE LOCATION OF NATURAL GAS LINES, ELECTRICAL CABLES, TELEPHONE CABLES, ETC.

12. CONTRACTOR AGREES THAT, IN ACCORDANCE WITH GENERALLY ACCEPTED CONSTRUCTION PRACTICES, CONTRACTOR WILL BE REQUIRED TO ASSUME SOLE AND COMPLETE RESPONSIBILITY FOR JOB SITE CONDITIONS DURING THE COURSE OF CONSTRUCTION OF THE PROJECT, INCLUDING SAFETY OF ALL PERSONS AND PROPERTY. THIS REQUIREMENT SHALL APPLY CONTINUOUSLY AND SHALL NOT BE LIMITED TO NORMAL WORKING HOURS.

IS. INSTALL ALL PIPE AND CONTROL WIRES IN LANDSCAPE BEDS AND IN COMMON TRENCHES WHEREVER POSSIBLE.

14. INSTALL ALL PIPE AND CONTROL WIRE, WHICH RUNS UNDER PAVING, WITHIN SCH. 40 PVC SLEEVES 4" DIA. MINIMUM SIZE AS REQUIRED TO ALLOW INSTALLATION WITHOUT BINDING. PROVIDE (I) SLEEVE PER PIPE. PROVIDE SEPARATE SLEEVES FOR CONTROL WIRE.

15. CONTRACTOR SHALL BE RESPONSIBLE TO PROVIDE FOR COMPLETE DRAINAGE OF THE MAINLINES BY INSTALLING MANUAL DRAINS AS INDICATED ON PLAN AND AT ALL SYSTEM LOW POINTS.

Flushing and testing

16. PIPING SHALL BE COMPLETELY FLUSHED OF FOREIGN PARTICLES BEFORE ATTACHING IRRIGATION COMPONENTS AND DRAIN VALVES.

17. AFTER FLUSHING, AND WHEN ALL VALVES AND QUICK COUPLERS ARE IN PLACE, ALL MAIN SUPPLY LINES SHALL BE TESTED AT 100 POUNDS PER SQUARE INCH (100 PSI) WITH VALVES CLOSED. MAINTAIN PRESSURE FOR A PERIOD OF NOT LESS THAN (4) CONSECUTIVE HOURS. ALL JOINTS SHOWING LEAKS SHALL BE CLEANED, REMADE, AND TESTED.

18. OPERATIONAL TESTING: PERFORM OPERATIONAL TESTING AFTER HYDROSTATIC TESTING IS COMPLETED. DEMONSTRATE TO THE OWNER'S REPRESENTATIVE THAT THE SYSTEM MEETS COVERAGE REQUIREMENTS (100%) AND THAT AUTOMATIC CONTROLS FUNCTION PROPERLY.

SUBMITTALS

III. MATERIALS LIST: WITHIN (IS) DAYS AFTER AWARD OF CONTRACT, SUBMIT TO OWNER'S REPRESENTATIVE (3) COPIES OF A COMPLETE MATERIAL LIST (PARTIAL LIST NOT ACCEPTABLE) OF ALL MATERIALS TO BE USED ON THE PROJECT, SPECIFYING MANUFACTURER, GRADE, TRADE NAME, CATALOG NUMBER, SIZE, ETC. THIS SHALL IN NO WAY BE CONSTRUED AS ALLOWING A SUBSTITUTION FOR ANY ITEM SPECIFIED ON THE PLANS. EQUIPMENT OR MATERIALS INSTALLED OR FURNISHED WITHOUT THE PRIOR WRITTEN APPROVAL OF THE OWNER'S REPRESENTATIVE MAY BE REJECTED AND THE CONTRACTOR REQUIRED TO REMOVE THE MATERIALS AT HIS OWN EXPENSE.

INSTALLATION AND PERFORMANCE OF APPROVED SUBSTITUTIONS ARE THE CONTRACTORS RESPONSIBILITY. ANY CHANGES REQUIRED FOR INSTALLATION OF ANY APPROVED SUBSTITUTION MUST BE MADE TO THE SATISFACTION OF THE OWNER'S REPRESENTATIVE WITHOUT ADDITIONAL COST TO OWNER.

20. PRIOR TO SYSTEM INSTALLATION CONTRACTOR SHALL VERIFY AND SUBMIT TO OWNER'S REPRESENTATIVE IN WRITING, AVAILABLE FLOW AND PRESSURE AT POINT-OF-CONNECTION AS DESCRIBED IN SPECIFICATION #4 ABOVE.

21. COMPLETE WARRANTY CARDS FOR AUTOMATIC CONTROLLER AND OTHER IRRIGATION MATERIAL (CONTROLLER KEYS, ETC.) SHALL BE DELIVERED TO OWNER.

22. CONTRACTOR SHALL PREPARE AND ISSUE TO THE OWNER (AT COMPLETION OF THE INSTALLATION) AN ANNUAL CHART INDICATING LOCATION, OPERATING DATES, CYCLES, AND TIME FOR EACH ZONE.

23. ASBUILT IRRIGATION DRAWINGS: CONTRACTOR SHALL FURNISH ASBUILTS OF THE COMPLETE IRRIGATION SYSTEM. PROCURE FROM OWNER'S REPRESENTATIVE DIGITAL COPIES OF CONTRACT DRAWINGS. CONSTRUCTION DRAWINGS SHALL BE ON THE CONSTRUCTION SITE AT ALL TIMES WHILE THE IRRIGATION SYSTEM IS BEING INSTALLED. CONTRACTOR SHALL MAKE A DAILY RECORD OF ALL WORK INSTALLED DURING EACH DAY. ACTUAL LOCATION OF VALVES AND ALL IRRIGATION AND DRAINAGE PIPING SHALL BE SHOWN ON THE PRINTS BY DIMENSIONS FROM EASILY IDENTIFIED PERMANENT FEATURES, SUCH AS BUILDINGS, CURBS, FENCES, WALKS OR PROPERTY LINES. DRAWINGS SHALL SHOW APPROVED MANUFACTURER'S NAME AND CATALOG NUMBER. THE DRAWINGS SHALL BE TO SCALE AND ALL INDICATIONS SHALL BE NEAT. ALL INFORMATION NOTED ON THE PRINT SHALL BE TRANSFERRED TO THE COPIES BY CONTRACTOR AND ALL INDICATIONS SHALL BE RECORDED IN A NEAT, ORDERLY WAY. THE RECORD COPIES SHALL BE TURNED OVER TO THE OWNER'S REPRESENTATIVE AT OR BEFORE FINAL ACCEPTANCE/APPROVAL OF THE PROJECT.

GUARANTEE/FINAL ACCEPTANCE


24. CONTRACTOR SHALL UNCONDITIONALLY GUARANTEE THE IRRIGATION SYSTEM FOR A PERIOD OF ONE YEAR FROM THE DATE OF FINAL ACCEPTANCE. MANUFACTURER WARRANTIES SHALL ONLY EXCEED THIS GUARANTEE AND CONTRACTOR SHALL BE LIABLE FOR REPAIRS/REPLACEMENT OF FAILED MATERIAL/WORKMANSHIP.

MAINTENANCE

25. AFTER SYSTEM IS INSTALLED AND APPROVED, INSTRUCT OWNER'S DESIGNATED PERSONNEL IN COMPLETE OPERATION AND MAINTENANCE PROCEDURES. DRAIN ENTIRE SYSTEM AT END OF FIRST WATERING SEASON FOLLOWING INSTALLATION. TRAIN OWNER'S DESIGNATED PERSONNEL BY HAVING THEM ASSIST IN WINTERIZING PROCEDURE

NOTE: CONTRACTOR TO PROVIDE A TEMPORARY IRRIGATION SYSTEM FOR ALL NEWLY SEEDED AREAS. USE RAIN BIRD 2045-PJ MAXI BIRD. PROVIDE PERMANENT SYSTEM FOR DOG PARK. COVERAGE TO BE A MINIMUM OF 50% HEAD TO HEAD COVERAGE. (TYPICAL)

BID SET

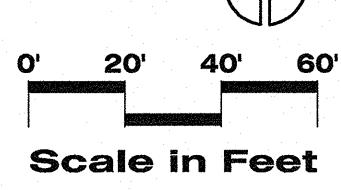

TATURE STATE OF NEW YORK OF NE

8

S

0

2 Z

To o

0

SILVERTON SHORES PAR City of Sparks, Parks Departmen

LA No: 257-504-08-16

Designed: DD


Prawn: 669

Checked: RWH

Revision Date

Date: 6/20/17
Sheet

L / o[†] 16

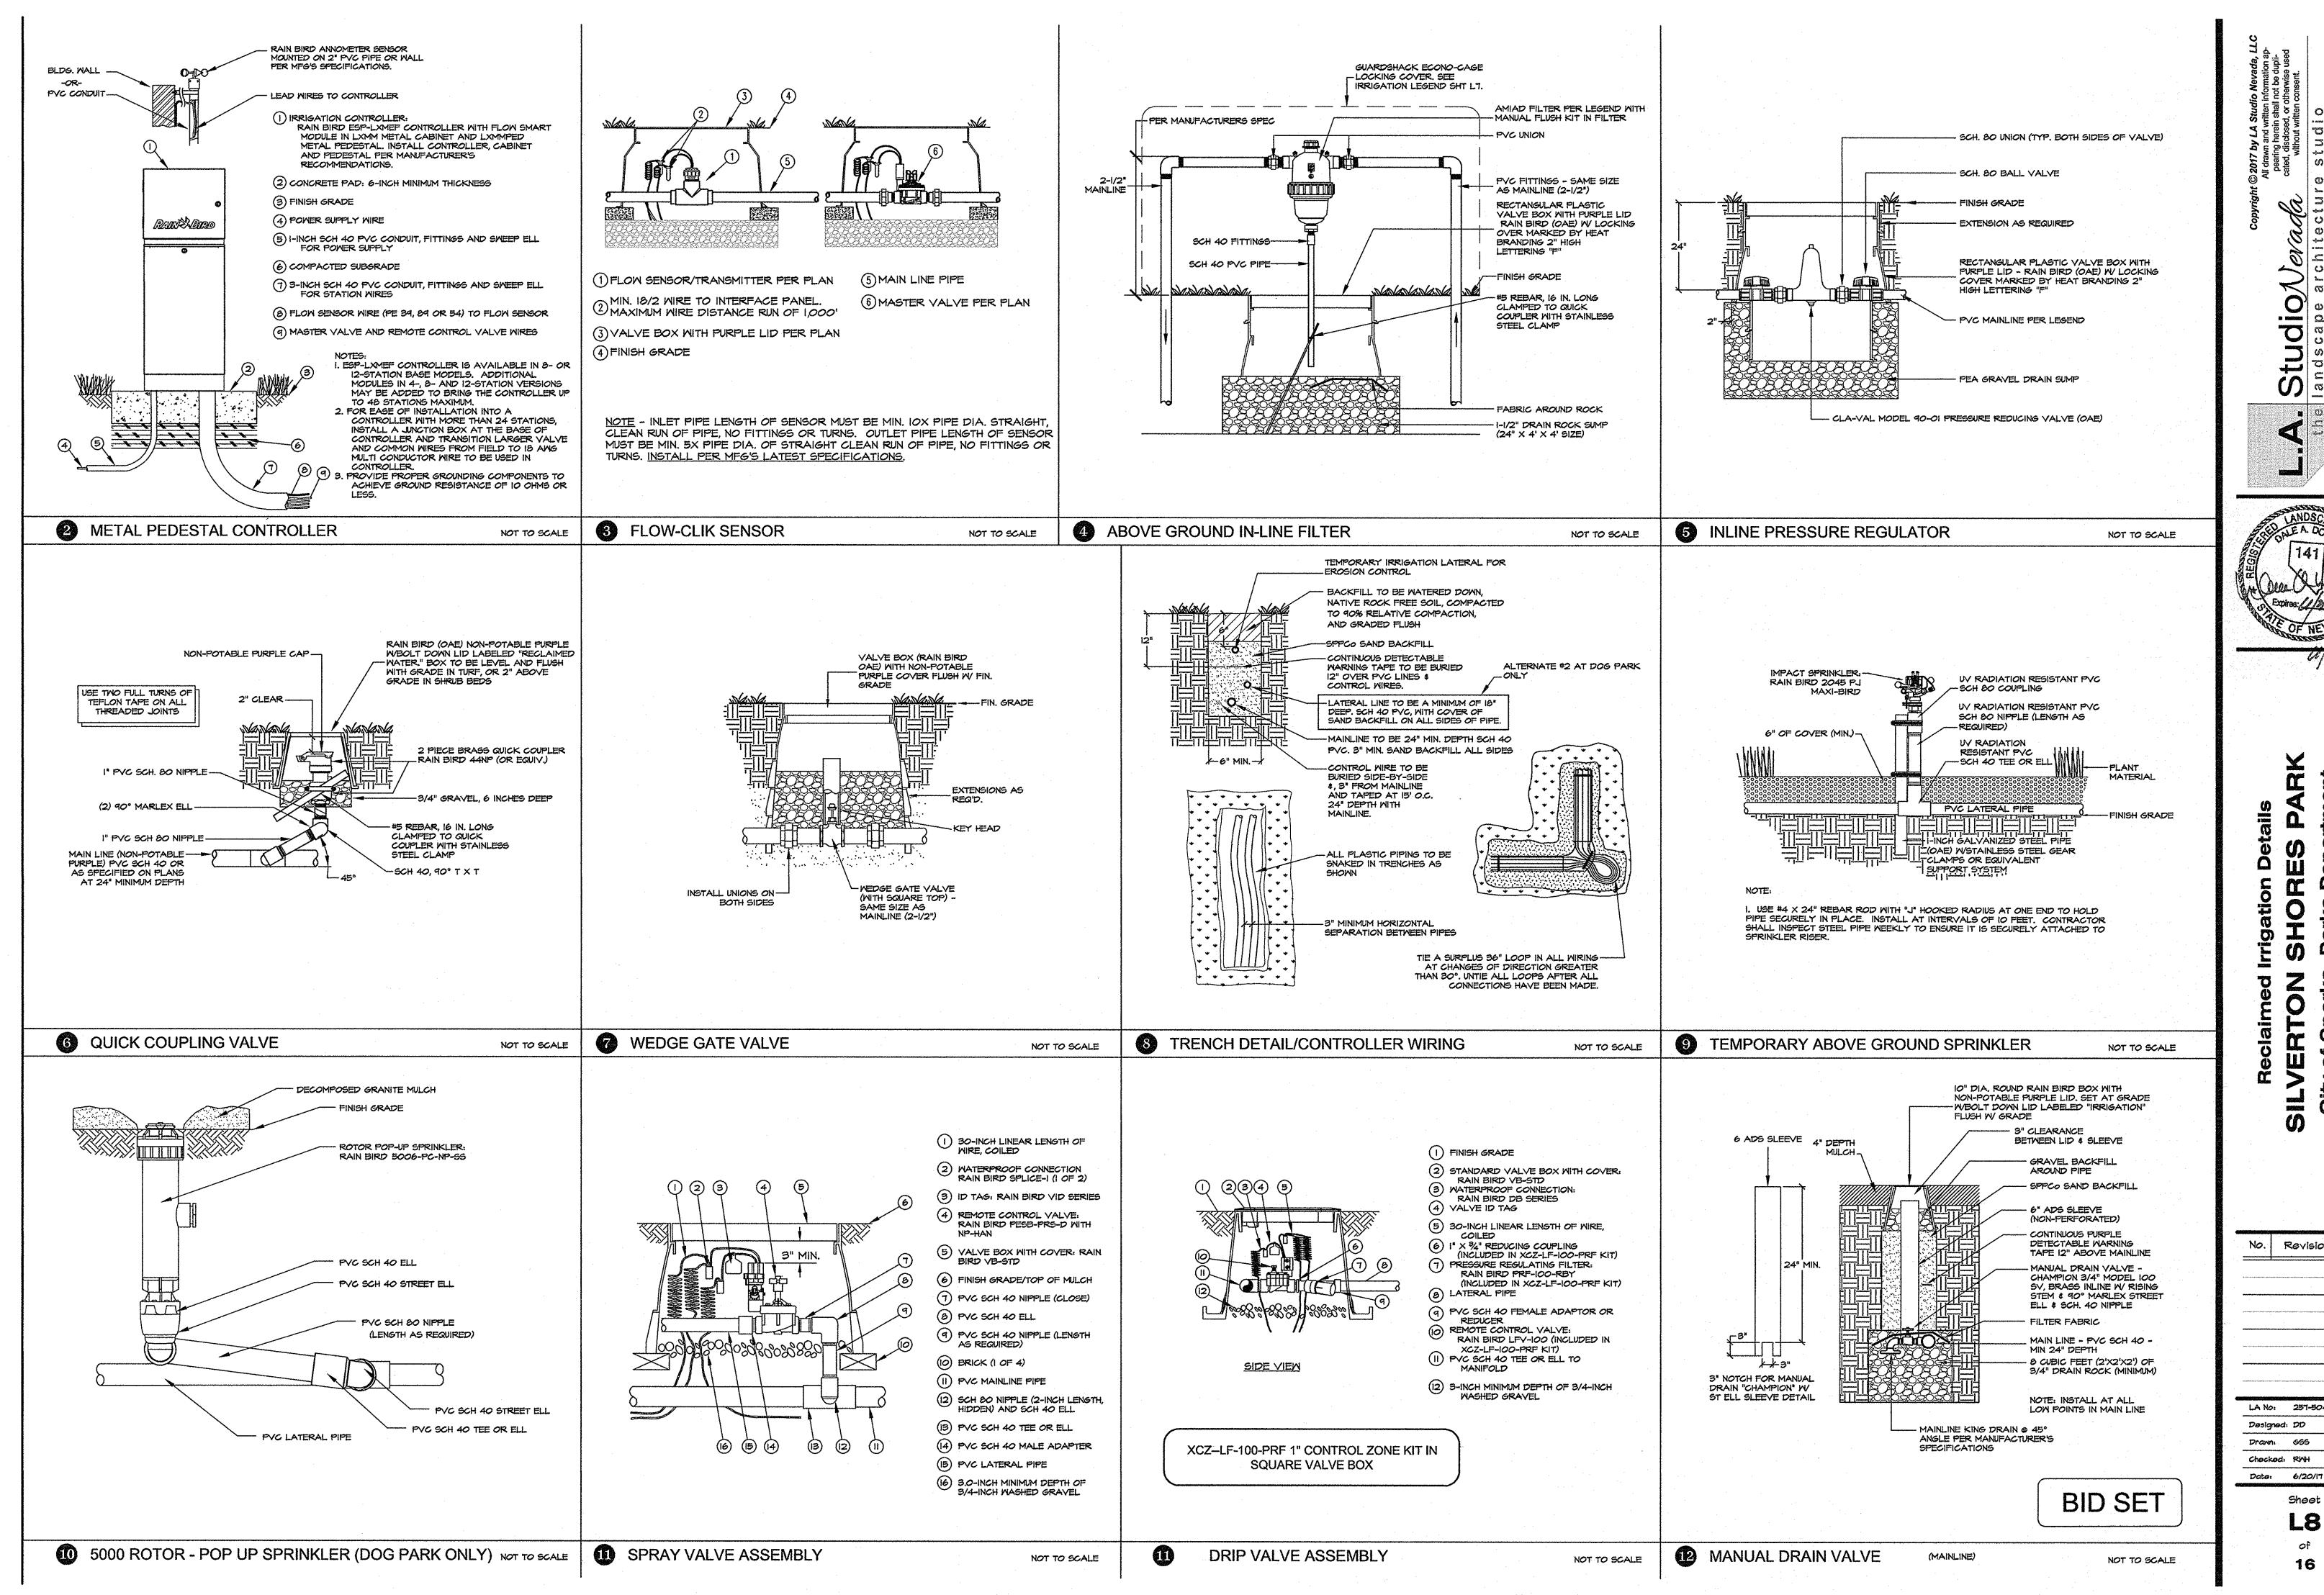


Revision Date

LA No: 257-504-08-16 Designed: DD Drawn: 655 Checked: RWH

> Sheet **L8**

16

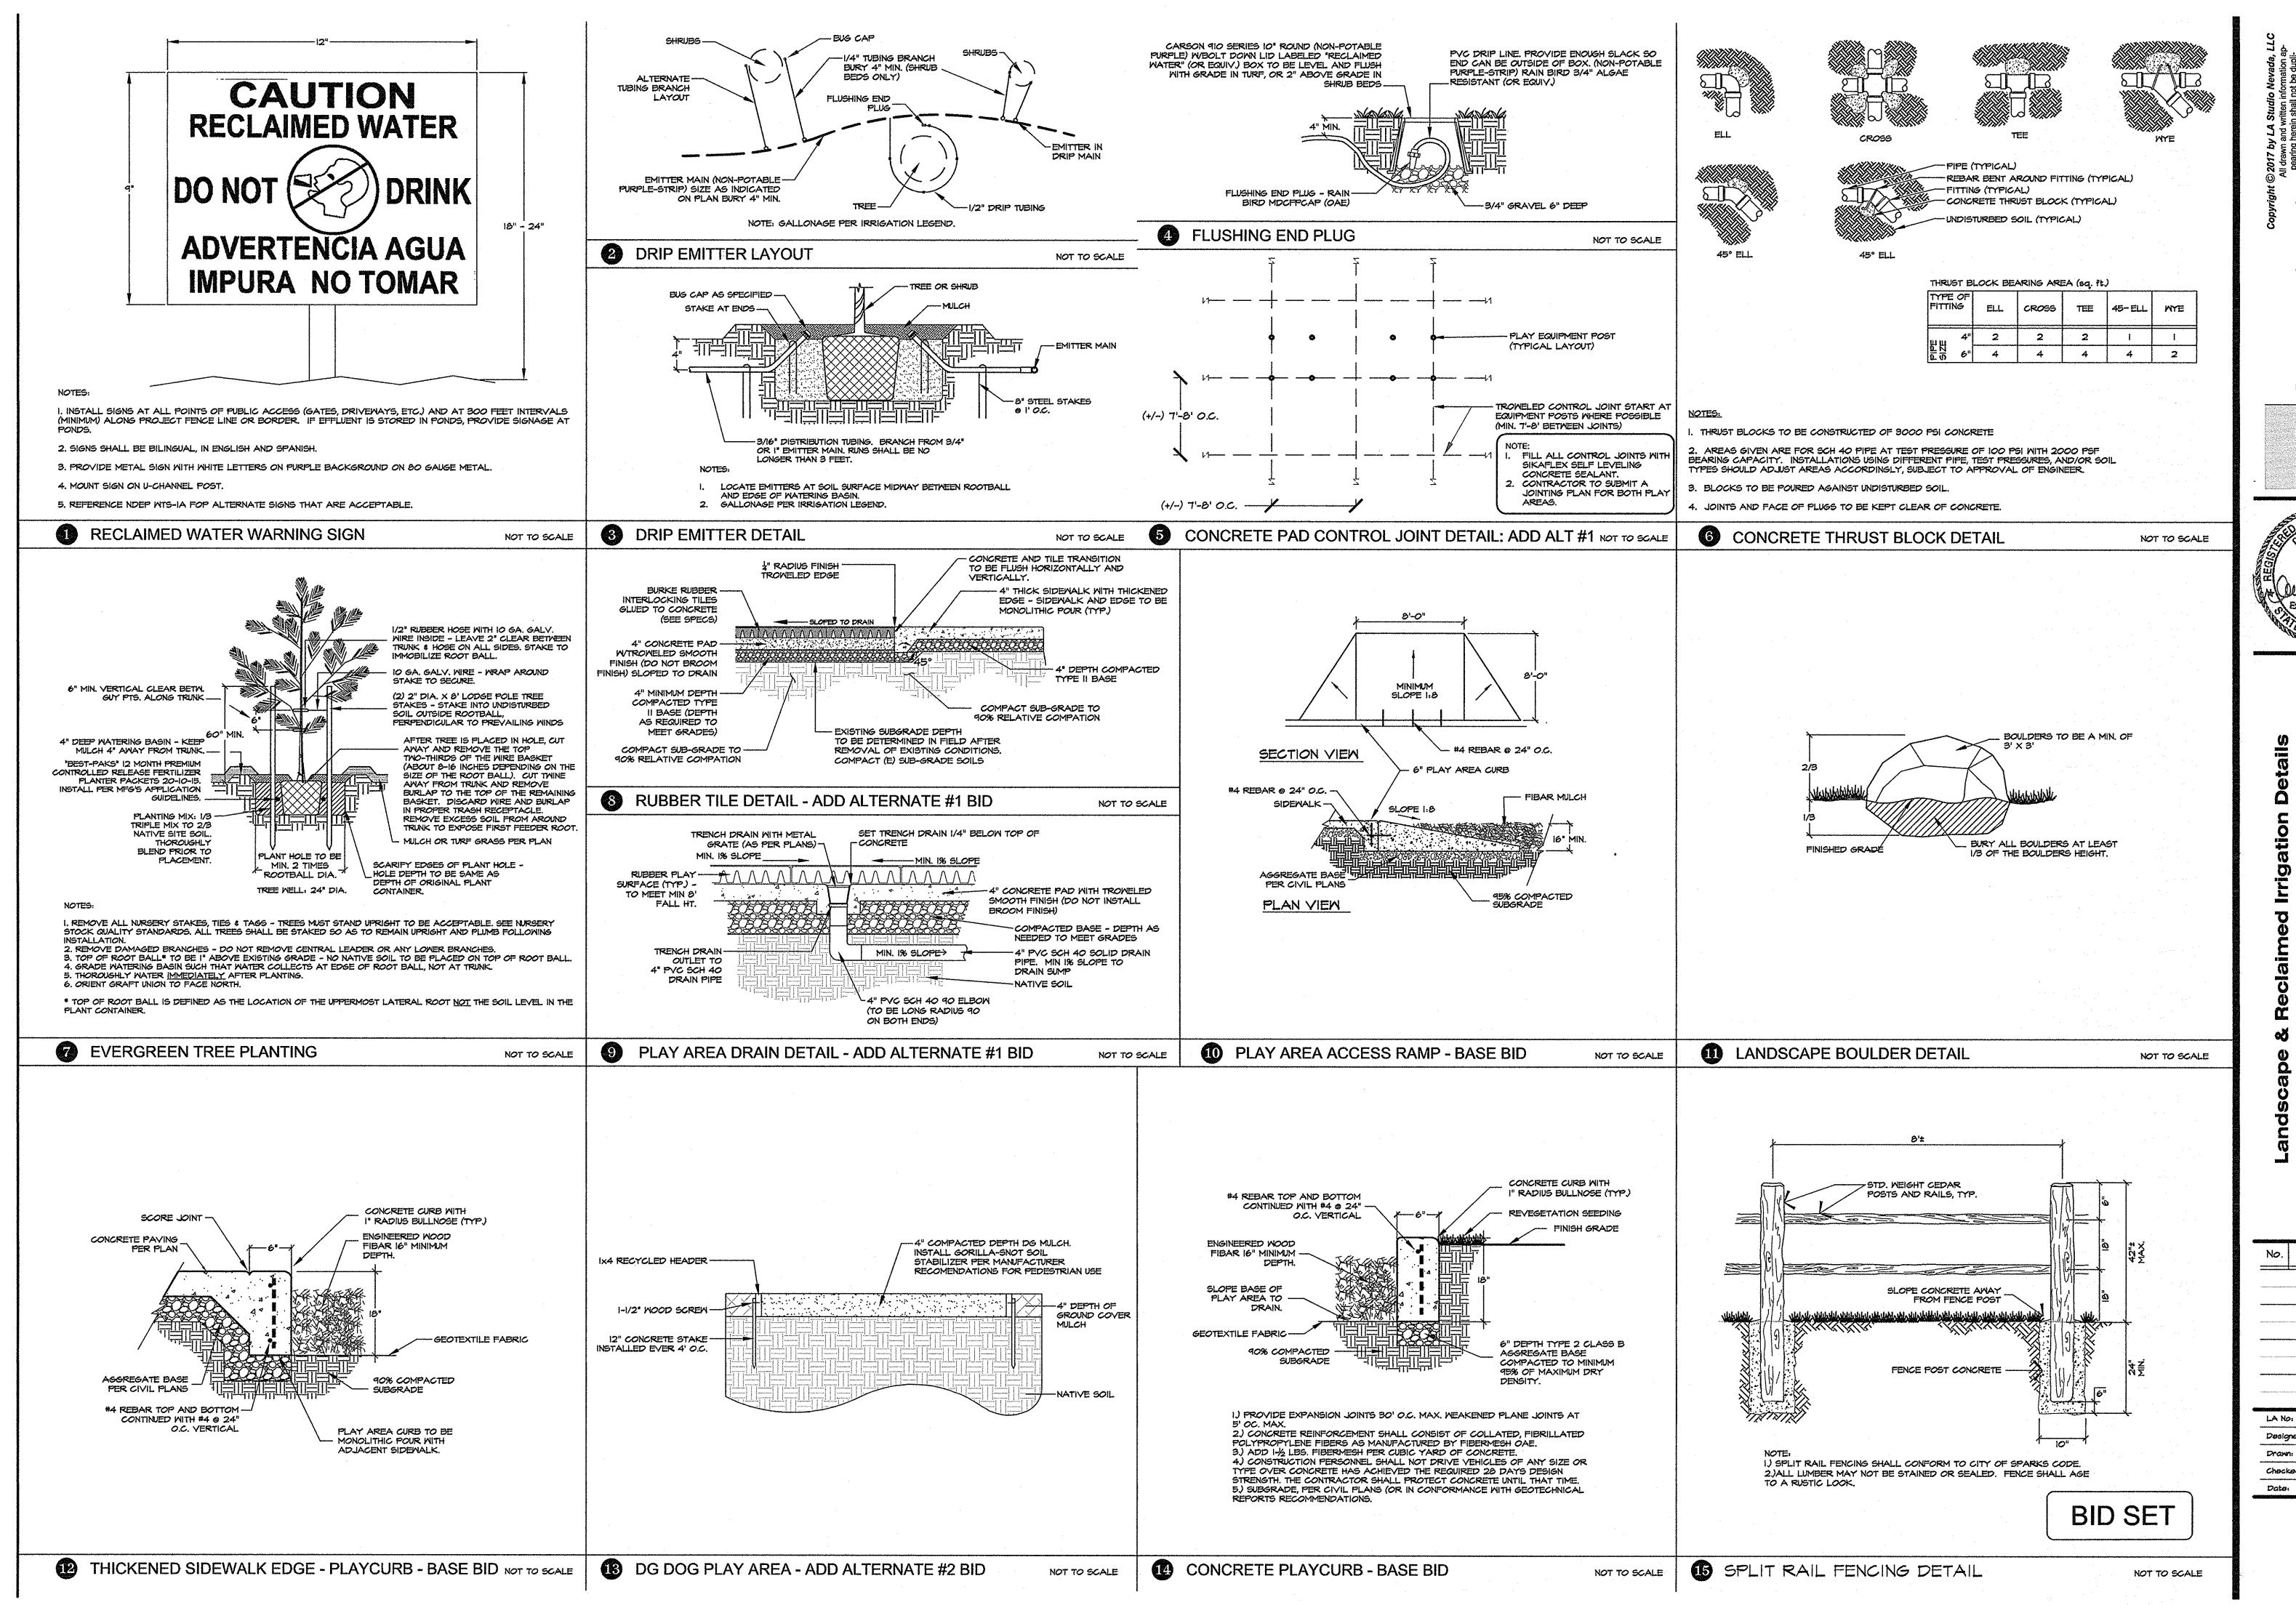

Revision Date

LA No: 257-504-08-16

Designed: DD Drawn: 665 Checked: RWH Date: 6/20/17

Sheet

16

SILVERTON SHORES PARK PLAYGROUND SPECIFICATIONS

PART 1 - GENERAL

- 1.) Description: Installations shall be completed per manufacturer recommendations, manufacturer specifications, and within applicable safety and ADA references as listed below. The work shall include any incidentals required to provide a finished job to the satisfaction of City of Sparks representative.
- 2.) Reference Safety Guidelines, Standards and ADA Compliance: All materials and product installations shall conform to the current issue of:
- "Handbook for Public Playground Safety" published by the Consumer Product Safety Commission (CPSC):
- ASTM 1487-07a; and 3) ADA Accessibility Guidelines (ADAAG) for Play Areas. The Contractor shall be responsible for all new products and installations are compliant with these references. All construction and materials shall conform to the latest "Standard Specifications for Public Works Construction, City of Sparks, Nevada: (Orange Book) including all addenda.
- 3.) Quality Assurance: The playground installation Contractor shall have the following:
- Have at least (5) five recent (within the last 3 years) installations of play equipment. including (3) three installations of safety surfacing utilizing the specified product and/or an approved equivalent.
- Contractor shall have a current C-25 Contractors License.
- The Contractor shall have a responsible individual(s) under employment serving as a "Certified Playground Safety Inspector", as recognized by the National Playground Safety Institute and the National Recreation and Park Association, with current validation. The Contractor shall within 48 hours of request produce written verification of
- 4.) Submittals: The Contractor shall submit to owner for approval prior to ordering;
- technical specifications and samples of the following products: Specified play equipment site plan and 3D view for approval.
- Specified play equipment color scheme options for approval. Rubber Tile: specified product sell sheet and cut sheets for approval.
- Rubber Tile: One sample of each height of rubber tile with specified color.
- Rubber Tile Adhesives: specified product sell sheet and cut sheets for approval.
- Specified concrete mix details.
- Base aggregate soils analysis and or sieve analysis.
- Drainage pipe cut sheet or shop drawings for approval.
- Landscape and Irrigation submittals as per specified products on the plans (if
- 5.) Substitutions: The Contractor shall submit to owner (7) seven days prior to bid date, all variances for these specifications for approval.
- The County has up to (4) four days to review and respond.
- 6.) Warranties: The Contractor shall submit all product manufacturer's warranties to City of Sparks prior to completion of project. Contractor shall warranty installation workmanship of

Contractor to hold a valid C25 contractor's license. See Manufacturers Installation Instructions for proper installation. Fall safety use zones shall be laid out by a Certified Playground Safety Inspector prior to placement of concrete footings, curbs, or sidewalks.

Removal of existing (if applicable)

Permanently removed equipment to be disposed of legally by contractor unless otherwise specified by City of Sparks. For bidding purposes include disposal in base bid. All removed footing holes to be backfilled with approved aggregate base material and compacted in 4" lifts to 90% relative compaction.

- It is recommended that all play equipment (including correct play equipment installed height), fall safety zones, and fall safety material be inspected by a certified playground safety inspector during all stages of construction.
- Upon completion a Certified Playground Safety Inspector shall inspect equipment for proper installation and compliance with ASTM-1487, (American Society for Testing and Material), CPSP (Consumer Product Safety Commission), National Recreation and Park Association and Public Playground Safety Handbook. Contractor to provide to owners representative a written safety inspection, including pictures, prior to final acceptance.

3. Playground Safety Surfacing

A. BCI Burke 100% EPDM rubber tile (Interlocking tiles)

Maximum fall height: 8' (as specified on the "Playground Improvement Plans")

Size: 24" x 24" x 3-1/4"

Main Color: Beige (75% beige and 25% black)

Wear Area Color: Black (100% black)

- Delivery, Storage, and Handling
- Delivery Deliver materials to site in manufacturer's original, unopened containers and packaging, with labels clearly identifying product name and manufacturer.
- Storage Store tiles in a dry area prior to installation. Protect tiles from direct sunlight before installation.
- Adhesive: Store adhesive in a dry area at a minimum temperature of 40
- Handling: Protect materials during handling and installation to prevent

damage.

Environmental Requirements: Air Temperature: The air temperature should be a minimum of 40 degrees F for a minimum of 12 hours before and during installation.

- Materials and Workmanship: Playground safety surfacing tiles shall be warranted for defects in materials and workmanship for 5 years from
- cleaning and maintenance. Performance: Playground safety surfacing tiles shall be warranted to meet drop height performance requirements of ASTM F 1292 for 5 years from date of completed installation.

date of completed installation based on normal wear and proper

all play equipment for a period of (1) one year starting on the date of accepted substantial completion of the Project.

PART 2 - PRODUCTS

1. Description: Certified resilient rubber tiles 24" x 24". Playground Safety Tiles must meet the Consumer Product Safety Commission (CPSC) and Americans with Disability Act (ADA) requirements as tested by the American Society for Testing and Material (ASTM) methods. All tiles must meet the Head Injury Criteria (HIC) tests for applicable fall heights and are certified by the International Play Equipment Manufacturers Association (IPEMA).

• Additional features include: made exclusively from re-claimed rubber, water permeable design for dry play surface, 80+ leg, egg carton pattern bottom for greater fall protection, easy urethane adhesive (glue down) installation.

2. Manufacturers: Subject to compliance with requirements, provide products as manufactured:

- Specified Play Equipment: BCI Burke Company
- Specified Fall Safety: BCI Burke rubber tiles

BCI Burke local representative: **Buell Recreation Park and Playground Equipment** Headquarters Location - Sunset Office Building 9900 SW Wilshire Street #200 Portland, OR 97225

PART 3 - EXECUTION

1. Examination of conditions: Contractor to conduct a site visit prior to bid submission. Examine conditions under which all work will be performed. Do not proceed until conditions detrimental to proper and timely completion of work have been satisfactorily corrected and thus meet the manufacturer's instructions and delivery times. Beginning work constitutes acceptance of conditions as satisfactory.

2. Ordering of Products and Materials: Order all necessary products and materials with sufficient lead time that delivery will not delay construction. Within (10) ten working days of bid award contractor to provide an estimated schedule which reflects ordering lead times as well as estimated construction timeline.

3. Site Preparation:

- Remove and excavate materials as necessary to establish required subgrade depths per plans and/or specifications.
- Sub-base to include compacted subgrade (to 90% relative compaction, 4" minimum depth of approved compacted aggregate base (95% relative compaction). Compacted depth of base aggregate to be field observed and verified to a depth as needed to establish the proposed grades underneath a concrete slab that is below the rubber tiles; thicknesses of both materials to be determined by the Contractor based upon site conditions and finished grade requirements. Any discrepancies between grades must be brought to the attention of owner's representative 48 hours prior to starting scope of work. Refer to compaction specifications.

Examination

Examine areas to receive playground safety surfacing tiles. Notify responsible parties if areas are not acceptable. Do not begin installation until unacceptable conditions have been corrected.

Preparation

Prepare subsurface in accordance with manufacturer's instructions to ensure proper support and drainage for playground safety surfacing tiles.

· Notes: Specify subsurface of granular aggregate, concrete, or asphalt. It is critical that a proper subsurface drainage system be constructed or the tile surface may not stay level and may cause damage to surfacing.

Concrete Subsurface:

- Concrete subsurface shall be as specified. Apply troweled finish. DO NOT broom finish.
- Ensure concrete is sound with no loose material.
- Ensure concrete is a minimum of 28 days old.
- Power wash existing concrete in accordance with manufacturer's instructions.

Installation

Install interlocking tiles in accordance with manufacturer's instructions at locations indicated.

- Ensure prepared subsurface and tiles are dry and clean. Layout tile surface in accordance with manufacturer's instructions.
- Install tiles in single installation session, if possible.
- Do not install less than 1/3 of a full tile or slivers of rubber tiles on edges, if required, change outside edge pattern by cutting one tile in half and placing a larger tile as cut edge tile.

Additional material

Assume wasted material for edge cuts. Supply owner an additional 2% of each tile for each height upon project completion.

Adhesive – See manufacturers Installation Instructions

- Confirm proper concrete temperature prior to adhesive placement.
- Clean concrete surface to manufacturer's specifications prior to placement of adhesives.

4. Concrete Specifications

Orange Book Standards

RELEVENT SECTIONS

- A. 312.00 PCC FLATWORK, CURBS, DITCHES AND SLOPE PAVING
- B. 336.10 PCC SAMPLING AND TESTING
- C. 337.01 COMPOSITION OF MIXTURES D. 337.10 PCC STRUCTURES, SLOPE PAVING, FLATWORK AND CURBS.

www.rtcwashoe.com/orangebook

 NOTE: it is the responsibility of the contractor to verify existing subgrade soil depths prior to bid submission. Any discrepancies must be brought to the attention of City of Sparks (7) seven days prior to bid deadline.

4. Installation: Conform strictly to manufacturer's instructions and/or specifications using all appropriate materials, tools, and accessories as required. Use only experienced personnel trained in playground construction (See quality assurance in Part 1 above).

5. Protection: Before construction begins, provide 6' metal security fencing around all play areas. Maintain the fencing until after completion and final approval by project manager and owner. Protect existing concrete, existing asphalt and turf from equipment damage. Replace damaged concrete/asphalt or turf at no expense to owner.

6. Inspection:

- Following the project managers inspection of the completed installation, perform repairs as necessary to meet or exceed requirements for fit and finish and the specifications and guidelines as referenced above.
- It is recommended that all proposed equipment (including correct play equipment installed height), fall safety zones, and fall safety material be inspected by a certified playground safety inspector during all stages of construction.
- Upon completion of construction the contractor is to provide an inspection (with pictures) by a certified playground safety inspector and deliver the inspection to the

7. As-built plans: Provide to project manager (3) three sets of as-built plans indicating the following items (if applicable).

- Trench drain locations, drain inlet locations, drain sleeve location, drain pipe location, drain end location, drain sump location, or any irrigation modifications/installations.
- Take measurements from (2) two fixed points and include the measurements on the as-built plan.

8. Warranty: The Contractor shall warranty that all work performed shall be free of any defects in materials and workmanship. Upon notice in writing, within (1) one year of acceptance of substantial completion, the Contractor shall, at no cost to the Owner, make all necessary repairs or replacements of defective work in question. During this period of warranty, the Owner shall perform normal maintenance and cleaning of the playground safety surfaces.

PART 4 - MATERIAL INSTALLATION

1. Drain System

A. Drainage Pipe (as specified on the plans):

Contractor to show written documentation that all proposed grades have been verified to ensure that the drains have positive drainage away from all play areas.

2. Playground Equipment **Delivery and Storage**

It is the responsibility of the contractor to ensure that all materials to be properly protected from weather and theft. Installation

Additional Concrete details:

Joint Cutting


In concrete pad beneath rubber tiles, cut or trowel 1" deep cuts on 7'-8' centers in two directions. Vacuum dust out of cuts prior to placement of filler. Install Sikaflex selfleveling adhesive in joints to prevent water buildup.

Fall safety use zones shall be identified (as per ASTM standards) and marked for each piece of play equipment prior to forming concrete. Zones shall be identified by a Certified Safety Playground Inspector. P.C.C. Sidewalk

Sidewalk concrete to be constructed per "P.C.C. Sidewalk " detail notes. See plan set for Sidewalk detail.

Playground Concrete Pad Concrete pad below playground to be troweled smooth finish.



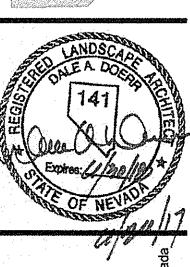

O

Revision Date


LA No: 257-504-08-16 Designed: DD

Checked: RWH Date: 6/20/17


Drawn: 665

26-Jun-17		PANEL:		L1			LOCATION:		METER P	METER PEDESTAL	
YPE DESCRIPTION	LOAD	BKR	CIR	Α	В	CIR	BKR	LOAD	DESCRIPTION	TYI	
E IRRIGATION CONTROL	60	20	1	60		2			SPACE		
SPARE		20	3		: 0	4			SPACE		
SPARE		20	5	0		6			SPACE		
SPARE		20	7		0	8			SPACE	Ì	
SPACE			9	0		10			SPACE	 	
SPACE			11		0	12			SPACE		
SPACE			13	0		 14			SPACE		
SPACE			15		0	16			SPACE		
SPACE			17	0		18			SPACE		
SPACE			19		0	20			SPACE		
				60	0						
COPPER BUS SIZE:	1125				0	STAN	NDARD		INOTES:		
	125 240			60 GROUND: MOUNTING:	0	 	NDARD ESTAL		NOTES: PANEL LOCATED WITH	HIN .	
OLTAGE:				GROUND:		 	ESTAL			HIN .	
/OLTAGE: PHASE:	240			GROUND: MOUNTING:		PED	ESTAL		PANEL LOCATED WITH	HIN .	
/OLTAGE: PHASE: VIRE:	240 1			GROUND: MOUNTING: ENCLOSURE:	CIRCUITS	PEDI NEM	ESTAL A 3R	0.1	PANEL LOCATED WITH	HIN .	
COPPER BUS SIZE: /OLTAGE: PHASE: VIRE: LUGS: BREAKER AIC RATING:	240 1 3			GROUND: MOUNTING: ENCLOSURE: # OF 1-POLE	CIRCUITS KVA:	PEDI NEM	ESTAL A 3R		PANEL LOCATED WITH	HIN .	
/OLTAGE: PHASE: VIRE: LUGS:	240 1 3 MCB			GROUND: MOUNTING: ENCLOSURE: # OF 1-POLE (CONNECTED I	CIRCUITS KVA:	PEDI NEM	ESTAL A 3R	0.1	PANEL LOCATED WITH	HIN .	


DRAV	VING SCHEDULE	
SHEET	DESCRIPTION	100% BID SET
EO	ELECTRICAL LEGEND, ONELINE DIAGRAM, PANEL SCHEDULE & DRAWING SCHEDULE	
EI	ELECTRICAL SPECIFICATIONS	•
E2	ELECTRICAL SITE PLAN	•
	TOTAL SHEETS IN ISSUE:	3

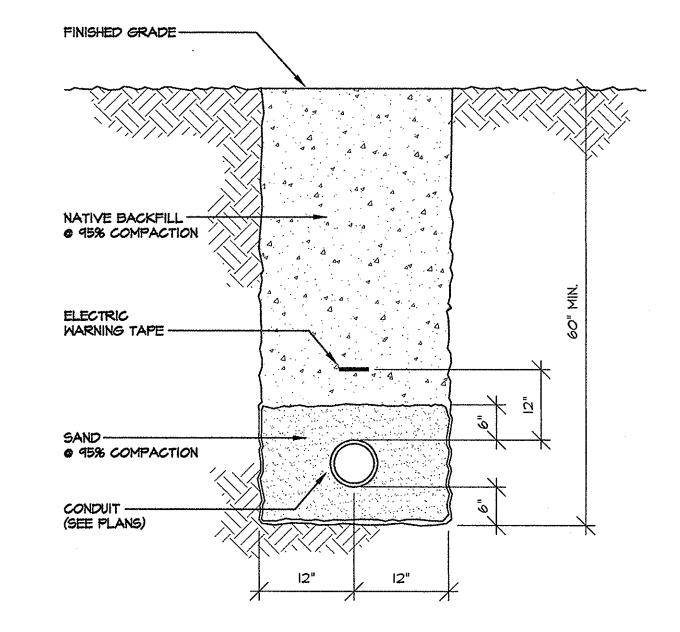



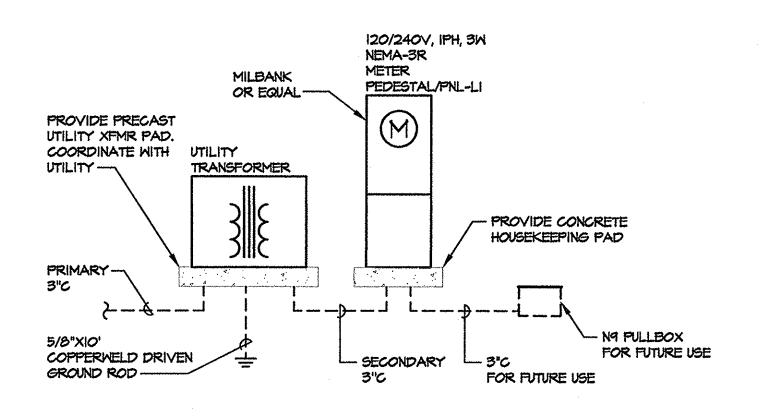



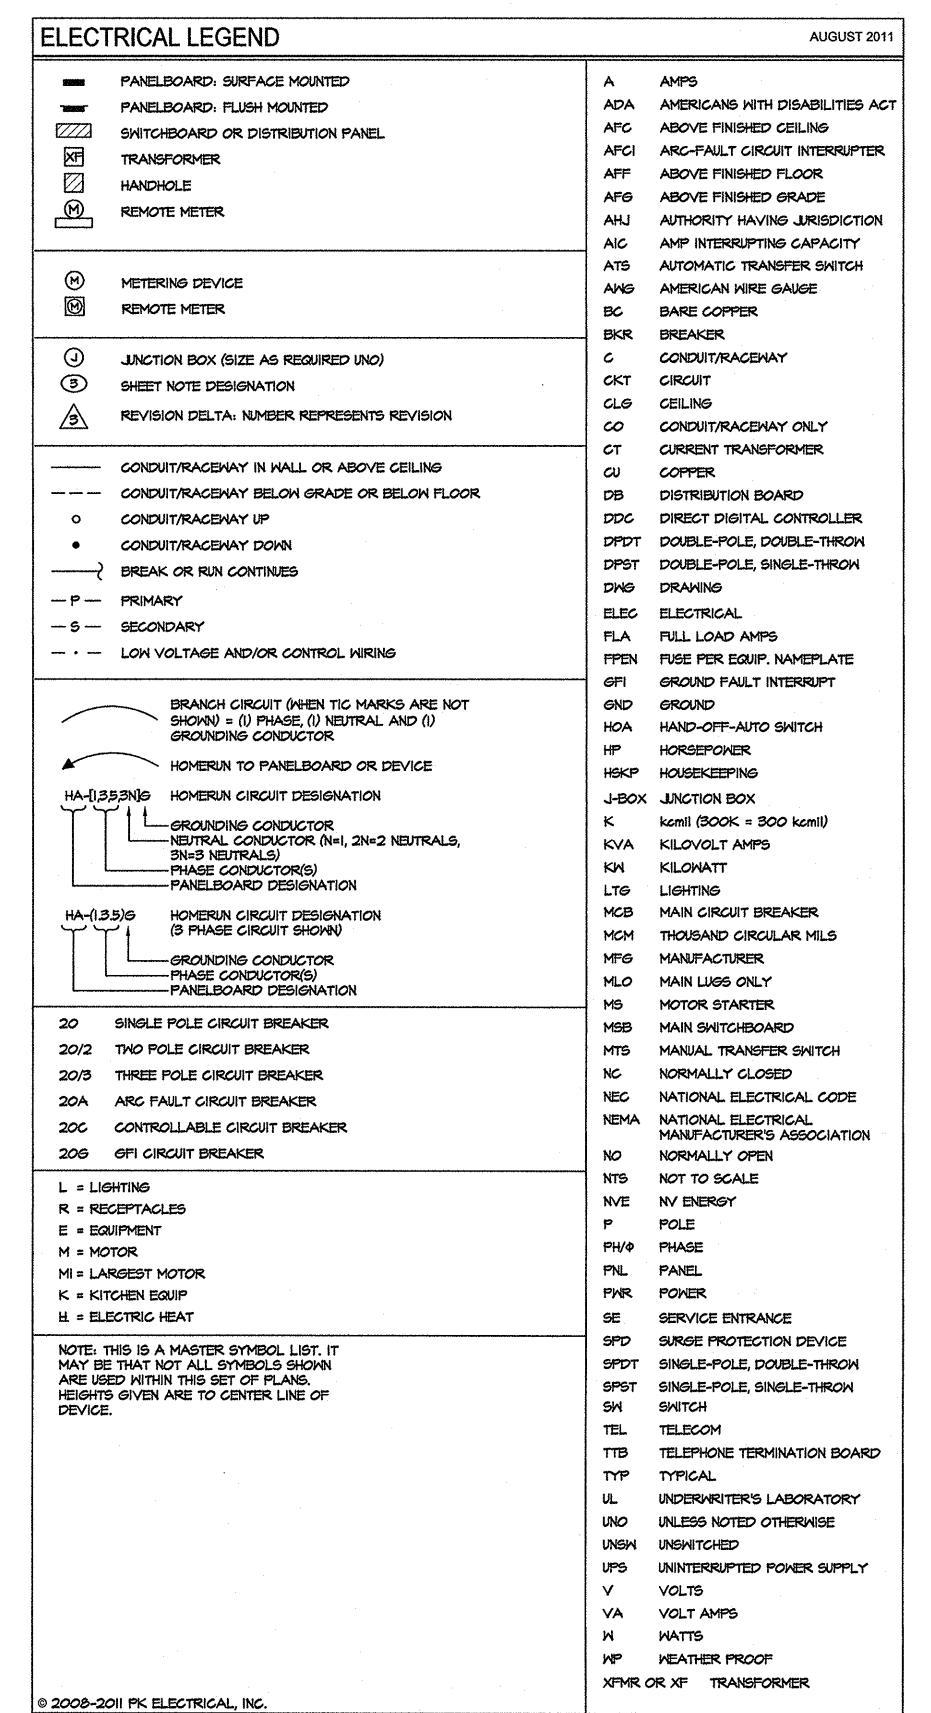



BID SET

iol arc 0

O

O F O

Revision Date

LA No: 257-504-08-16 Designed: HWO


Drawn: TPT Checked: JEG CAD File: L1-257-504 6/26/17

> Sheet EO

COPYRIGHT MATERIALS OF PK ELECTRICAL. ALL RIGHTS CONFERRED BY THE COPYRIGHT AND

FOR ANY PURPOSE WHATSOEVER WITHOUT THE PRIOR WRITTEN CONSENT OF PK ELECTRICAL.

SIMILAR LAWS ARE RESERVED TO PK ELECTRICAL. THESE MATERIALS SHALL REMAIN THE SOLE PROPERTY OF PK ELECTRICAL AND MAY NOT BE REPRODUCED, DISTRIBUTED TO OTHERS OR USED

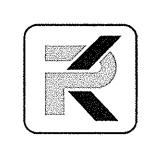

PK Electrical, Inc.

Engineering · Design · Consulting

Engineering · Design · Consulting

681 Sierra Rose Dr., Ste. B | Reno, Nevada 89511 | 775.826.9010
5105 DTC Parkway Suite 420 | Greenwood Village, Colorado 80111 | 720.481.3290
pkelectrical.com © 2008-2011 PK Electrical, Inc. 17014

Sheet

Cof

BID SET

Electrical Specification INVERTON SHORE City of Sparks, Parks Dep

0

3 5

p. Revision Date

LA No: 257-504-08-16
Designed: HWO

Designed: HWO

Drawn: TPT


Checked: #EC

Checked: JEG

CAD File: L1-257-504

6/26/17 Sheet

of

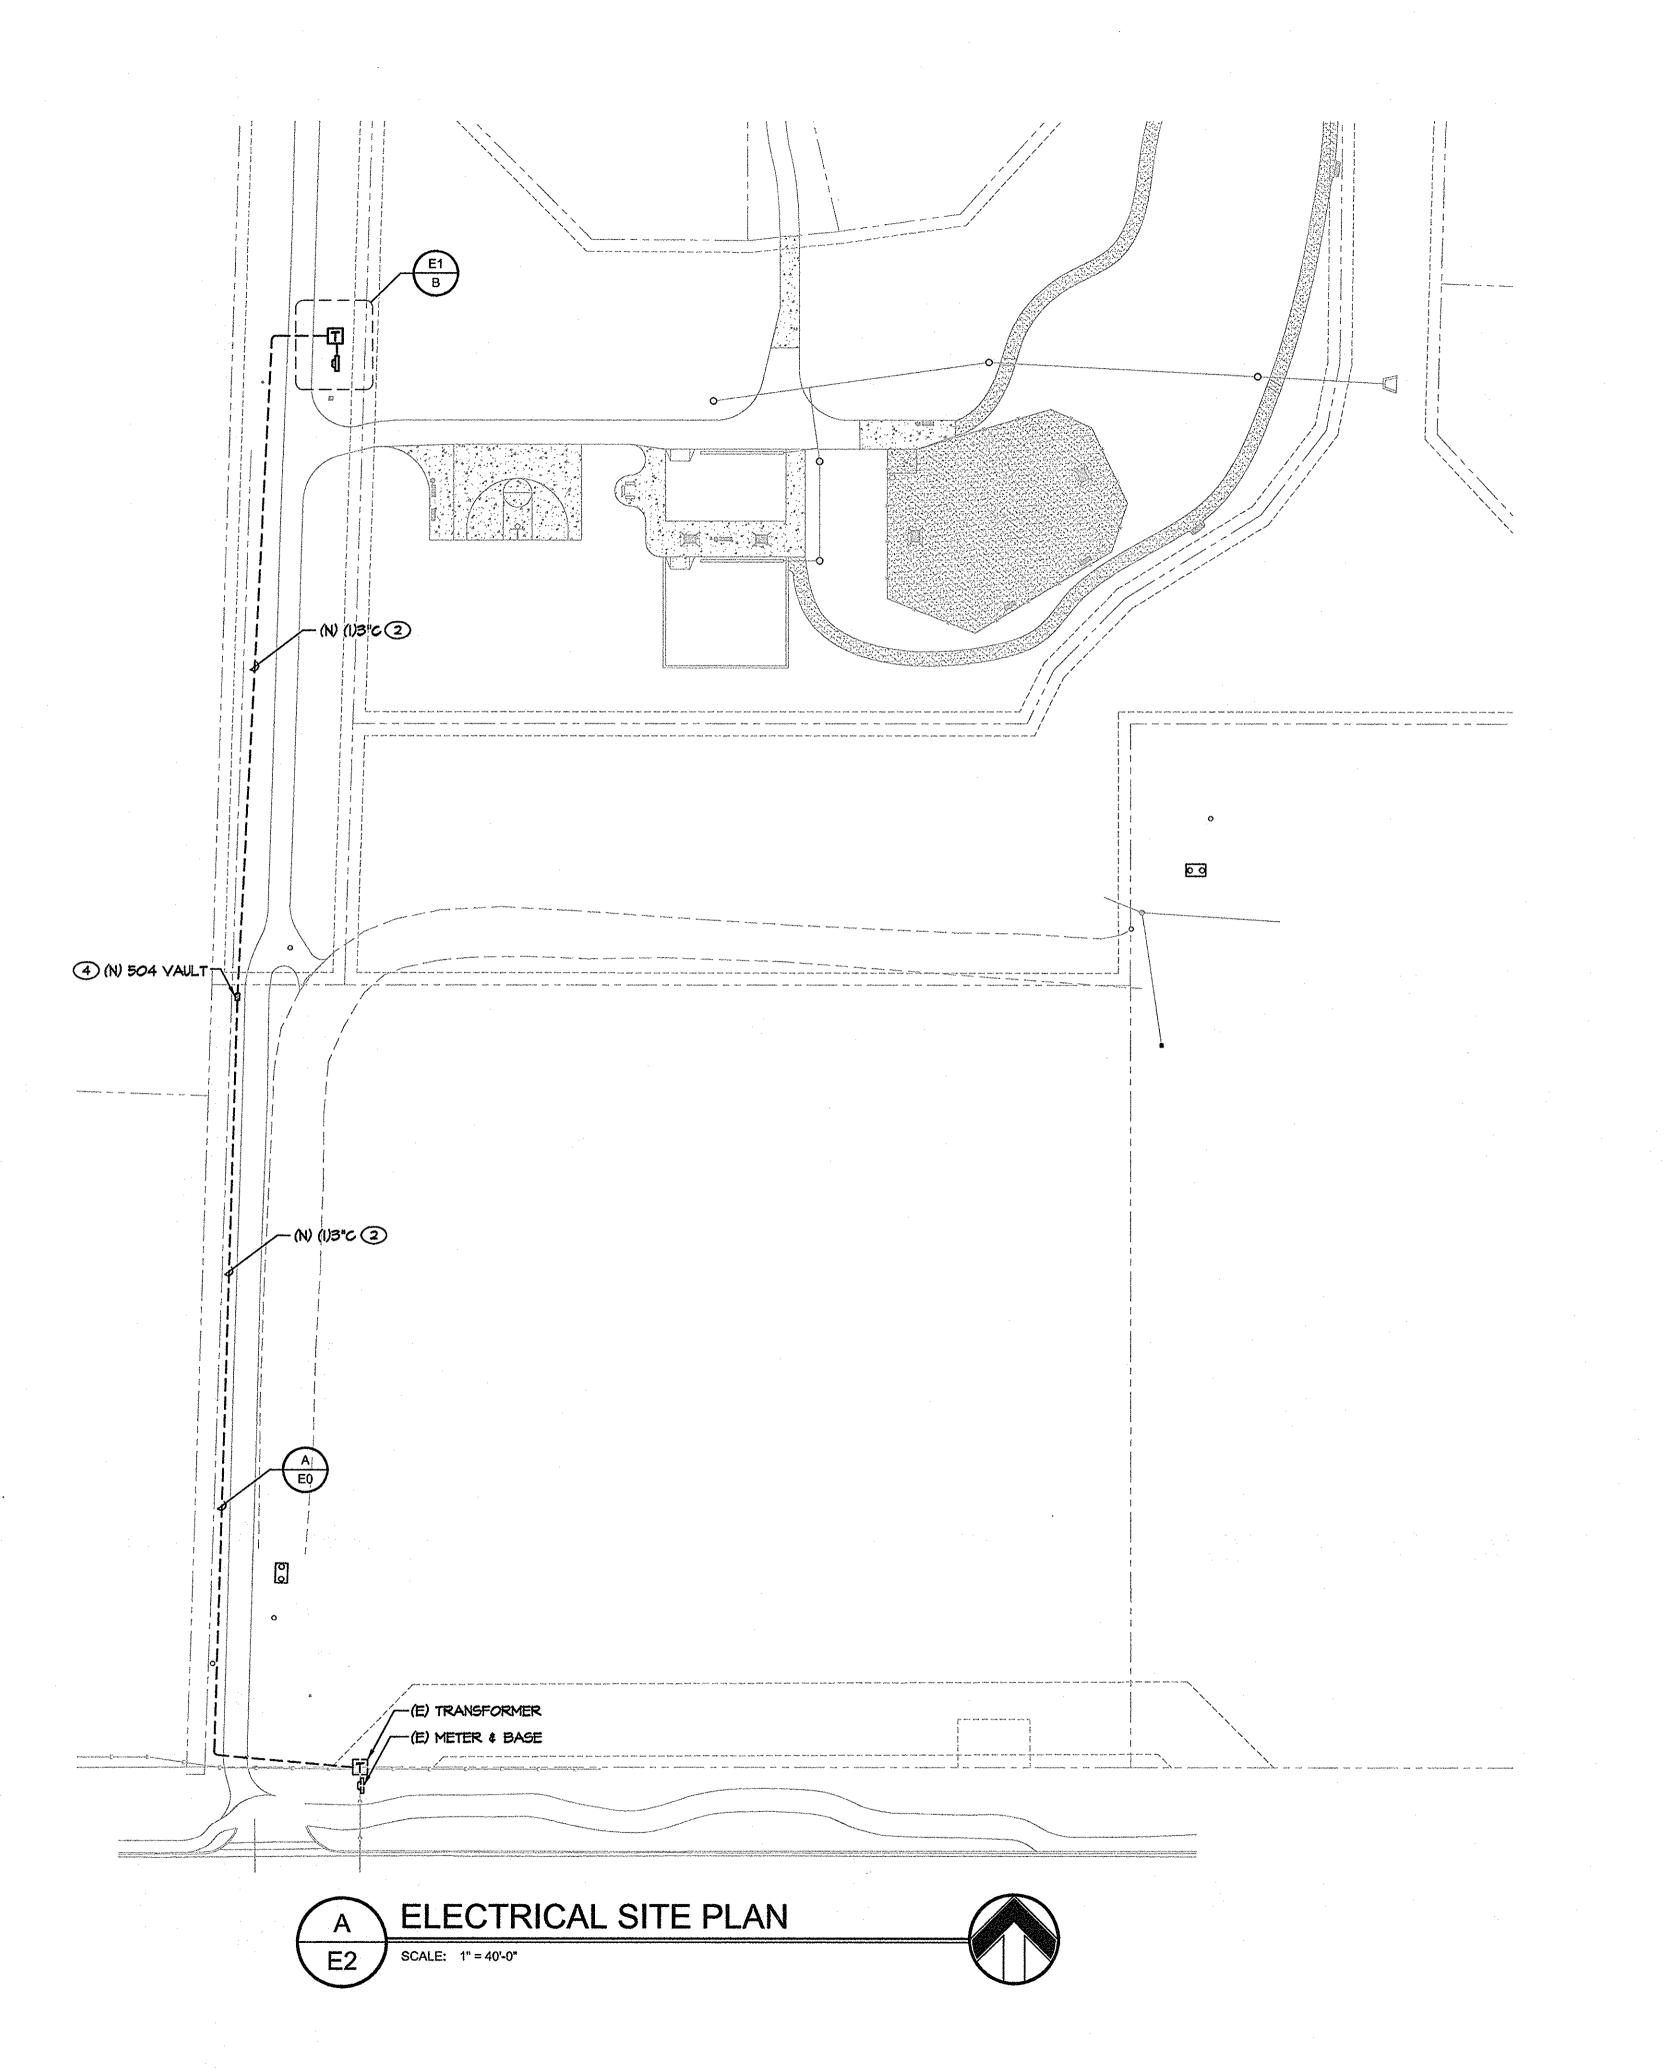


GENERAL NOTES

- (E) INDICATES EXISTING EQUIPMENT, (N) INDICATES NEW EQUIPMENT UNLESS NOTED OTHERWISE.
- 2. SEE ONELINE DIAGRAM FOR CONDUIT, WIRE SIZES AND EQUIPMENT REQUIREMENTS.
- 3. It is the contractor's responsibility to coordinate with applicable utility company's drawings and representatives for determining the exact responsibility of each party.
- 4. SEE NV ENERGY DRAWINGS FOR ALL WORK REQUIRED. CONTRACTOR SHALL BE RESPONSIBLE FOR INCLUDING ALL WORK REQUIRED IN BID. COORDINATE WITH NV ENERGY.
- 5. IT IS THE CONTRACTOR'S RESPONSIBILITY TO CALL I-800-227-2600 FOR LOCATES PRIOR TO DIGGING. IT IS ALSO THE CONTRACTORS RESPONSIBILITY TO LOCATE ALL NON-UTILITY UNDERGROUND ITEMS.
- 6. THE MAXIMUM NUMBER OF CONDUIT BENDS SHOULD NOT BE GREATER THAN 270 DEGREES BETWEEN
- PULLING STRUCTURES. THIS INCLUDES THE AGGREGATE OF ALL HORIZONTAL AND VERTICAL CHANGES.

 7. ALL CONDUIT, INNERDUCT, PULLBOXES AND VAULTS SHALL BE LABELED PER THE SPECIFICATIONS.
- 8. EACH CONDUIT AND INNERDUCT SHALL BE PROVIDED WITH A 1250 LBS. PULL ROPE.

SHEET NOTES

- IRRIGATION CONTROL TO BE MOUNTED AND SECURED WITHIN THE PEDESTAL. COORDINATE WITH THE LANDSCAPE ARCHITECT FOR IRRIGATION CONTROLLER DETAILS.
 - COORDINATE WITH UTILITIES FOR TRENCHING ROUTE.
- MILBANK CP3B "POWER TRANSFER" SERIES PEDESTAL. COORDINATE WITH NV ENERGY FOR SPECIFIC REQUIREMENTS (BYPASS MEANS, METER SOCKET, ETC.). COORDINATE EXACT STUB-UP AND PEDESTAL LOCATION WITH CIVIL PRIOR TO CONSTRUCTION.
- (4) COORDINATE WITH NV ENERGY FOR VAULT TYPE AND REQUIREMENTS FOR PRIMARY SIDE OF SERVICE. SEE NV ENERGY DRAWINGS.
- 3 RUN 3"C FROM PEDESTAL TO NO PULLBOX FOR FUTURE USE.

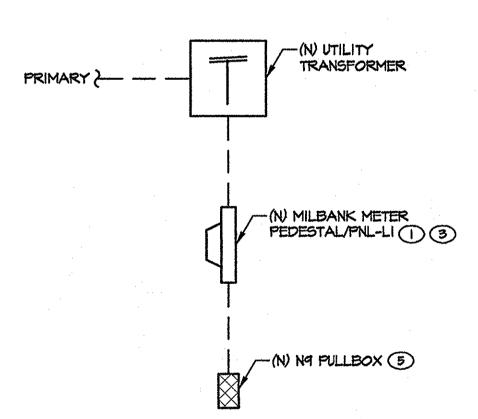

B ENLARGED METER PEDESTAL LOCATION

SCALE: 1/8" = 1'-0"



BID SET

PK Electrical, Inc.

Engineering · Design · Consulting

681 Slerra Rose Dr., Ste. B | Reno, Nevada 89511 | 775.826.9010
5105 DTC Parkway Suite 420 | Greenwood Village, Colorado 80111 | 720.481.325 pkelectrical.com © 2008-2011 PK Electrical, Inc.

17014

All orawn and written information at pearing herein shall not be duplicated, disclosed, or otherwise use without written consent.

tudioNevada Idscape architectur Sparks, NV 89431 (775) 323

the lan

CANSER OF SEASON OF SEASON

ELECTRICAL OF THE PRODUCT OF THE PRO

I SHORES PAI s, Parks Departmen

> SILVERT City of Sp

No. Revision Date

NOVICION DUC

LA No: 257-504-08-

Designed: HWO
Drawn: TPT

Checked: JEG

CAD File: L1-257-504

Date: 6/26/17

Sheet **E2** of