#### STANDARD ENGINEERING NOTES

- . THESE PLANS ARE SUBJECT TO THE INTERPRETATION OF INTENT BY THE ENGINEER. ALL QUESTIONS REGARDING THESE PLANS SHALL BE PRESENTED TO THE ENGINEER. ANYONE WHO TAKES IT UPON THEMSELVES THE INTERPRETATION OF THE DRAWINGS OR MAKES REVISIONS TO THE SAME WITHOUT CONFERRING WITH THE DESIGN ENGINEER SHALL BE RESPONSIBLE FOR THE CONSEQUENCES THEREOF.
- PRIOR TO BIDDING THE WORK, THE CONTRACTOR SHALL THOROUGHLY SATISFY
  HIMSELF AS TO THE ACTUAL CONDITIONS, REQUIREMENTS OF THE WORK AND EXCESS
  OR DEFICIENCY IN QUANTITIES. NO CLAIMS SHALL BE MADE AGAINST THE
  OWNER/DEVELOPER OR ENGINEER FOR ANY EXCESS OR DEFICIENCY THEREIN, ACTUAL
  OR RELATIVE.
- 3. THE ENGINEER SHALL NOT BE RESPONSIBLE FOR MEANS, METHODS, TECHNIQUES, SEQUENCES, PROCEDURES OR SAFETY PRECAUTIONS OR PROGRAMS UTILIZED IN CONNECTION WITH THE WORK, AND WILL NOT BE RESPONSIBLE FOR THE CONTRACTOR'S FAILURE TO CARRY OUT THE WORK IN ACCORDANCE WITH THE CONTRACT DOCUMENTS.
- 4. THE ENGINEER SHALL NOT BE RESPONSIBLE FOR COORDINATING THE RELOCATION OF UTILITIES, LIGHTS, IRRIGATION ETC.
- 5. THE CONTRACTOR IS TO VERIFY THE LOCATION, ELEVATION, CONDITION, AND PAVEMENT CROSS-SLOPE OF ALL EXISTING SURFACES AT POINTS OF TIE-IN AND MATCHING, PRIOR TO THE START OF MAINTENANCE. SHOULD EXISTING LOCATIONS, ELEVATIONS, CONDITION, OR PAVEMENT CONFLICT WITH ADA OR NFHS PLAYING FIELD REQUIREMENTS, THE CONTRACTOR SHALL NOTIFY THE OWNER CONTACT IMMEDIATELY FOR DIRECTION ON HOW TO PROCEED PRIOR TO COMMENCEMENT OF WORK. THE CONTRACTOR ACCEPTS RESPONSIBILITY FOR ALL COSTS ASSOCIATED WITH CORRECTIVE ACTION IF THESE PROCEDURES ARE NOT FOLLOWED.
- 6. THE CONTRACTOR SHALL PROTECT AND MAINTAIN ALL EXISTING UTILITIES ON THE SITE ANY DAMAGE TO EXISTING UTILITIES, WHETHER SHOWN OR NOT ON THE DRAWING, SHALL BE REPAIRED/REPLACED AT THE CONTRACTOR'S EXPENSE. EXISTING SURFACE FEATURES AND FENCING SHALL BE REPLACED IN KIND.
- 7. THE ENGINEER AND APPLICABLE AGENCY MUST APPROVE, PRIOR TO MAINTENANCE, ANY ALTERATION, OR VARIANCE FROM THESE PLANS. ANY VARIATIONS FROM THESE PLANS SHALL BE PROPOSED AND TRANSMITTED TO THE ENGINEER.
- 8. ANY INSPECTION BY ANY JURISDICTIONAL AGENCY, SHALL NOT, IN ANY WAY, RELIEVE THE CONTRACTOR FROM ANY OBLIGATION TO PERFORM THE WORK IN STRICT COMPLIANCE WITH APPLICABLE CODES AND AGENCY REQUIREMENTS.
- 9. ANY HAULING PERMITS REQUIRED ARE TO BE OBTAINED BY THE CONTRACTOR AT NO ADDITIONAL COST TO THE OWNER
- 10. ANY WATER ACCESS IS TO BE OBTAINED BY THE CONTRACTOR AT NO ADDITIONAL COST TO THE OWNER. FIRE HYDRANT ACCESS MUST BE PERMITTED AND METERED BY THE WATER AUTHORITY AT NO ADDITIONAL COST TO THE OWNER.
- 11. CONTRACTOR IS RESPONSIBLE FOR PROTECTING ALL STORM DRAIN PIPES AND DRAINAGE FACILITIES FROM DAMAGE DURING ALL STAGES OF WORK.
- 2. ALL WORK SHALL BE INSTALLED IN ACCORDANCE WITH THE STANDARD SPECIFICATION DOCUMENTS PROVIDED WITH THIS PLAN SET.

#### STANDARD NOTES

- 1. WORK HOURS: THE CONTRACTOR SHALL LIMIT ALL WORK AND RELATED ACTIVITIES TO THE HOURS DICTATED IN THE SPECIFICATIONS OR LOCAL ORDINANCES WHICHEVER IS MORE STRINGENT. ALL DEVIATIONS FROM THESE STATED TIMES MUST BE COORDINATED WITH THE CITY OF SPARKS PROJECT MANAGER 72 HOURS IN ADVANCE.
- 2. DUST CONTROL: PRIOR TO THE COMMENCEMENT OF ANY WORK CONTRACTOR SHALL SUBMIT TO THE WASHOE COUNTY HEALTH DISTRICT AIR QUALITY MANAGEMENT (WCHD-AQM) A PLAN FOR DUST CONTROL. THE PLAN SHALL BE IN ACCORDANCE WITH NEVADA STATE LAW. WHEN APPROVED BY THE CITY, SHALL BE REFERRED TO AS THE DUST CONTROL PLAN AND SHALL BE DEEMED A PART OF THIS AGREEMENT.
- 3. WORK FENCING: CONTRACTOR SHALL PROVIDE, INSTALL, AND MAINTAIN A TEMPORARY FENCED AREA ENCOMPASSING ALL MAINTENANCE RELATED ACTIVITIES. FENCING TO BE CHAIN LINK (NO BARB WIRE) A MINIMUM 6' HEIGHT WITH LOCKABLE GATES. IT SHALL ENCLOSE THE ENTIRE STAGING/STORAGE AREA, MAINTENANCE ACTIVITY, VEHICLES, EQUIPMENT, AND ALL MATERIALS. THE FENCE WILL REMAIN IN PLACE UNTIL THE OWNER'S REPRESENTATIVE REQUESTS REMOVAL. THE GATES SHALL BE LOCKED BY THE CONTRACTOR AT ALL TIMES THAT THE CONTRACTOR IS NOT ON SITE.
- 4. SAFETY: THE CONTRACTOR SHALL ABIDE BY ALL FEDERAL, STATE, COUNTY, AND CITY OF SPARKS SAFETY REQUIREMENTS. ALL VEHICULAR TRAFFIC ENTERING OR DEPARTING AREAS NOT ENCLOSED WITHIN THE FENCED AREA OR ESTABLISHED PARKING LOT SHALL BE ESCORTED ON FOOT BY THE CONTRACTOR'S PERSONNEL. THIS ESCORT WILL TO ASCERTAIN NO INDIVIDUALS ARE IN HARMS WAY AND BE MAINTAINED UNTIL THE VEHICLE HAS ATTAINED A SAFE LOCATION OR THE PARKING LOT.
- 5. UTILITIES: ALL REQUIRED UTILITY SHUT-DOWNS SHALL BE COORDINATED BY THE CONTRACTOR WITH THE APPROVAL OF THE CITY OF SPARKS PROJECT MANAGER 72 HOURS IN ADVANCE VIA EMAIL. SHUT-DOWNS WILL INCLUDE AN ESTIMATE OF THE REQUIRED DOWN TIME. A DISTURBANCE PERMIT MUST BE SUBMITTED TO THE CITY OF SPARKS PROJECT MANAGER.
- 6. COORDINATION: CONTRACTOR SHALL NOT CONVERSE OR COORDINATE WITH THE CITY OF SPARKS WITHOUT PERMISSION OF THE CITY OF SPARKS PROJECT MANAGER. ALL PROJECT COORDINATING, MODIFICATIONS OR CONTRACTUAL ISSUES MUST BE MADE THROUGH THE CITY OF SPARKS PROJECT MANAGER AND ENGINEER.

# CITY OF SPARKS GOLDEN EAGLE REGIONAL PARK FIELDS 11,12 & 15 SYNTHETIC TURF OUTFIELD RESURFACING PROJECT

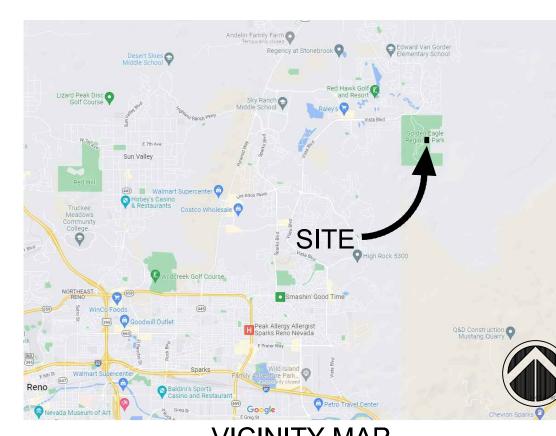
BID NO. 25/26-001 PWP NO. WA-2025-501



**LOCATION MAP** 



SITE ACCESS AND LOGISTICS



VICINITY MA

#### SHEET INDEX

00 COVER SHEET

F01 TEMPORARY BMP PLAN & DETAILS
F02 EXISTING CONDITIONS & DEMOLITION PLAN

PF03 DRAINAGE PLAN
PF04 SURFACING PLAN
PF05 GRAPHICS PLAN

PF06 DETAILS

#### **OWNER**

AMBER L. SOSA, PE CITY ENGINEER CITY OF SPARKS 431 PRATER WAY SPARKS, NV 89431

#### **ENGINEER**

SAMUEL WISE, PE LLOYD CONSULTING GROUP LLC 10836 PEBBLE HILL DRIVE RENO, NV 89521 (775) 996-3882 EMAIL: SWISE@LLOYDENGINEERS.COM

### SCOPE OF WORK

THE PROJECT SCOPE OF WORK INCLUDES REMOVAL OF EXISTING SOFTBALL FIELD SYNTHETIC TURF OUTFIELDS, REHABILITATION OF DRAINAGE TRENCHES, AND INSTALLATION OF NEW SYNTHETIC TURF FIELD SYSTEM (INCLUDING SYNTHETIC TURF, AND INFILL) AT GOLDEN EAGLE REGIONAL PARK FIELDS 11, 12, & 15.

#### **BENCHMARK**

DATUM: NAVD 88
PROJECT BENCHMARK = CITY OF SPARKS BENCHMARK NO. 110
HAVING AN ELEVATION OF 4509.99'

## **BASIS OF BEARING**

THE BASIS OF BEARING FOR THIS SURVEY IS BASED ON THE NEVADA STATE PLANE COORDINATE SYSTEM OF 1983, WEST ZONE, NAD 83/94, DISTANCES SHOWN ARE GROUND DISTANCES USING A PROJECT COMBINED GRID TO GROUND SCALE FACTOR OF 1.000197939.

#### STANDARD BMP NOTES

STANDARD NOTE NO. 1: THE OWNER, SITE DEVELOPER, CONTRACTOR AND/OR THEIR AUTHORIZED AGENTS
SHALL EACH DAY REMOVE ALL SEDIMENT, MUD, DEBRIS, OR OTHER POTENTIAL
POLLUTANTS THAT MAY HAVE BEEN DISCHARGED TO, OR ACCUMULATE IN, THE PUBLIC
RIGHTS OF WAYS OF THE CITY OF SPARKS AS A RESULT OF MAINTENANCE ACTIVITIES
ASSOCIATED WITH THIS SITE DEVELOPMENT OR MAINTENANCE PROJECT. SUCH
MATERIALS SHALL BE PREVENTED FROM ENTERING THE STORM SEWER SYSTEM.

STANDARD NOTE NO. 2: ADDITIONAL SITE DISCHARGE BEST MANAGEMENT PRACTICES MAY BE REQUIRED OF THE OWNER AND HIS OR HER AGENTS DUE TO UNFORESEEN EROSION PROBLEMS OR IF THE SUBMITTED PLAN DOES NOT MEET THE PERFORMANCE STANDARDS SPECIFIED IN THE TRUCKEE MEADOWS CONSTRUCTION SITE BEST MANAGEMENT PRACTICES HANDBOOK.

STANDARD NOTE NO. 3: TEMPORARY OR PERMANENT STABILIZATION PRACTICES WILL BE INSTALLED ON DISTURBED AREAS AS SOON AS PRACTICABLE AND NO LATER THAN 14 DAYS AFTER THE ACTIVITY IN THAT PORTION OF THE SITE HAS TEMPORARILY OR PERMANENTLY CEASED.

STANDARD NOTE NO. 4: AT A MINIMUM, THE CONTRACTOR OR HIS AGENT SHALL INSPECT ALL DISTURBED AREAS, AREAS USED FOR STORAGE OF MATERIALS AND EQUIPMENT THAT ARE EXPOSED TO PRECIPITATION, VEHICLE ENTRANCE AND EXIT LOCATIONS AND ALL BMPS WEEKLY, PRIOR TO A FORECASTED RAIN EVENT AND WITHIN 24 HOURS AFTER ANY ACTUAL RAIN EVENT. THE CONTRACTOR OR HIS AGENT SHALL UPDATE OR MODIFY THE STORMWATER POLLUTION PREVENTION PLAN AS NECESSARY. SOME EXCEPTIONS TO WEEKLY

STANDARD NOTE NO. 5: ACCUMULATED SEDIMENT IN BMPS SHALL BE REMOVED WITHIN SEVEN DAYS AFTER A STORMWATER RUNOFF EVENT OR PRIOR TO THE NEXT ANTICIPATED STORM EVENT WHICHEVER IS EARLIER. SEDIMENT MUST BE REMOVED WHEN BMP DESIGN CAPACITY HAS BEEN REDUCED BY 50 PERCENT OR MORE.



960 W. ELLIOT ROAD SUITE 213 TEMPE, AZ 85284 PH 602.635.4226







GERP FIELDS 11, 12, AND 15 OUTFIELD RESURFACING

GOLDEN EAGLE REGIONAL PARK 6400 VISTA BLVD, SPARKS, NV

PM:	SAW
DRAWN:	SAW
DATE:	8/29/2025
PROJECT NO:	25-162

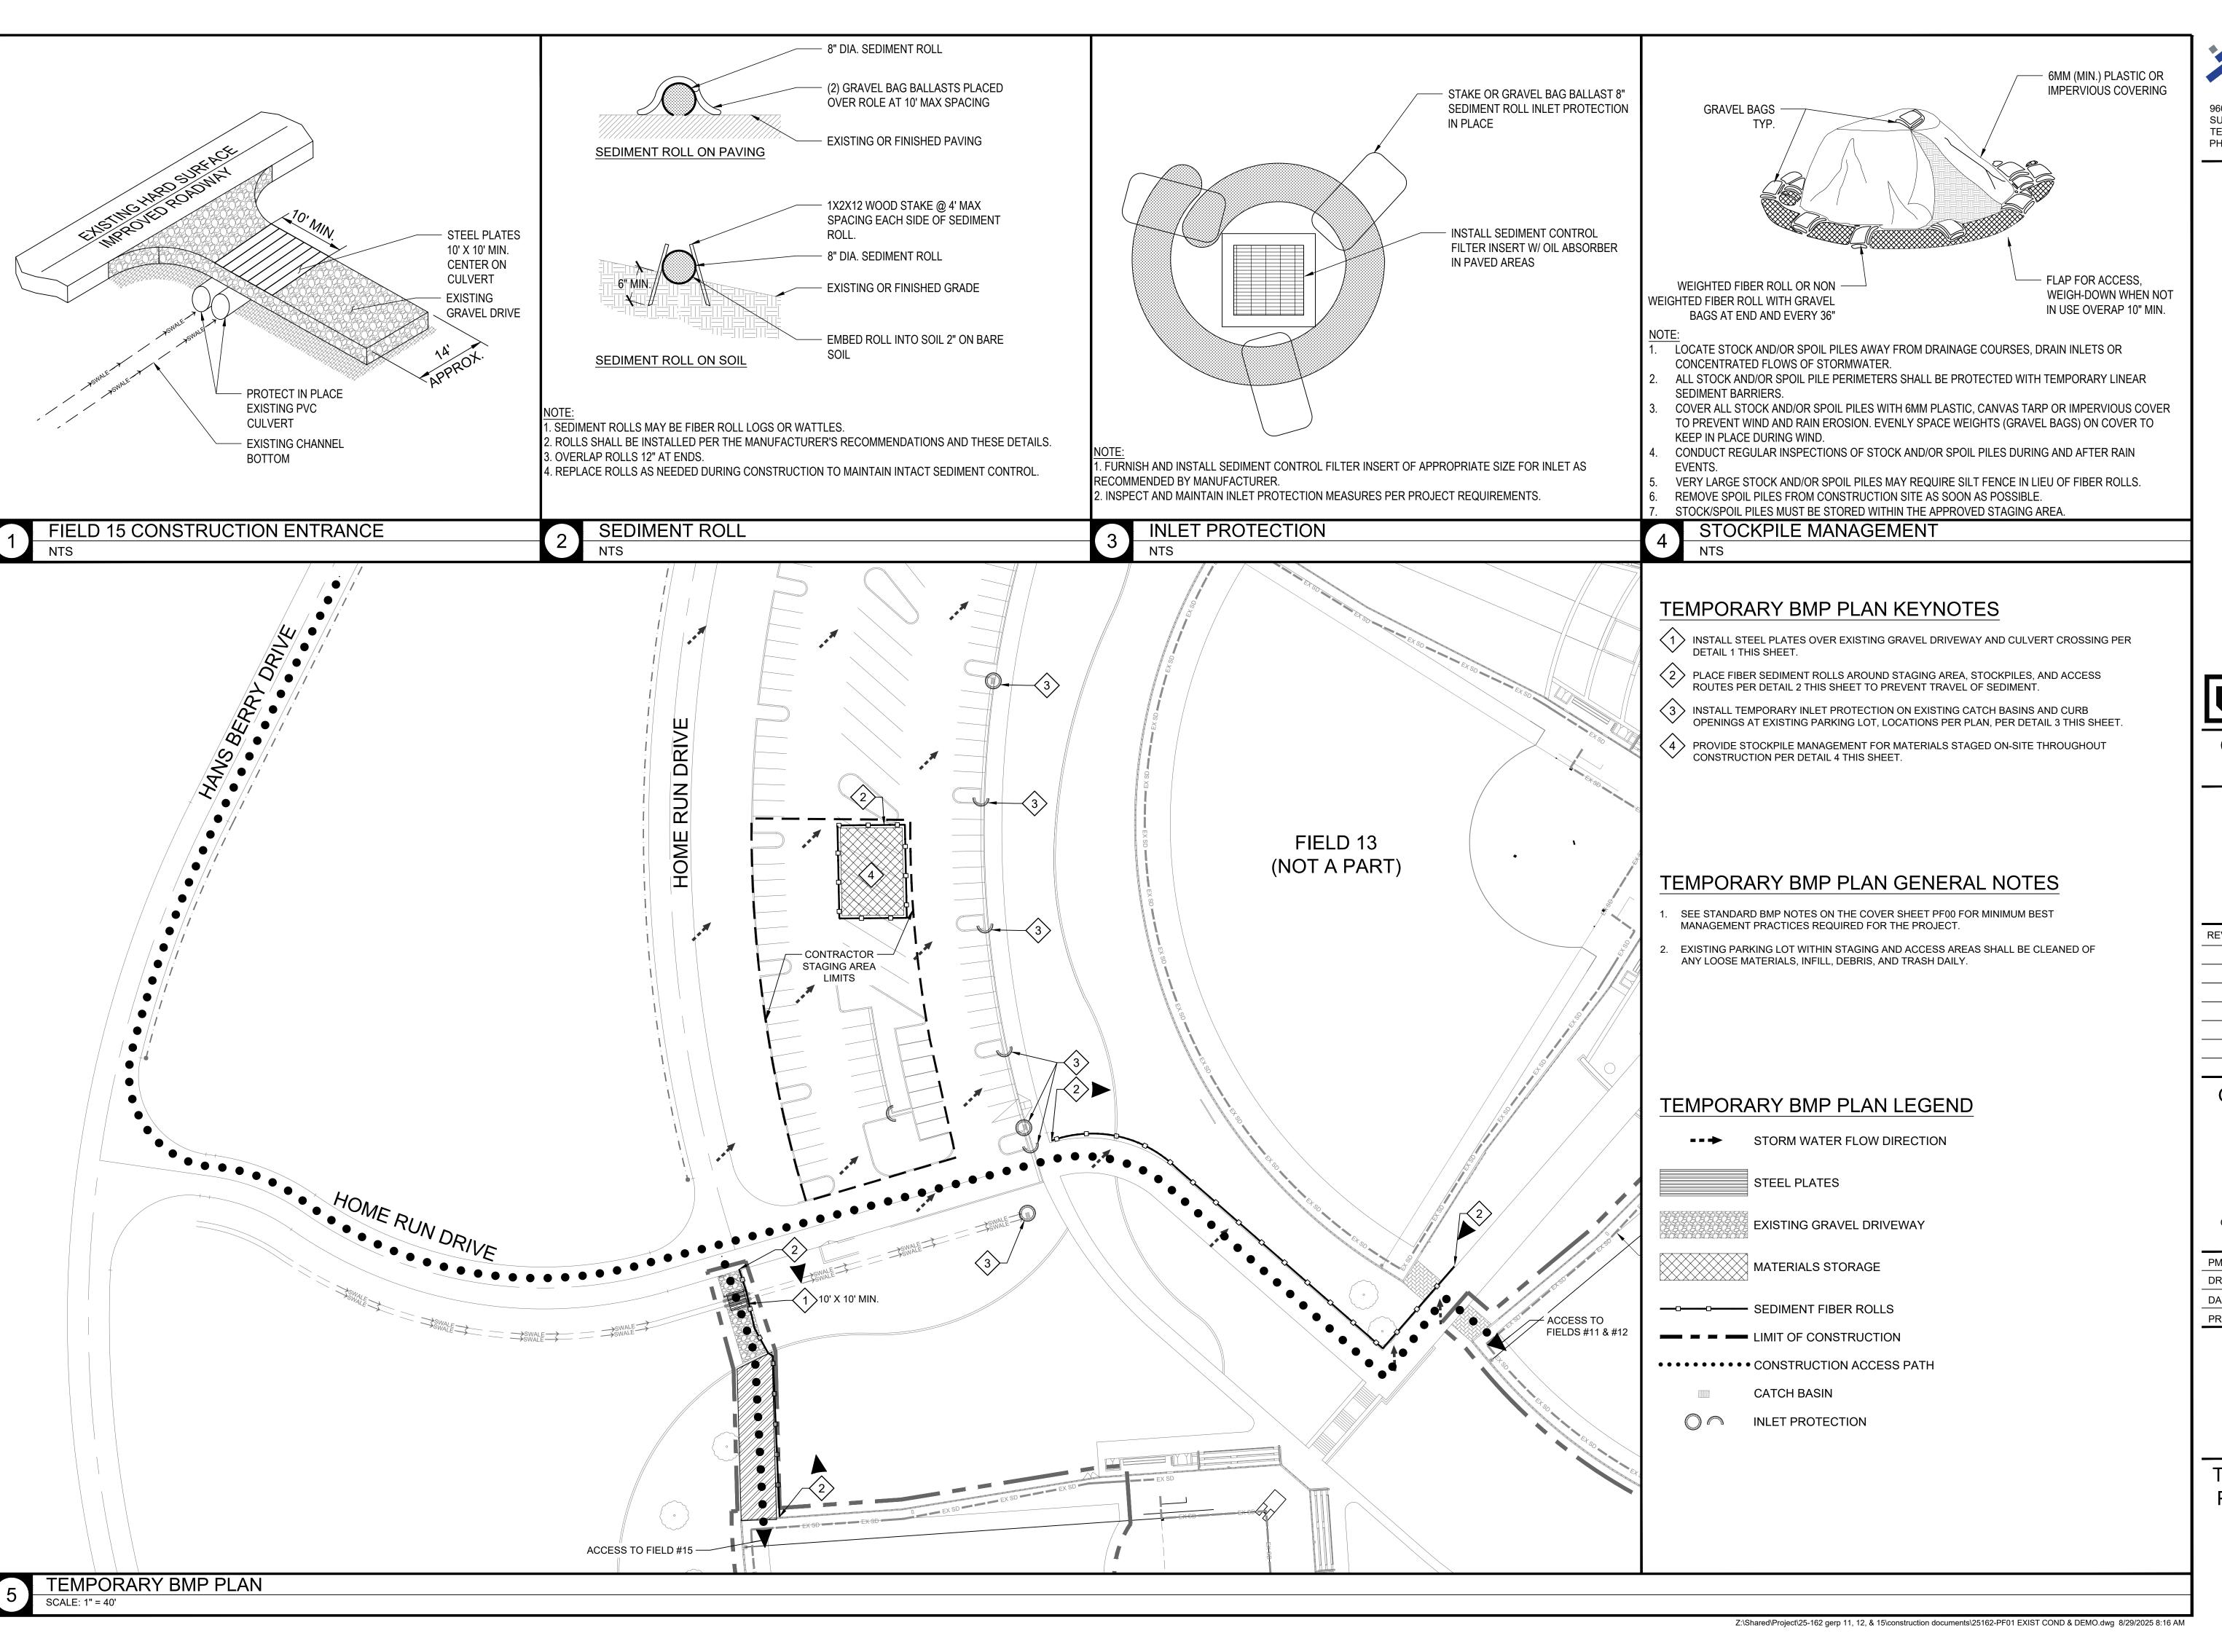
COVER SHEET

DIMO NO

PF00

SOME EXCEPTIONS MAY APPLY; REFER TO STORMWATER GENERAL PERMIT NVR100000.

INSPECTIONS MAY APPLY, SUCH AS FROZEN GROUND CONDITIONS OR SUSPENSION OF LAND DISTURBANCE ACTIVITIES. REFER TO STORMWATER GENERAL PERMIT NVR100000.



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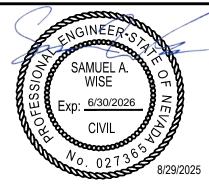
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CONSTRUCTION DOCUMENTS



REV.

GERP FIELDS 11, 12, AND 15 OUTFIELD RESURFACING

GOLDEN EAGLE REGIONAL PARK 6400 VISTA BLVD, SPARKS, NV

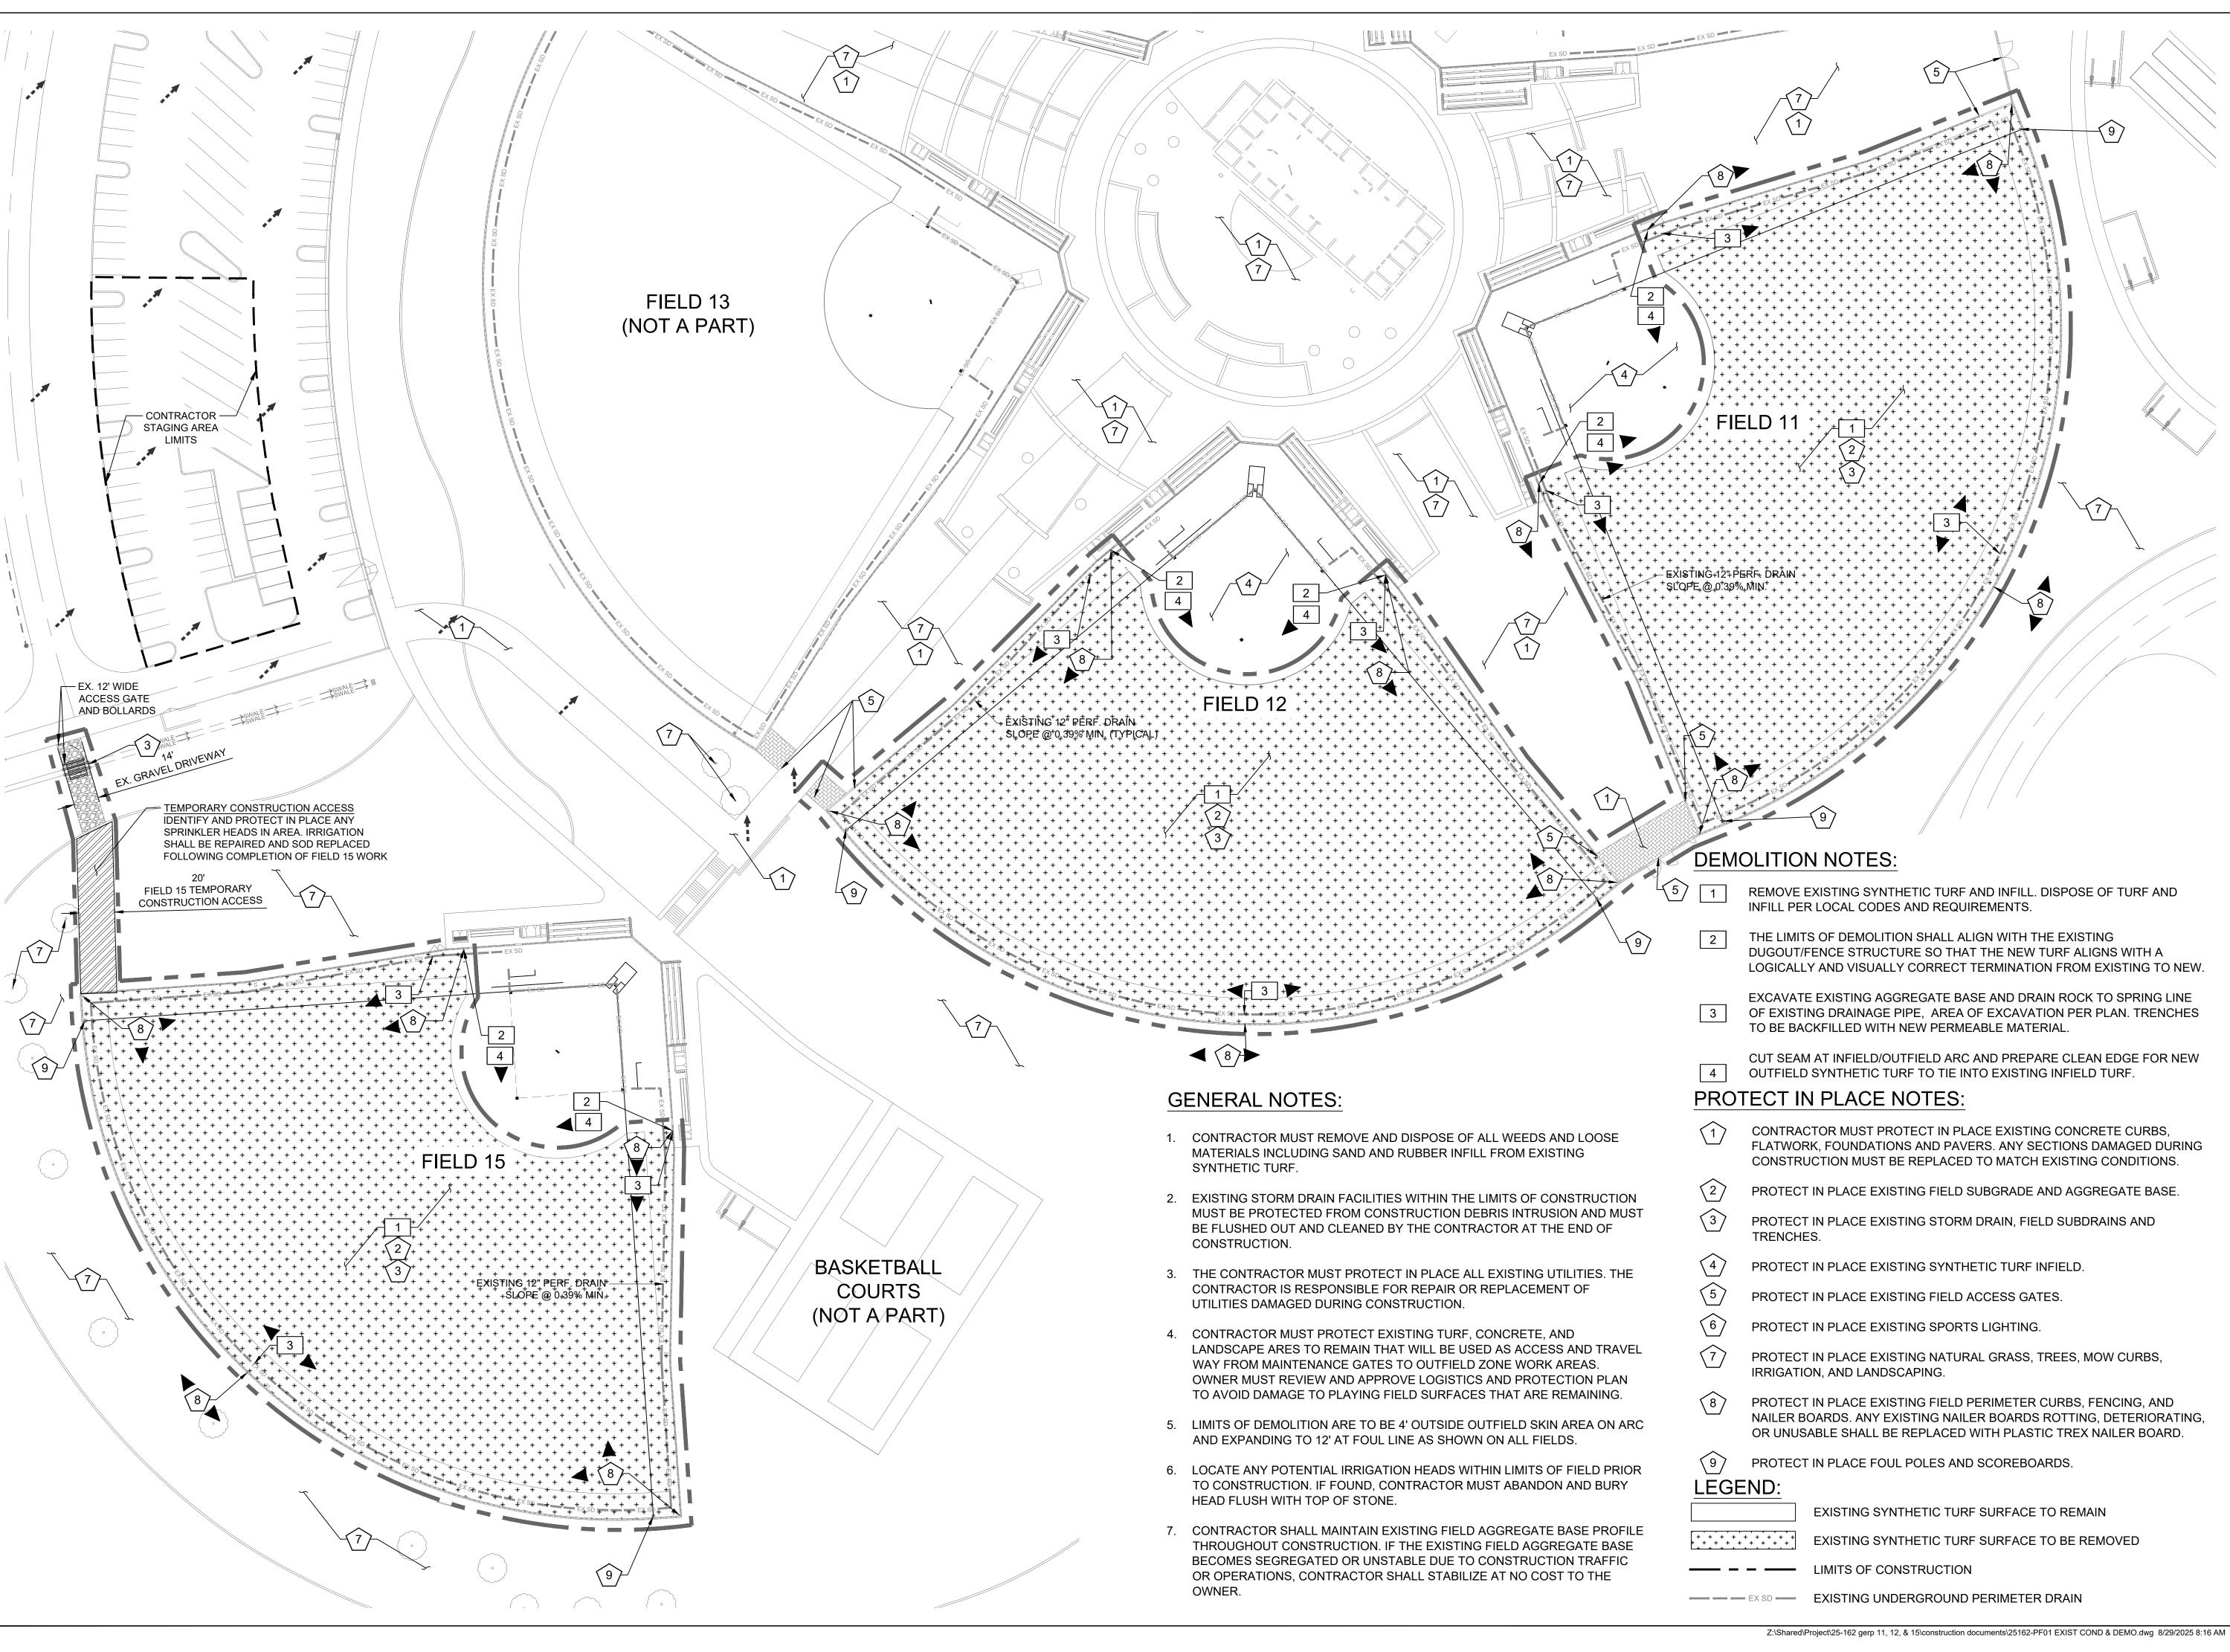
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SCALE: 1" = 40'

TEMPORARY BMP PLAN & DETAILS

DWG. NO.



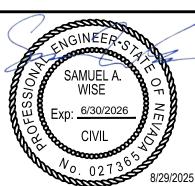


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# CONSTRUCTION DOCUMENTS



DEV/

GERP FIELDS 11, 12, AND 15 OUTFIELD RESURFACING

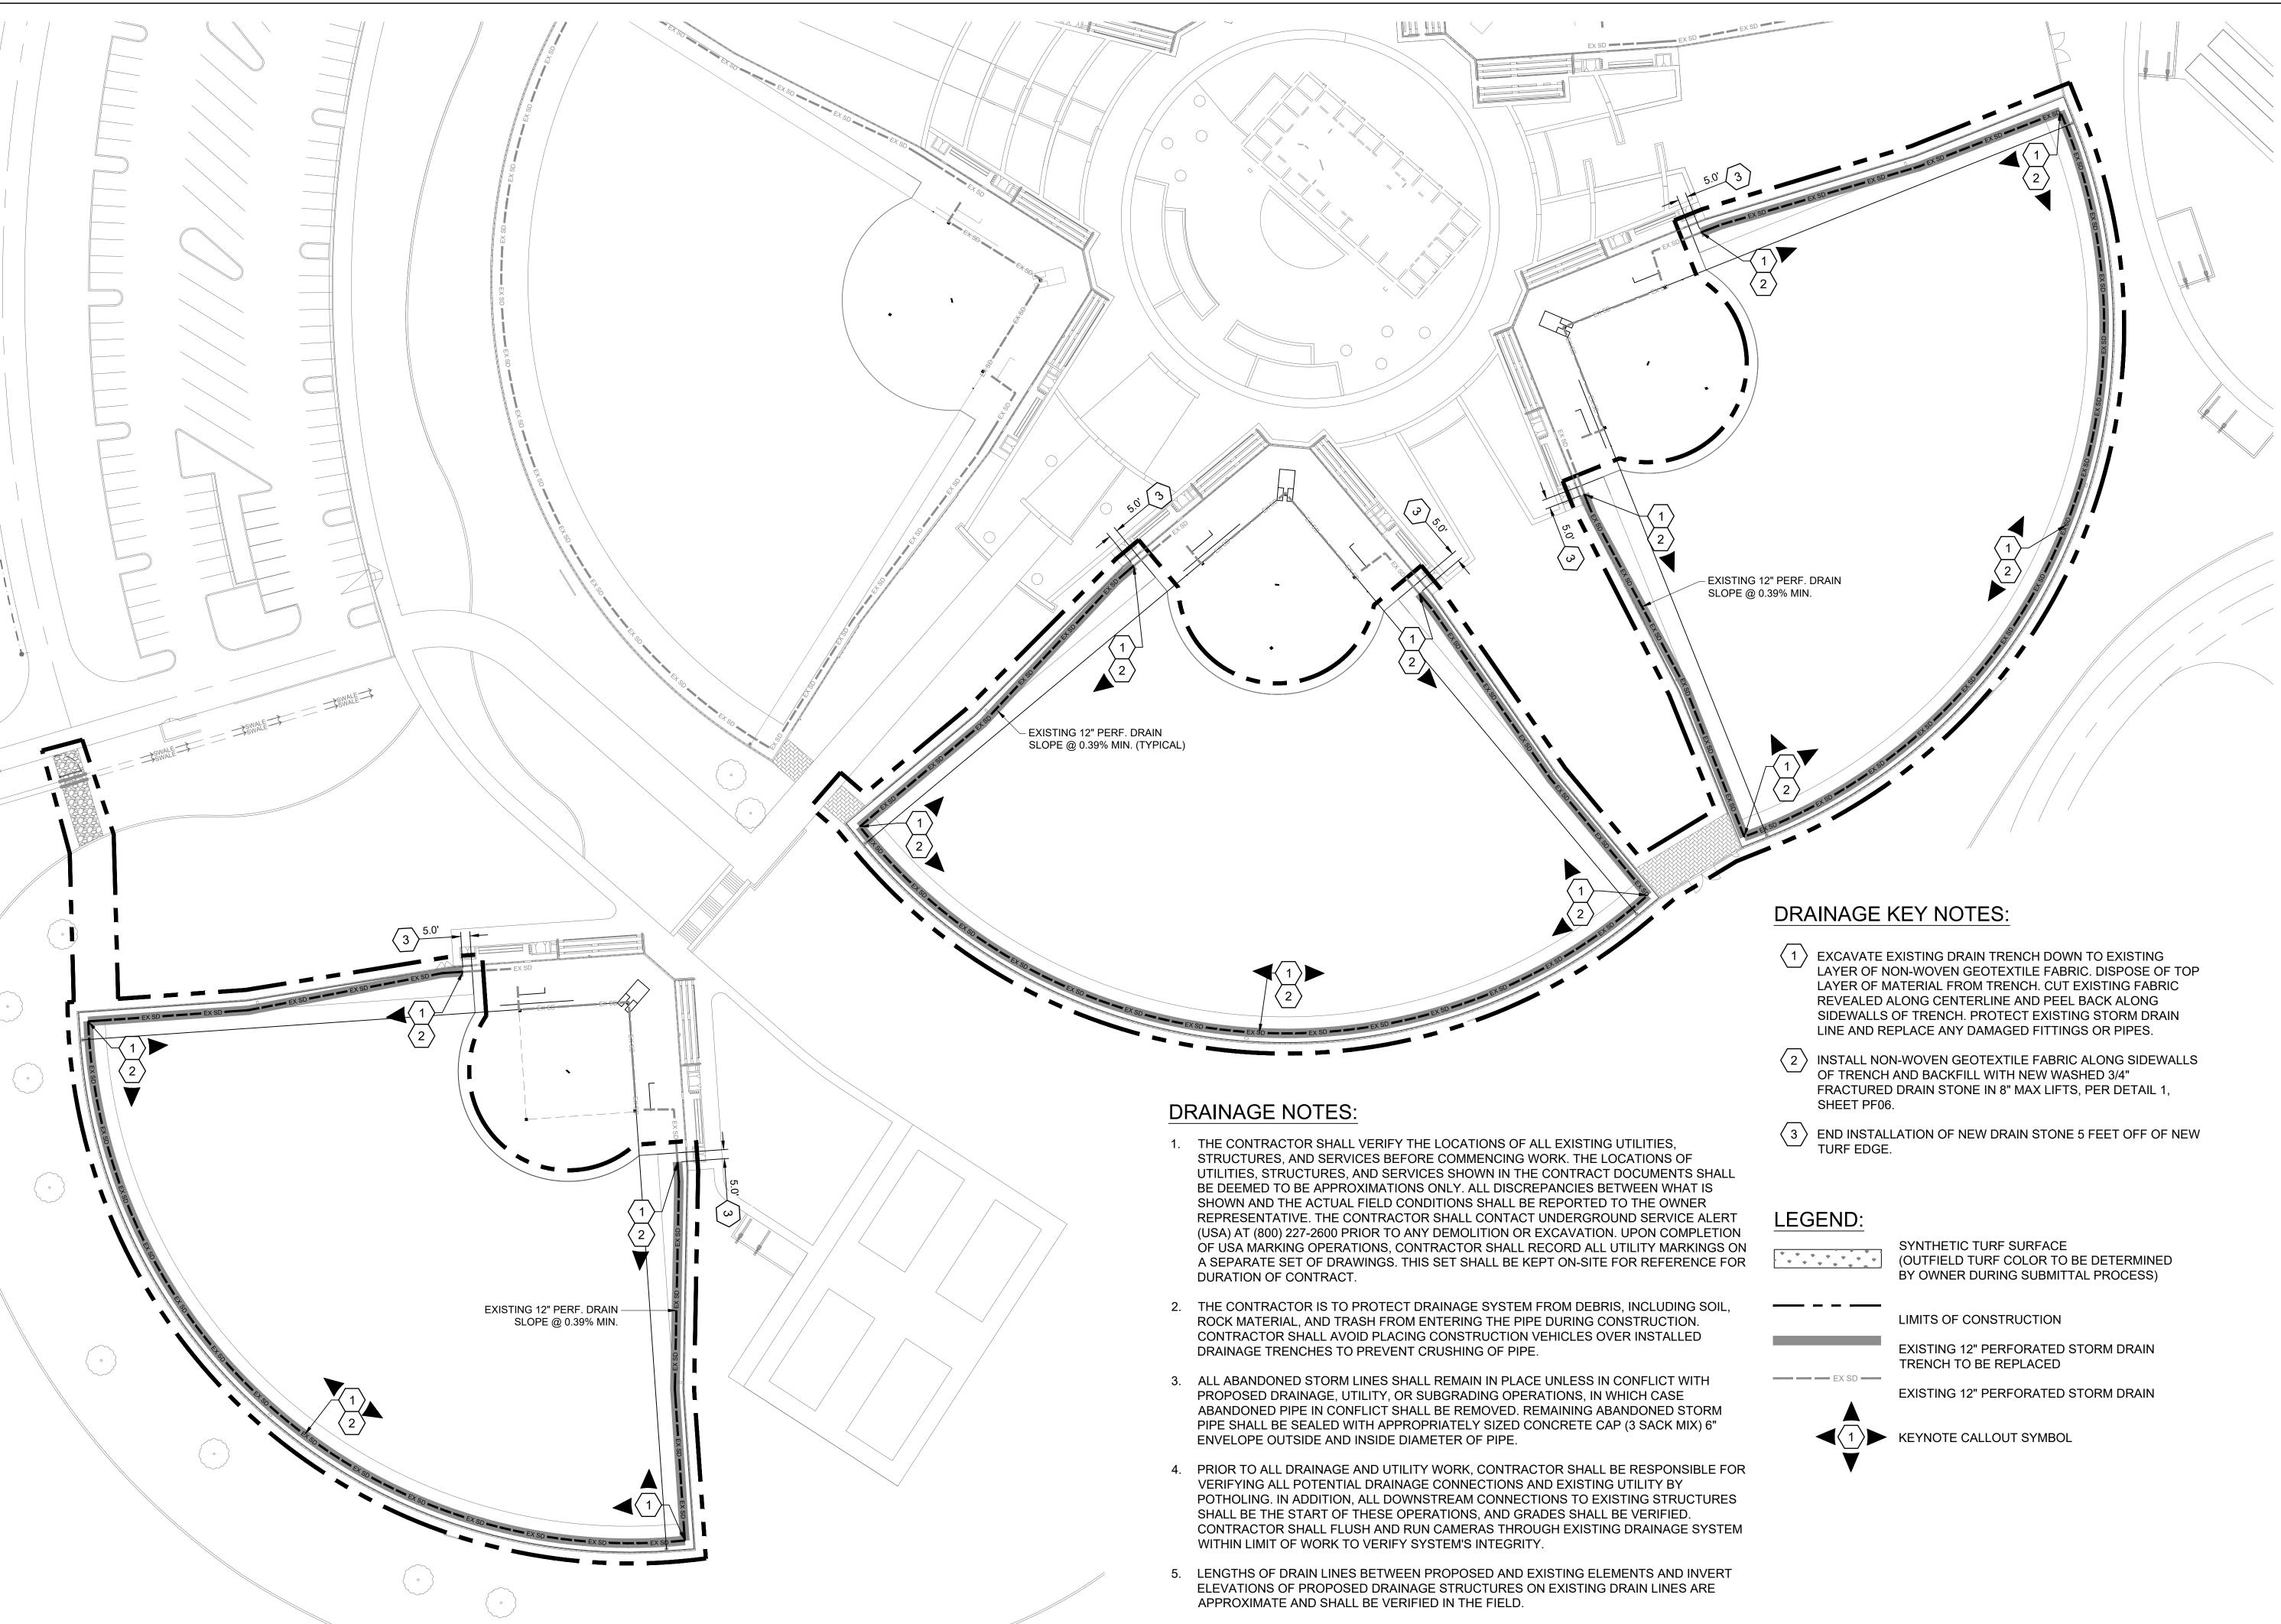
GOLDEN EAGLE REGIONAL PARK 6400 VISTA BLVD, SPARKS, NV

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SCALE: 1" = 40'

EXISTING
CONDITIONS &
DEMOLITION PLAN





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# CONSTRUCTION DOCUMENTS



REV.

GERP FIELDS 11, 12, AND 15

GOLDEN EAGLE REGIONAL PARK 6400 VISTA BLVD, SPARKS, NV

OUTFIELD

RESURFACING

PM:	SAW
DRAWN:	SAW
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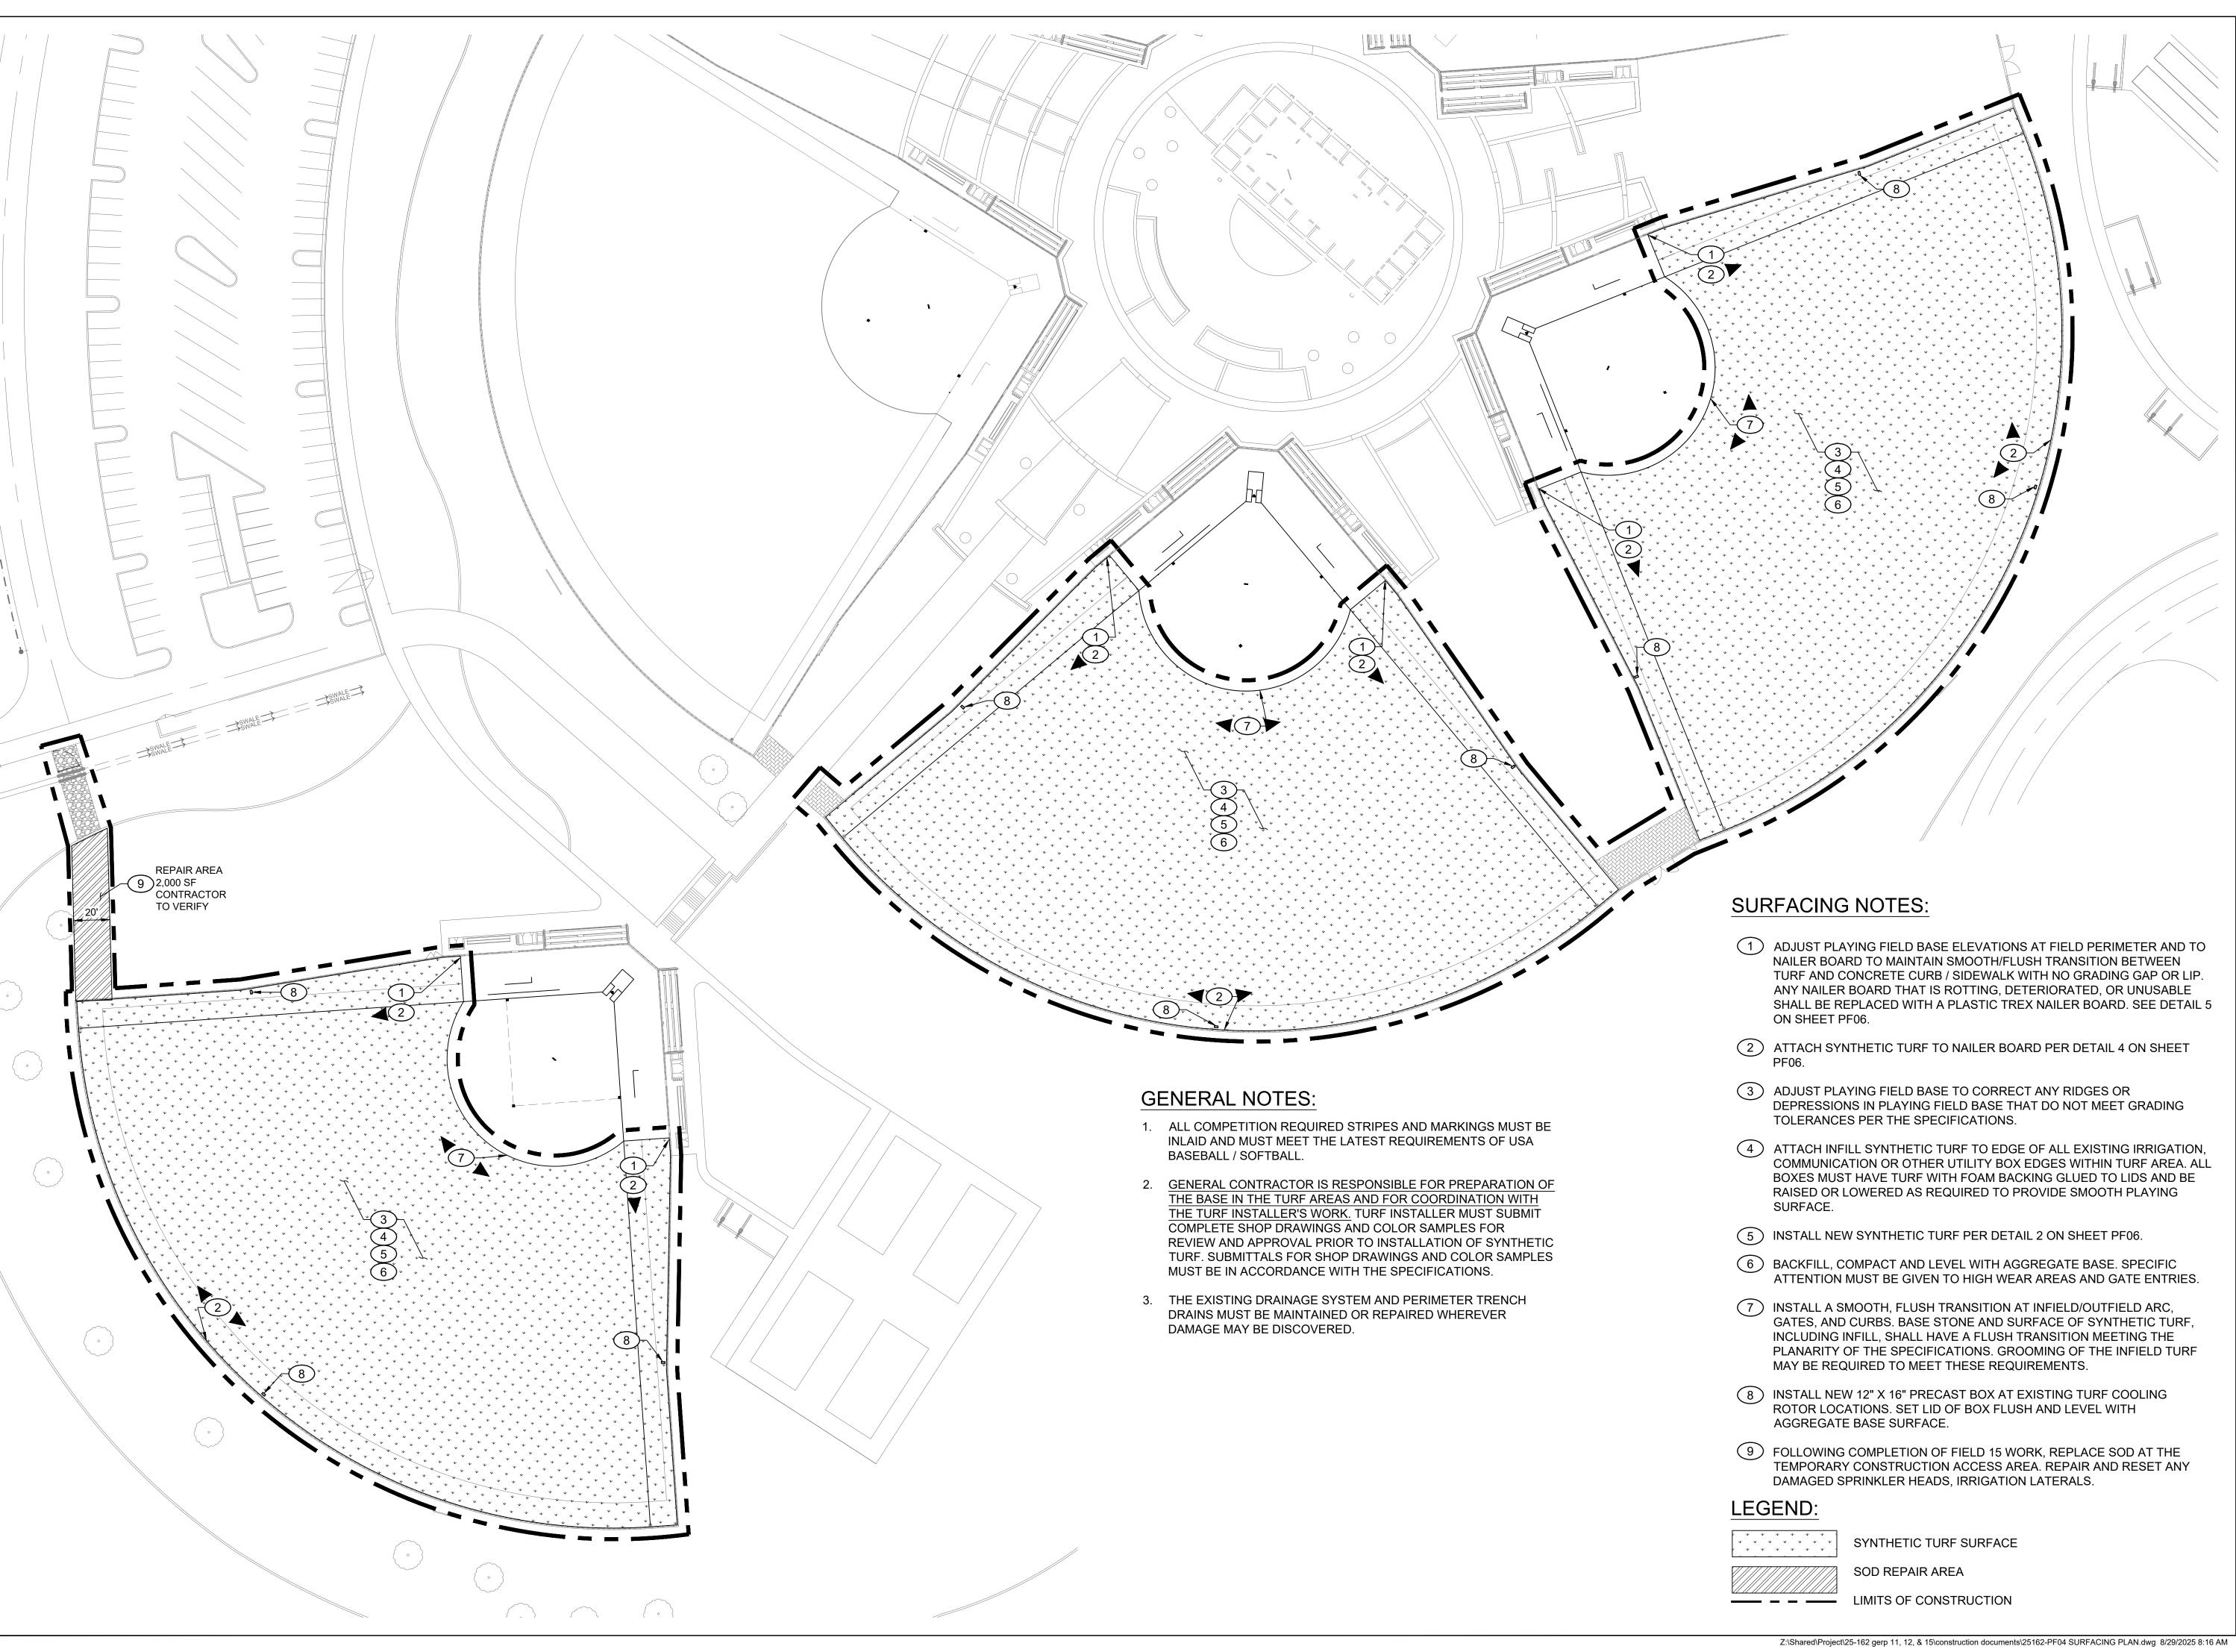
SCALE: 1" = 40'

DRAINAGE PLAN

DWG. NO.

PF03

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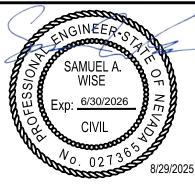
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# CONSTRUCTION DOCUMENTS



DEV

GERP FIELDS 11, 12, AND 15 OUTFIELD

GOLDEN EAGLE REGIONAL PARK 6400 VISTA BLVD, SPARKS, NV

RESURFACING

PM:	SAW
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SCALE: 1" = 40'

SURFACING PLAN

DWG. NO.



## **GRAPHCS KEYNOTES**

- 1 INSTALL BLUE 4" SQUARE BASELINE INDICATOR AT 2ND BASE. FIELD VERIFY LOCATION AND ALIGN WITH EXISTING BASE LINE INDICATORS AT 1ST AND 3RD BASELINES.
- 2 INSTALL WHITE 4" WIDE 12" LONG TICK MARK AT FOUL LINES AND CENTER OF OUTFIELD, LOCATE TICK MARKS AT 200' AND 250' DISTANCES FROM HOME PLATE.
- 3 INSTALL 2" WHITE DOT AT LOCATIONS OF NEW PULL BOXES AT EXISTING COOLING SYSTEM ROTORS.

## **GRAPHCS GENERAL NOTES**

- THIS GRAPHICS PLAN IS FOR REFERENCE ONLY. THE TURF MANUFACTURER AND INSTALLER MUST SUBMIT SHOP DRAWINGS FOR REVIEW PER SPECIFICATIONS.
- 2. ALL COMPETITION REQUIRED STRIPES AND MARKINGS MUST BE INLAID AND MUST MEET THE LATEST REQUIREMENTS OF USA BASEBALL / SOFTBALL RULES AND REGULATIONS.
- 3. TURF MAY NOT BE PURCHASED UNTIL SHOP DRAWINGS AND PHYSICAL SAMPLES ARE APPROVED IN WRITING BY THE OWNER.
- 4. DIMENSIONS SHOWN ARE APPROXIMATE AND MAY NOT BE REPRESENTATIVE OF THE EXACT FIELD MEASUREMENTS. TURF INSTALLER SHALL FIELD VERIFY ALL DIMENSIONS PRIOR TO ORDERING AND INSTALLATION OF TURF. IF ANY DIMENSIONS DO NOT MEET USA BASEBALL / SOFTBALL RULES AND REGULATIONS, THEY ARE TO BE BROUGHT TO THE ENGINEER'S ATTENTION.
- 5. GRAPHICS PLAN SHOWN IS TYPICAL FOR FIELDS 11, 12 & 15.

## **GRAPHICS LEGEND**

GREEN COLOR SYNTHETIC TURF

TERRACOTTA COLOR SYNTHETIC TURF

EXISTING TERRACOTTA COLOR SYNTHETIC TURF



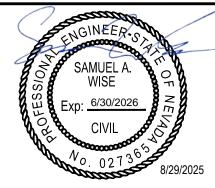
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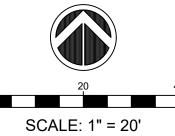


REV.

GERP FIELDS 11, 12, AND 15 OUTFIELD RESURFACING

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GRAPHICS PLAN

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