

CITY OF SPARKS

AIR COMPRESSOR #3 REPLACEMENT

TRUCKEE MEADOWS WATER RECLAMATION FACILITY

PO# 100020543
8500 CLEAN WATER WAY
RENO, NV 89502

LOCATION MAP

GENERAL NOTES

1. THE PROJECT SPECIFICATIONS AND DRAWINGS ARE A DOCUMENT SET AND SHOULD NOT BE SEPARATED. INFORMATION AND REFERENCES ARE CONTAINED IN ALL SPECIFICATIONS AND DRAWINGS.
2. IT IS THE CONTRACTOR'S RESPONSIBILITY TO FULLY UNDERSTAND THE COMPLETE SET OF SPECIFICATIONS AND THE DRAWINGS FOR THIS PROJECT. IT IS THE CONTRACTOR'S RESPONSIBILITY TO REVIEW ALL OF THE INFORMATION CONTAINED IN THE SPECIFICATIONS AND DRAWINGS, INCLUDING ALL OTHER DISCIPLINES (ARCHITECTURAL, ELECTRICAL, STRUCTURAL, ETC.) PRIOR TO BID AND CONSTRUCTION.
3. THE CONTRACTOR SHALL INSTALL THE NEW EQUIPMENT, DUCTWORK, AND PIPING AROUND ALL EXISTING OBSTACLES INCLUDING: ELECTRICAL CONDUIT, DOMESTIC WATER PIPING, WASTE AND VENT PIPING, CHILLED AND HEATING WATER PIPING, AND FIRE SPRINKLER PIPING. PROVIDE OFFSETS TO AVOID RELOCATION OF OTHER UTILITIES. RELOCATE UTILITIES IF THEY ARE IN CONFLICT WITH THE MECHANICAL SYSTEM INSTALLATION, CAUSE DEVIATIONS IN THE DESIGN INTENT, UNSATISFACTORY OPERATION, NOISY CONDITIONS, OR INTERFERE WITH MAINTENANCE. IT IS THE MECHANICAL CONTRACTOR'S RESPONSIBILITY TO COORDINATE ANY UTILITY RELOCATION WITH THE APPROPRIATE SUBCONTRACTOR.
4. THE INFORMATION INDICATED ON THESE DRAWINGS AS EXISTING IS BASED UPON INFORMATION TAKEN FROM AS-BUILT DRAWINGS, FIELD INVESTIGATION, AND INFORMATION OBTAINED FROM SUBMITTAL DATA, ETC. THE PLANS DO NOT GUARANTEE ACCURACY BUT ARE ONLY AN INDICATION OF EXISTING CONDITIONS. IT IS THE CONTRACTOR'S RESPONSIBILITY TO FIELD VERIFY EXACT CONDITIONS SUCH AS EQUIPMENT PLACEMENT, DUCTWORK (SIZE, ROUTING, AND ELEVATION), PIPING (SIZE, ROUTING, AND ELEVATION), ETC. THE DRAWINGS ARE INTENDED TO PROVIDE THE CONTRACTOR AN INDICATION OF THE SYSTEM INSTALLED IN THE FACILITY TO DATE. IT WILL BE THE CONTRACTOR'S RESPONSIBILITY TO MAKE ADJUSTMENTS TO THE DRAWING INFORMATION AS REQUIRED TO MATCH EXISTING FIELD CONDITIONS.

DIRECTORY

<p>OWNER CITY OF SPARKS TRUCKEE MEADOWS WATER RECLAMATION FACILITY 8500 CLEAN WATER WAY RENO, NV 89502</p> <p>CONTACT: KIM LABER TMWRF MAINTENANCE MANAGER (775) 861-4125</p>	<p>MECHANICAL CONSULTANT</p>  <p>5434 LONGLEY LANE RENO, NEVADA 89511 PHONE: (775) 826-1919 WEB: CR-ENG.COM</p> <p>CONTACT: BRIAN BIERSDORFF</p>	<p>ELECTRICAL CONSULTANT</p>  <p>Electrical Engineers 9655 Gateway Drive Ph. (775) 852-2288 email: jeneng@nvbell.net</p> <p>Reno, Nevada 89521-2968 Fax (775) 852-3388 web: www.jeneng.com</p> <p>CONTACT: GERALD JENSEN, P.E.</p>
--	--	--

SHEET LIST

<p>GENERAL</p> <p>T0.1 TITLE SHEET</p> <p>MECHANICAL</p> <p>M0.1 MECHANICAL ABBREVIATIONS, LEGEND, AND SCHEDULES M1.1 MECHANICAL DEMOLITION FLOOR PLAN M2.1 MECHANICAL FLOOR PLAN M4.1 MECHANICAL ELEVATIONS M4.2 MECHANICAL PIPING DIAGRAMS M5.1 MECHANICAL CONTROL DIAGRAM</p>	<p>ELECTRICAL</p> <p>E0.1 ELECTRICAL SYMBOLS AND MECHANICAL EQUIPMENT CONNECTION SCHEDULE E1.1 ELECTRICAL PARTIAL DEMOLITION FLOOR PLAN E2.1 ELECTRICAL PARTIAL FLOOR PLAN E3.1 ELECTRICAL PARTIAL FLOOR PLAN E4.1 ELECTRICAL PARTIAL FLOOR PLAN</p>
--	---

BUILDING CODES



- 2018 INTERNATIONAL BUILDING CODE
- 2018 INTERNATIONAL FIRE CODE
- 2018 INTERNATIONAL ENERGY CONSERVATION CODE
- 2018 UNIFORM MECHANICAL CODE
- 2018 UNIFORM PLUMBING CODE
- 2017 NATIONAL ELECTRICAL CODE

APPROVED BY:

JOHN A. MARTINI, P.E.
ASSISTANT CITY MANAGER
CITY OF SPARKS

SUBMITTED BY:


CHRISTOPHER L. ROUNDS, P.E.
PRINCIPLE ENGINEER
CR ENGINEERING

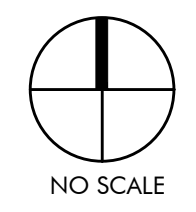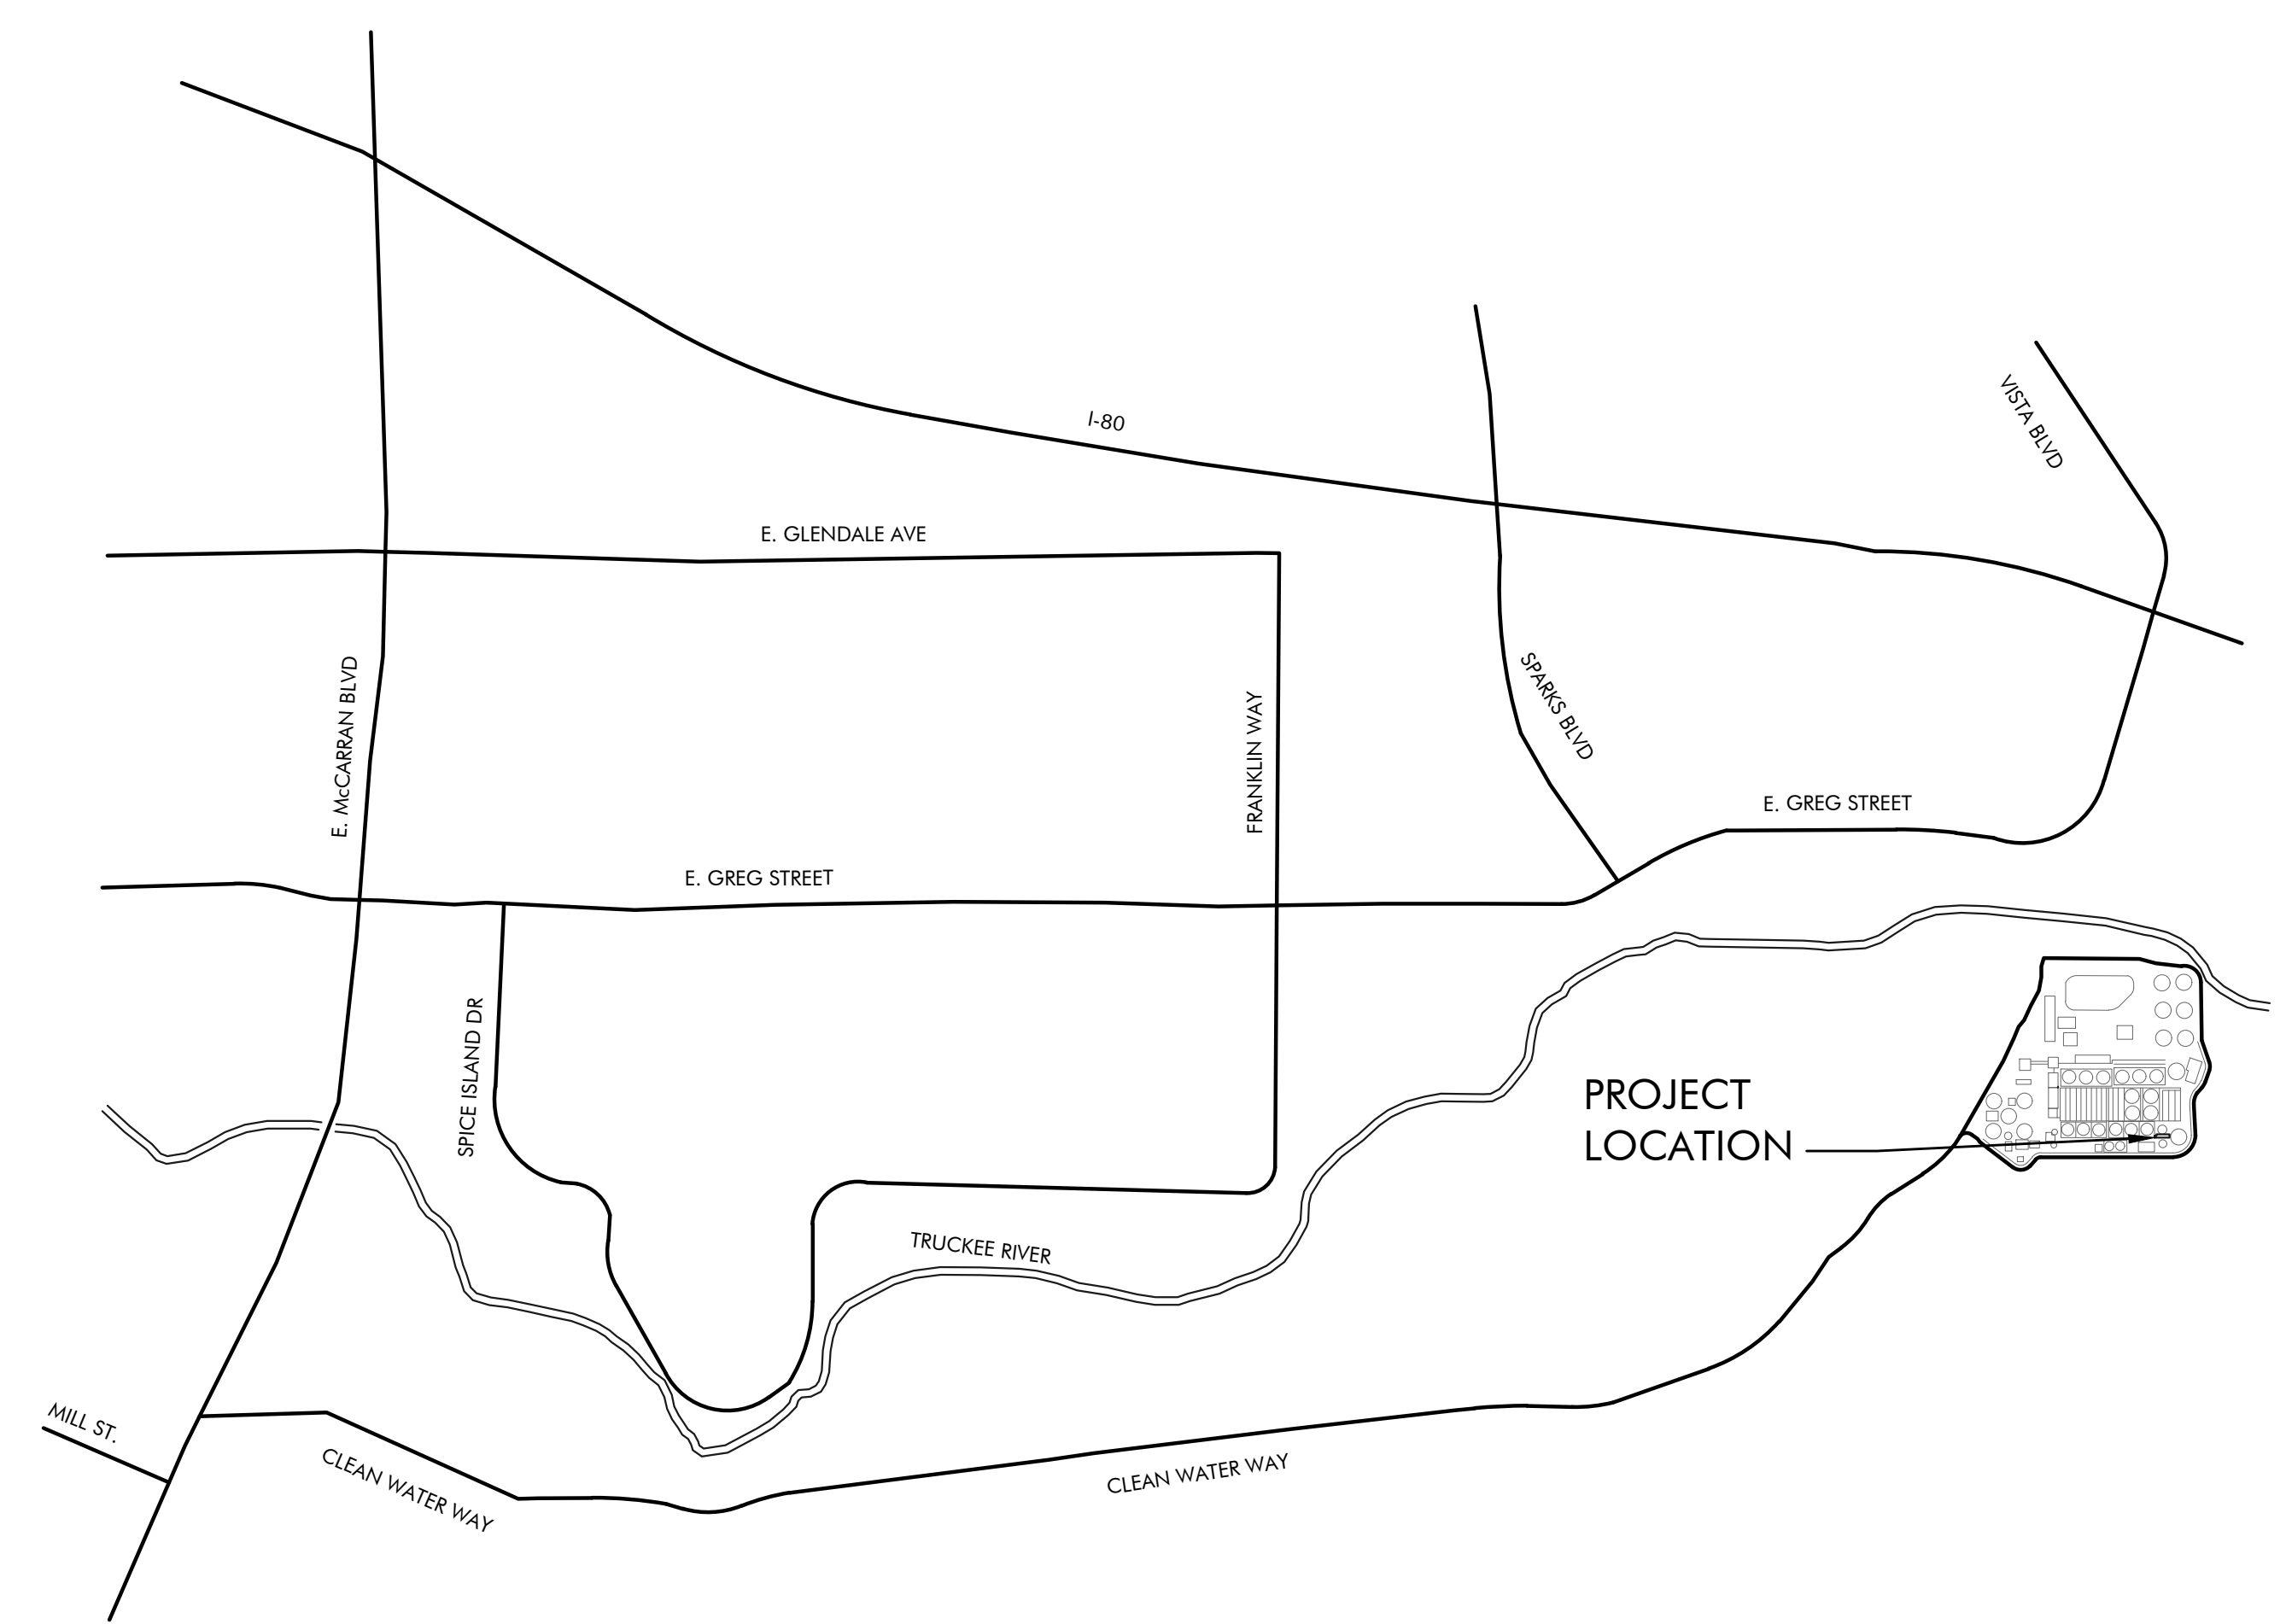

DRAWING ON 11x17 SHEET IS HALF SCALE

REV	DATE	BY	DESCRIPTION	APVD	DATE

DESIGNED BB
DRAWN BB
CHECKED CLR
DATE 11/2/20

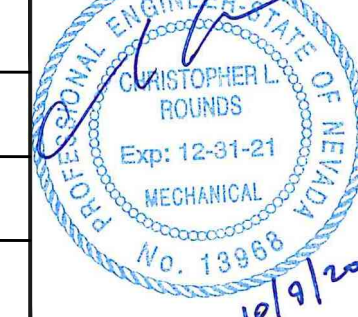


5434 LONGLEY LANE
RENO, NEVADA 89511
PHONE: (775) 826-1919
PROJECT NO: 135220




CITY OF SPARKS
TMWRF AIR COMPRESSOR #3 REPLACEMENT

TITLE SHEET

VERIFY SCALES
BAR IS ONE INCH ON ORIGINAL DRAWING
0 1" IF NOT ONE INCH ON THIS SHEET, ADJUST SCALES ACCORDINGLY

JOB NO. 135220
DRAWING NO. T0.1
SHEET NO. 1 OF 12

HEAT EXCHANGER SCHEDULE

EQUIPMENT ID	SERVICE	MANUFACTURER	MODEL	MAXIMUM DESIGN PRESS (PSI)	MAXIMUM DESIGN TEMPERATURE (°F)	SURFACE AREA (SF)	# OF PLATES	MINIMUM CAPACITY AT DESIGN CONDITION (MBH)	HOT SIDE - AIR COMPRESSOR				COLD SIDE - #2 WATER				OPERATING WEIGHT (LBS)	OPTIONS
									EWT (°F)	LWT (°F)	WATER FLOW (GPM)	MAXIMUM WPD (FT WC)	EWT (°F)	LWT (°F)	WATER FLOW (GPM)	MAXIMUM WPD (FT WC)		
HEX25119	WATER-COOLED AIR COMPRESSOR	SONDEX	SL32-BR30-60-TL	362	365	20.9	60	267	127	100	20	5	85	112	20	5	30	N/A
HEX25120	WATER-COOLED AIR COMPRESSOR	SONDEX	SL32-BR30-60-TL	362	365	20.9	60	267	127	100	20	5	85	112	20	5	30	N/A

GENERAL NOTES:
 1. ALL CAPACITIES ARE LISTED AT 4,500 FEET ELEVATION.
 2. DESCRIPTION: BRAZED PLATE HEAT EXCHANGER.
 3. CONSTRUCTION RATING: HEAT EXCHANGER SHALL BE DESIGNED AND FABRICATED IN ACCORDANCE TO ASME SECTION VIII, "PRESSURE VESSELS".

STANDARD FEATURES:
 A. STAINLESS STEEL PLATES BRAZED WITH COPPER

AIR COMPRESSOR SCHEDULE

EQUIPMENT ID	UNIT DATA			PERFORMANCE DATA				ELECTRICAL DATA			COOLING DATA			OPTIONS
	MANUFACTURER	MODEL	OPERATING WEIGHT (LBS)	DISCHARGE PRESSURE (PSIG)	MINIMUM CAPACITY (CFM)	MAXIMUM CAPACITY (CFM)	COOLING WATER P (°F)	MOTOR (HP)	ELECTRICAL (VOLTS/Ø/Hz)	SPEED (RPM)	WATER FLOW (GPM)	EWT (°F)	LWT (°F)	
CMP25109	ATLAS COPCO	ZR-75-VSD-8.6-60	6,000	105	157	419	5	100	460/3/60	2,666	20	100	127	A,B,C,D

GENERAL NOTES:
 1. ALL CAPACITIES ARE LISTED AT 4,500 FEET ELEVATION
 2. ALL ELECTRICAL COMPONENTS SHALL BE UL OR ETL LISTED
 3. WATER-COOLED AIR COMPRESSOR

STANDARD FEATURES:
 1. INTEGRATED VARIABLE SPEED DRIVE
 2. 100% OIL-FREE ROTARY SCREW COMPRESSOR
 3. INLET THROTTLE VALVE FOR FULL LOAD/NO LOAD REGULATION
 4. PREMIUM EFFICIENCY TEFC COMPRESSOR MOTOR

OPTIONS:
 A. ANCHOR PADS
 B. IO2 EXPANSION MODULE TO PROVIDE ELECTRICAL POWER TO EXTERNAL EQUIPMENT
 C. GATEWAY MODULE FOR MODBUS COMMUNICATION WITH DCS
 D. MANUFACTURER PROVIDED, FIELD INSTALLED CONTROL VALVE

EQUIPMENT SCHEDULE

PMP25122	CIRCULATION PUMP - TACO 2400-30S-3P CIRCULATING PUMP WITH STAINLESS STEEL CASING AND STAINLESS STEEL SHAFT. PUMP CAPACITY SHALL BE 20 GPM AND TOTAL HEAD PRESSURE OF 15 FT. ELECTRICAL: 120V/1Ø/60Hz, 1/6 HP OPERATING WEIGHT: 15 LBS
TNK25123	CHEMICAL FEED TANK - NU-CALGON MODEL 20L FLAT BOTTOM, MILD STEEL, 2-GALLON MICROMET CHEMICAL FEEDER WITH 3/4" QUARTER TURN CAP AND TWO 3/4" NPT PORTS. SEE PIPING DIAGRAM FOR CONFIGURATION.
EXT25121	EXPANSION TANK - AMTROL THERM-X-TROL MODEL EX-15 PRE-CHARGED THERMAL EXPANSION TANK. 2.0 GALLON TANK WITH MAXIMUM ACCEPTANCE FACTOR OF 0.5. TANK SHALL HAVE A 100 PSI MAXIMUM WORKING PRESSURE, 240°F MAXIMUM WORKING TEMPERATURE, AND 12 PSI FACTORY PRESET PRESSURE
MOV25124	CONTROL VALVE - BELIMO MODEL G240(S) ON-OFF, TWO-WAY, THREADED WITH STAINLESS STEEL TRIM AND A STAINLESS STEEL PLUG. 1 1/2" NPT CONNECTIONS. SPRING-RETURN WITH NORMAL OPEN. ELECTRICAL: 24 VAC/60Hz

MECHANICAL ABBREVIATIONS

ACFM	ACTUAL CUBIC FEET PER MINUTE
AFF/AFG	ABOVE FINISHED FLOOR/GRADE
A	AMPERE
APD	AIR PRESSURE DROP
BFF/BFG	BELOW FINISHED FLOOR/GRADE
BTUH	BRITISH THERMAL UNITS PER HOUR
CA	COMPRESSED AIR
CFM	CUBIC FEET PER MINUTE
COP	COEFFICIENT OF PERFORMANCE
(D)	DEMOLISH
DIA	DIAMETER
DP	DIFFERENTIAL PRESSURE
EFF	EFFICIENCY
EER	ENERGY EFFICIENCY RATIO
(E)	EXISTING
ESP	EXTERNAL STATIC PRESSURE
FLA	FULL LOAD AMPERES
PPM	FEET PER MINUTE
FT	FOOT
FT ²	SQUARE FOOT
FT ³	CUBIC FOOT
GA	GAUGE
GPM	GALLONS PER MINUTE
HP	HORSEPOWER
HZ	HERTZ
IN	INCH
IN ²	SQUARE INCH
IN ³	CUBIC INCH
KW	KILOWATT
LBS	POUNDS
MAX	MAXIMUM
MBH	THOUSAND BRITISH THERMAL UNITS PER HOUR
MCA	MINIMUM CIRCUIT AMPACITY
MERV	MINIMUM EFFICIENCY REPORTING VALUE
MIN	MINIMUM
MOCP	MAXIMUM OVERCURRENT PROTECTION
(N)	NEW
PSI	POUNDS PER SQUARE INCH
PSIG	POUNDS PER SQUARE INCH GAUGE
RPM	REVOLUTIONS PER MINUTE
SEER	SEASONAL ENERGY EFFICIENCY RATIO
TYP	TYPICAL
V	VOLTS
W	WATT
WC/WG	WATER COLUMN/GAUGE

MECHANICAL SYMBOL LEGEND

	M	MOTORIZED ACTUATOR
	TSTAT	THERMOSTAT OR TEMPERATURE SENSOR @ 48" AFF
	BV	BALL VALVE
	BFV	BUTTERFLY VALVE
	CV	CHECK VALVE
	FCV	FLOW CONTROL (BALANCE) VALVE
	PRV	PRESSURE REDUCING VALVE
	PTRV	PRESSURE AND TEMPERATURE RELIEF VALVE
	TCV	TEMPERATURE CONTROL VALVE (2-WAY OR 3-WAY)
	TDV	TRIPLE DUTY VALVE
	STR	STRAINER
		UNION
		PIPE BREAK
		PIPE CAP OR PLUG
	ELL	PIPE ELBOW
		PIPE ELBOW DOWN
		PIPE ELBOW UP
		PIPE TEE
		PIPE RISER
		PIPE DROP
		PIPE BRANCH, TOP CONNECTION
		PIPE BRANCH, BOTTOM CONNECTION
	FLEX	FLEXIBLE PIPE CONNECTOR
		WATER METER
		PRESSURE SENSOR, TEMPERATURE SENSOR WITH WELL
		PRESSURE GAUGE, TEMPERATURE GAUGE
	P	PUMP
	D	EQUIPMENT OR CONDENSATE DRAIN PIPING
	POC	POINT OF CONNECTION
		POINT OF DISCONNECT
	CA	COMPRESSED AIR
	CCW	COMPRESSOR COOLING WATER
	#2 W	#2 EFFLUENT PLANT WATER
	#3 W	#3 EFFLUENT PLANT WATER
	PS	PRIMARY SLUDGE
	PP	POLYMER PRIMARY
	HWR	HOT WATER RETURN
	HWS	HOT WATER SUPPLY

DRAWING ON 11x17 SHEET IS HALF SCALE

REV	DATE	BY	DESCRIPTION	APVD	DATE

DESIGNED BB
 DRAWN BB
 CHECKED CLR
 DATE 10/09/20


5434 LONGLEY LANE
 RENO, NEVADA 89511
 PHONE: (775) 826-1919
 PROJECT NO: 135220

TRUCKEE MEADOWS
 WATER RECLAMATION FACILITY

CITY OF SPARKS
 TMWRF AIR COMPRESSOR #3 REPLACEMENT
 MECHANICAL SCHEDULES, ABBREVIATIONS
 AND LEGEND

VERIFY SCALES
 BAR IS ONE INCH ON ORIGINAL DRAWING
 0 1" IF NOT ONE INCH ON THIS SHEET, ADJUST SCALES ACCORDINGLY

JOB NO. 135220
 DRAWING NO. MO.1
 SHEET NO. 2 OF 12

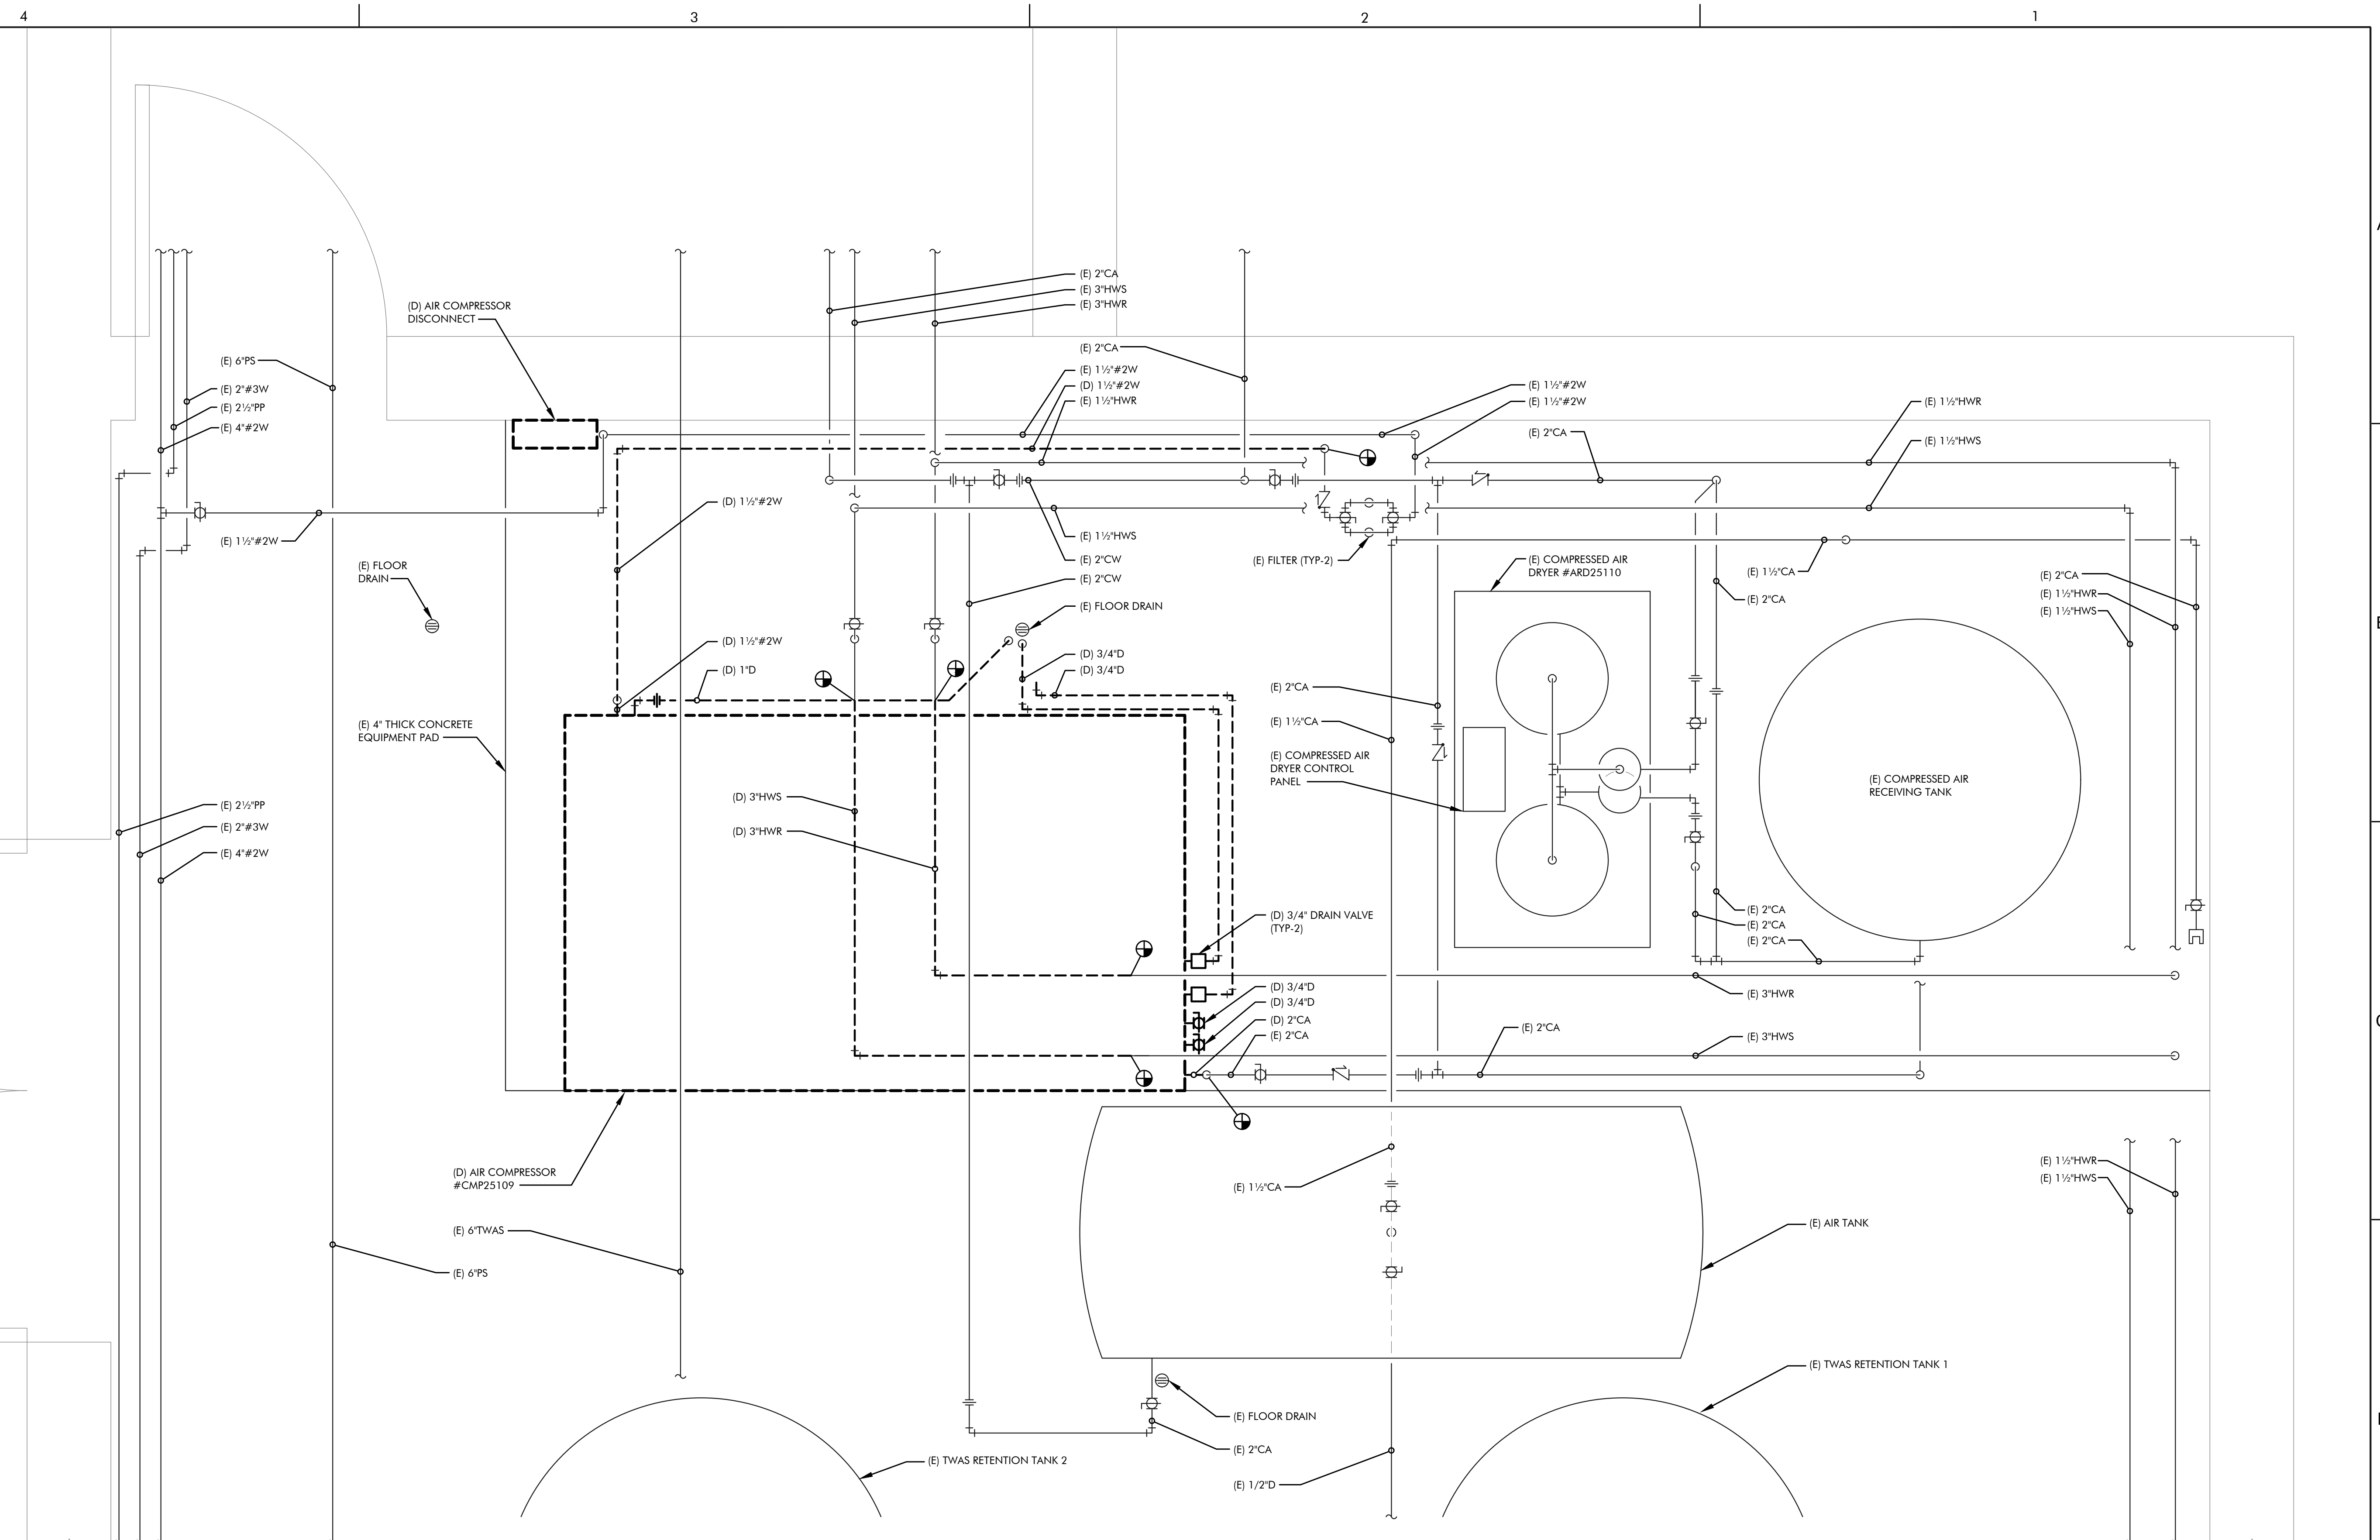


A MECHANICAL DEMOLITION FLOOR PLAN
 M1.1 SCALE: 1"=1'-0"

DRAWING ON 11x17 SHEET IS HALF SCALE

REV	DATE	BY	DESCRIPTION	APVD	DATE

DESIGNED BB
 DRAWN BB
 CHECKED CLR
 DATE 10/09/20

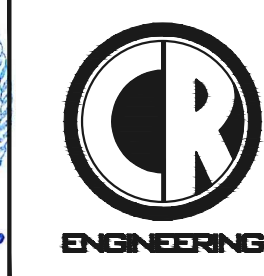

5434 LONGLEY LANE
 RENO, NEVADA 89511
 PHONE: (775) 826-1919
 PROJECT NO: 135220



CITY OF SPARKS
 TMWRF AIR COMPRESSOR #3 REPLACEMENT
MECHANICAL DEMOLITION FLOOR PLAN

VERIFY SCALES
 BAR IS ONE INCH ON ORIGINAL DRAWING
 0 1" IF NOT ONE INCH ON THIS SHEET, ADJUST SCALES ACCORDINGLY



JOB NO. 135220
 DRAWING NO. M1.1
 SHEET NO. 3 OF 12

A MECHANICAL FLOOR PLAN
 M2.1 SCALE: 1"=1'-0"

DRAWING ON 11x17 SHEET IS HALF SCALE

REV	DATE	BY	DESCRIPTION	APVD	DATE

DESIGNED
BB
 DRAWN
BB
 CHECKED
CLR
 DATE
10/09/20

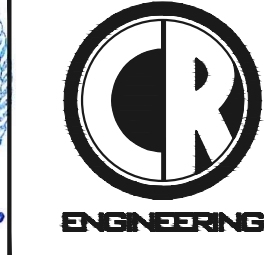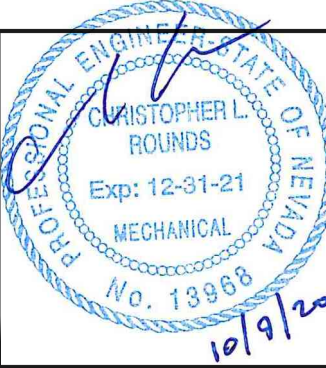

5434 LONGLEY LANE
 RENO, NEVADA 89511
 PHONE: (775) 826-1919
 PROJECT NO: 135220




CITY OF SPARKS
 TMWRF AIR COMPRESSOR #3 REPLACEMENT
MECHANICAL FLOOR PLAN

VERIFY SCALES
 BAR IS ONE INCH ON ORIGINAL DRAWING
 0 1" IF NOT ONE INCH ON THIS SHEET, ADJUST SCALES ACCORDINGLY

JOB NO. 135220
 DRAWING NO. M2.1
 SHEET NO. 4 OF 12

FILENAME: W:\2020\135220\dwgs\135220 M2.1 MECH FL PL.dwg

PERMIT SET


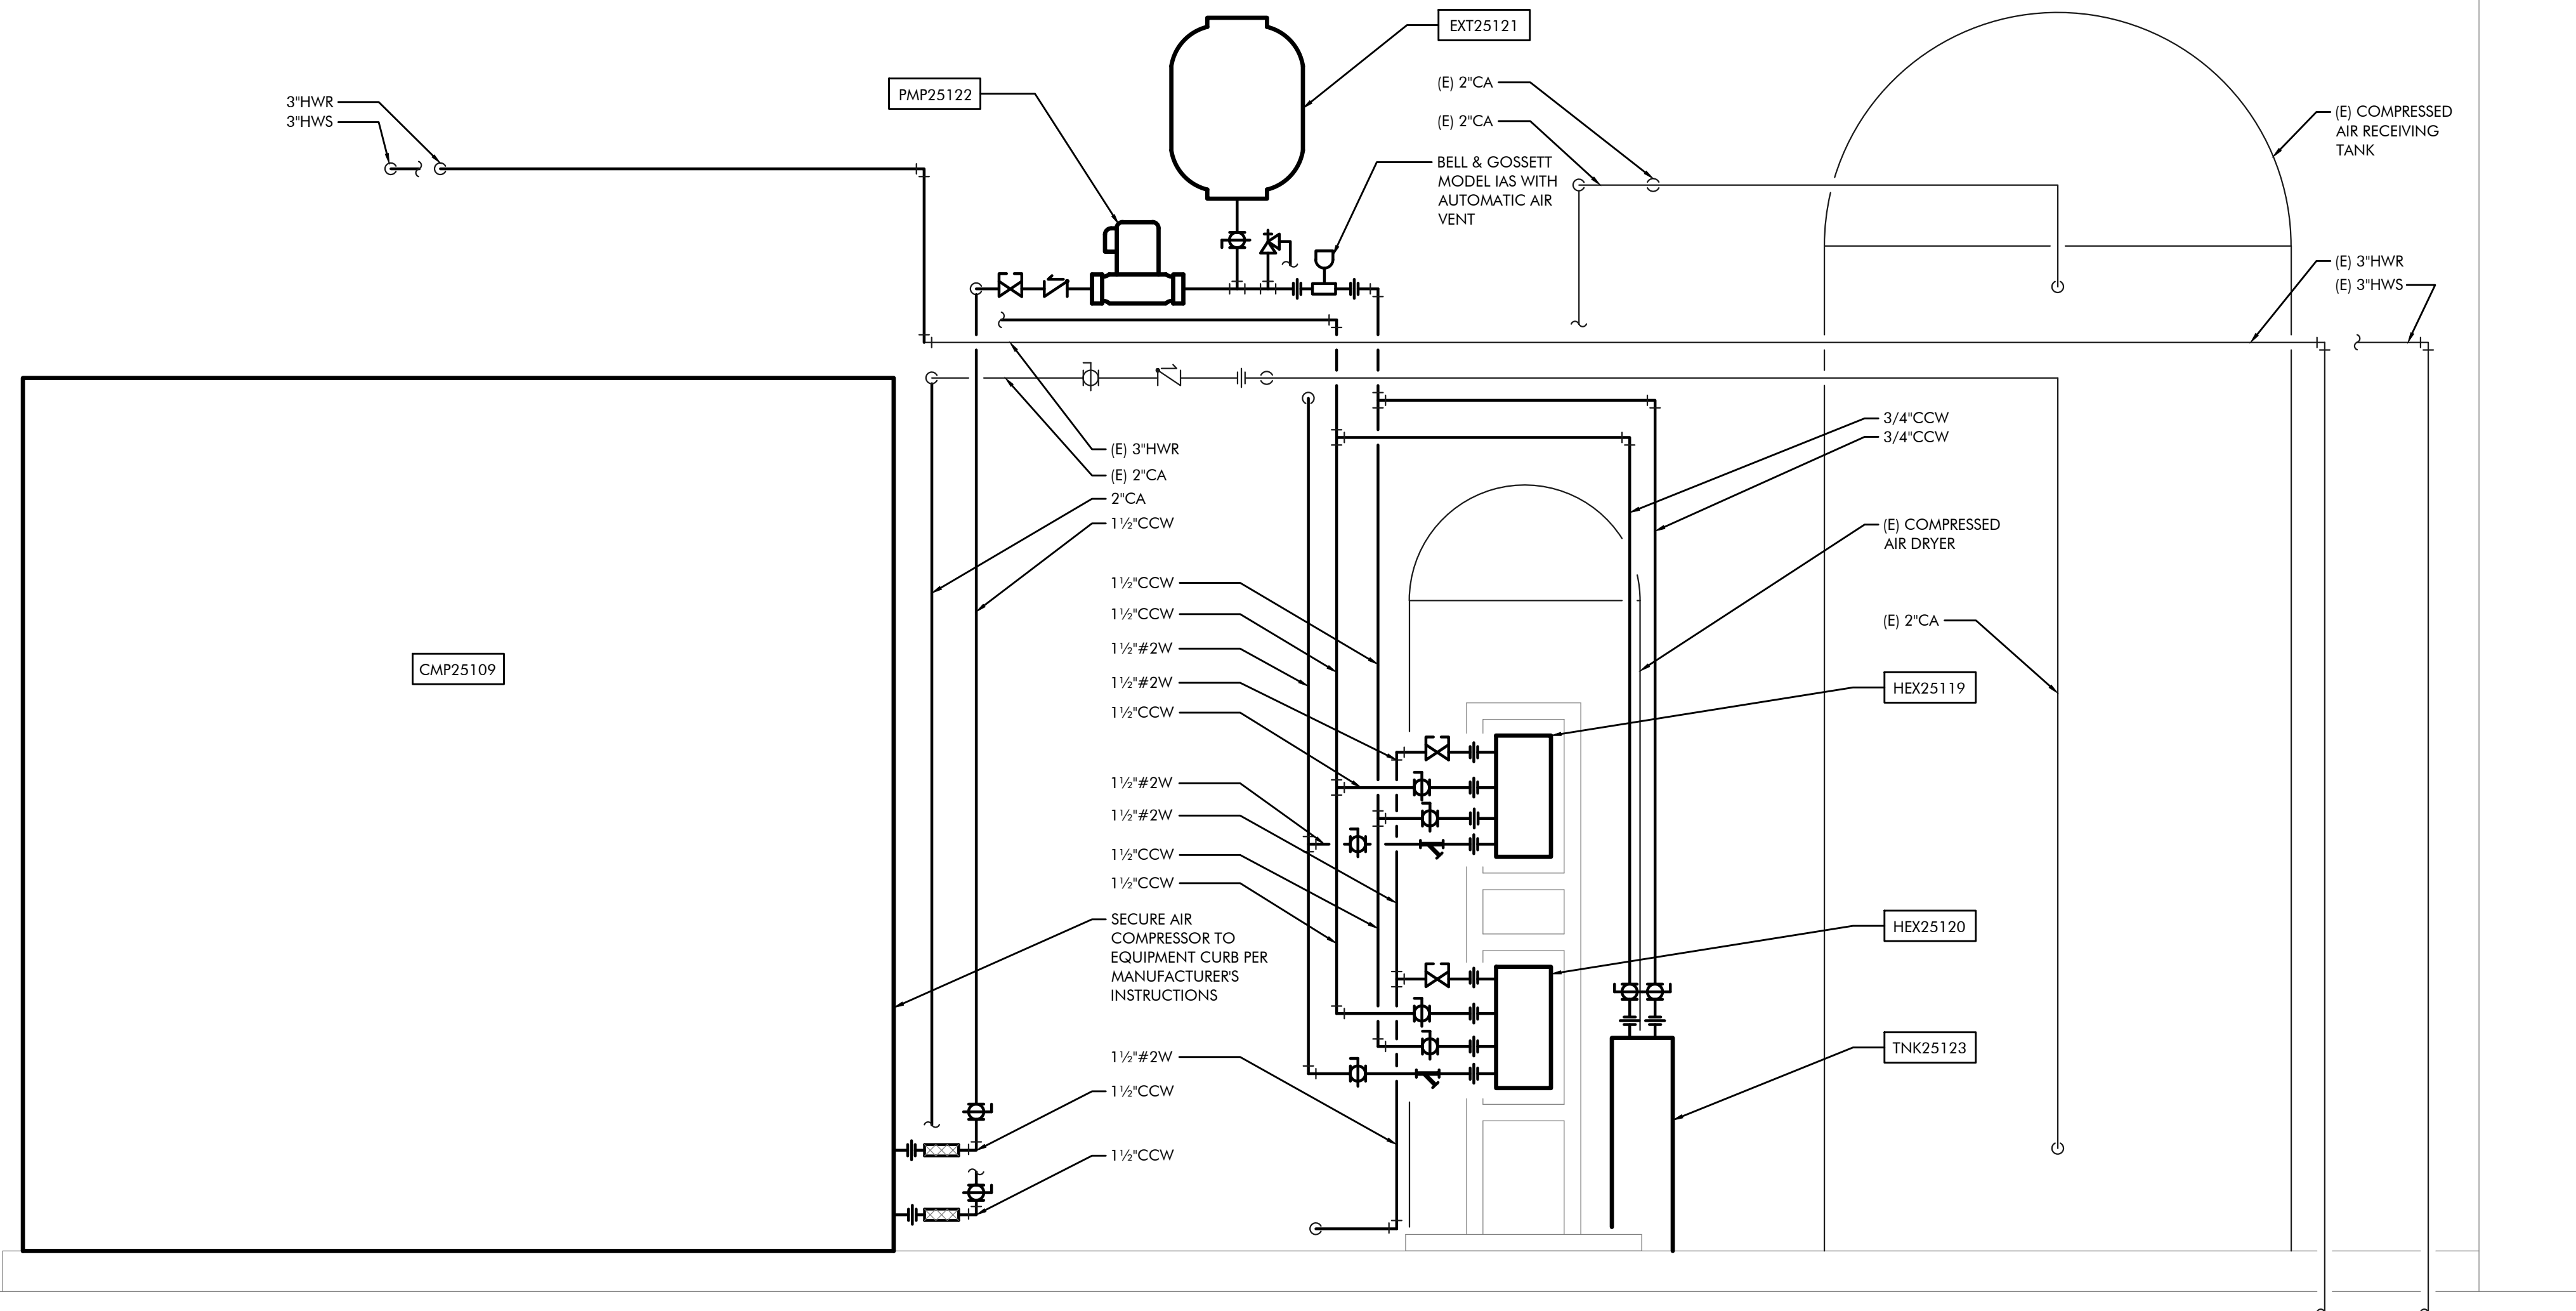


1 MECHANICAL ELEVATION
 M4.1 SCALE: 1"=1'-0"

DRAWING ON 11x17 SHEET IS HALF SCALE

REV	DATE	BY	DESCRIPTION	APVD	DATE

DESIGNED BB
DRAWN BB
CHECKED CLR
DATE 10/09/20

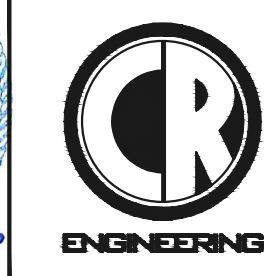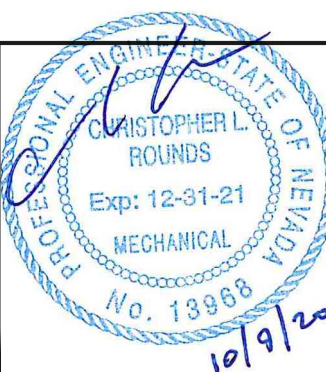


5434 LONGLEY LANE
 RENO, NEVADA 89511
 PHONE: (775) 826-1919
 PROJECT NO: 135220




CITY OF SPARKS
 TMWRF AIR COMPRESSOR #3 REPLACEMENT
 MECHANICAL ELEVATIONS

VERIFY SCALES
 BAR IS ONE INCH ON ORIGINAL DRAWING
 0 1"
 IF NOT ONE INCH ON THIS SHEET, ADJUST SCALES ACCORDINGLY

JOB NO. 135220
 DRAWING NO. M4.1
 SHEET NO. 5 OF 12

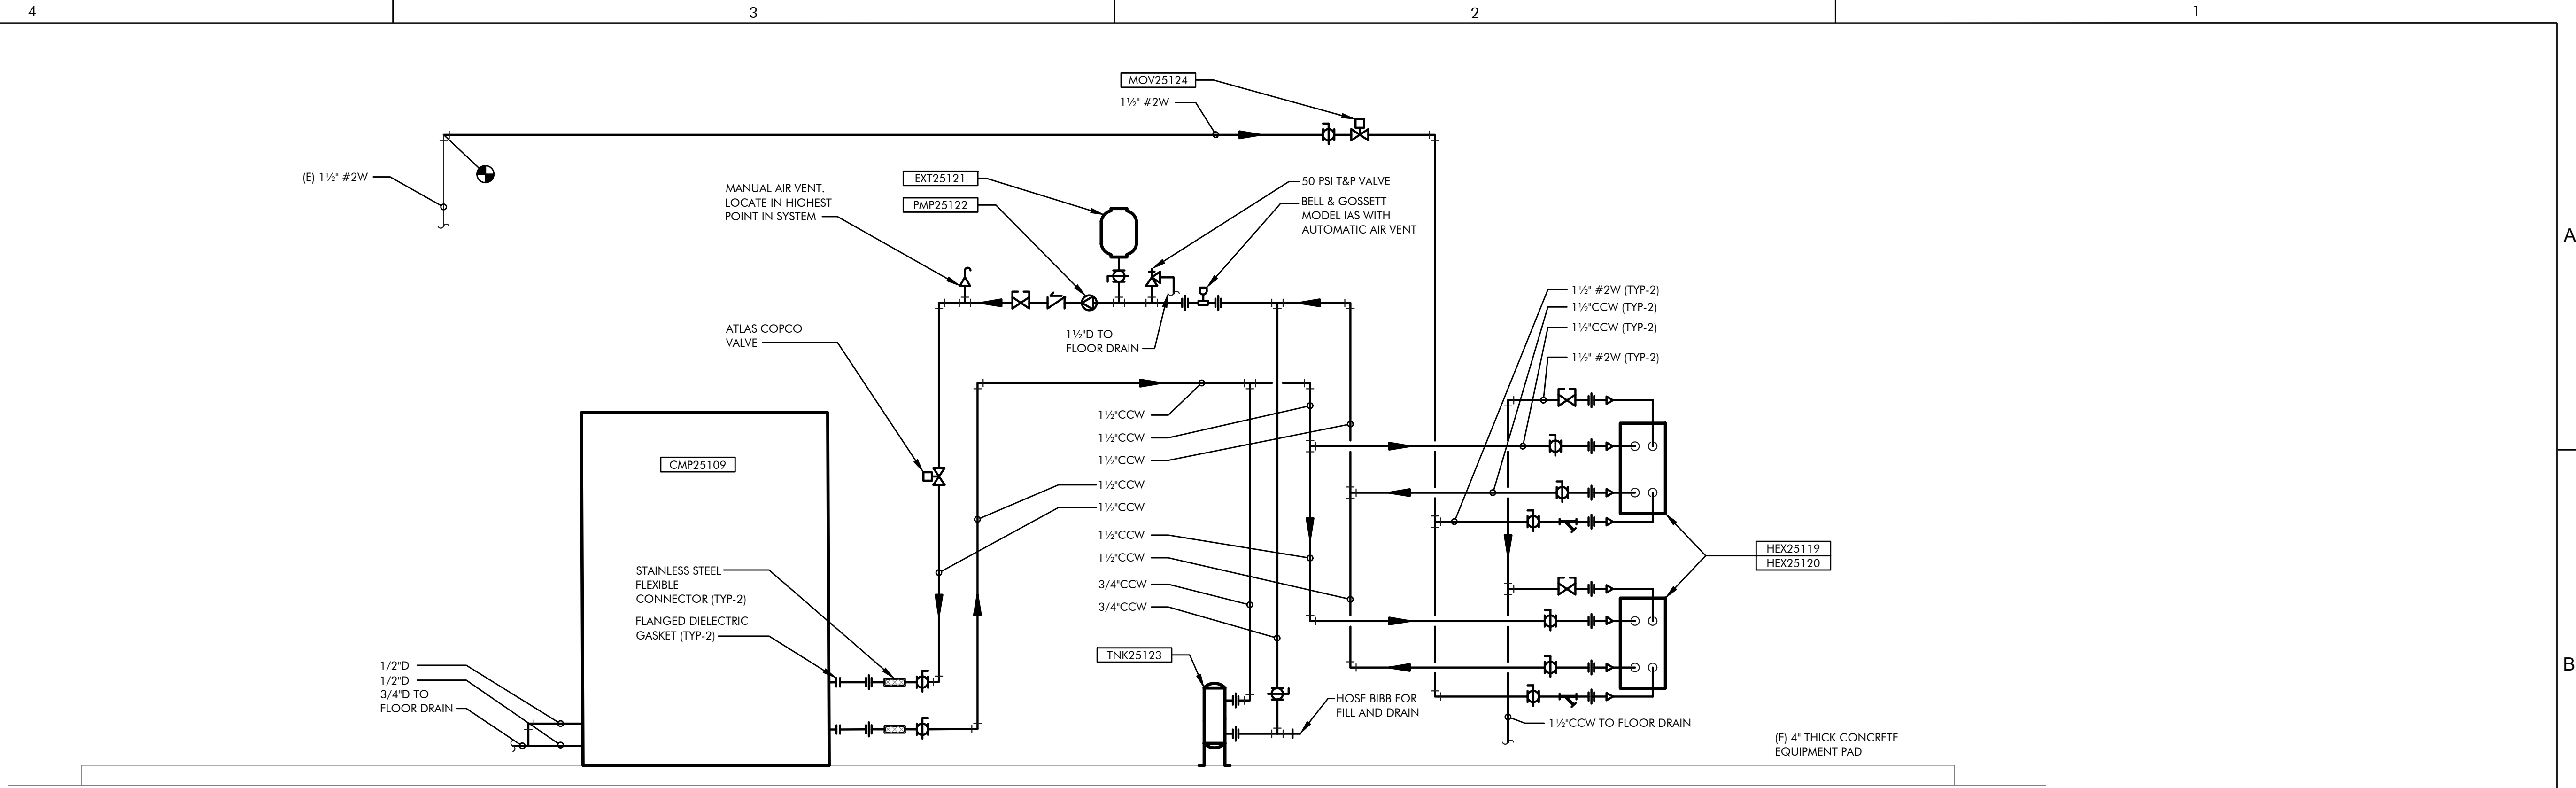

1 MECHANICAL #2 WATER PIPING DIAGRAM
M4.2 SCALE: NONE


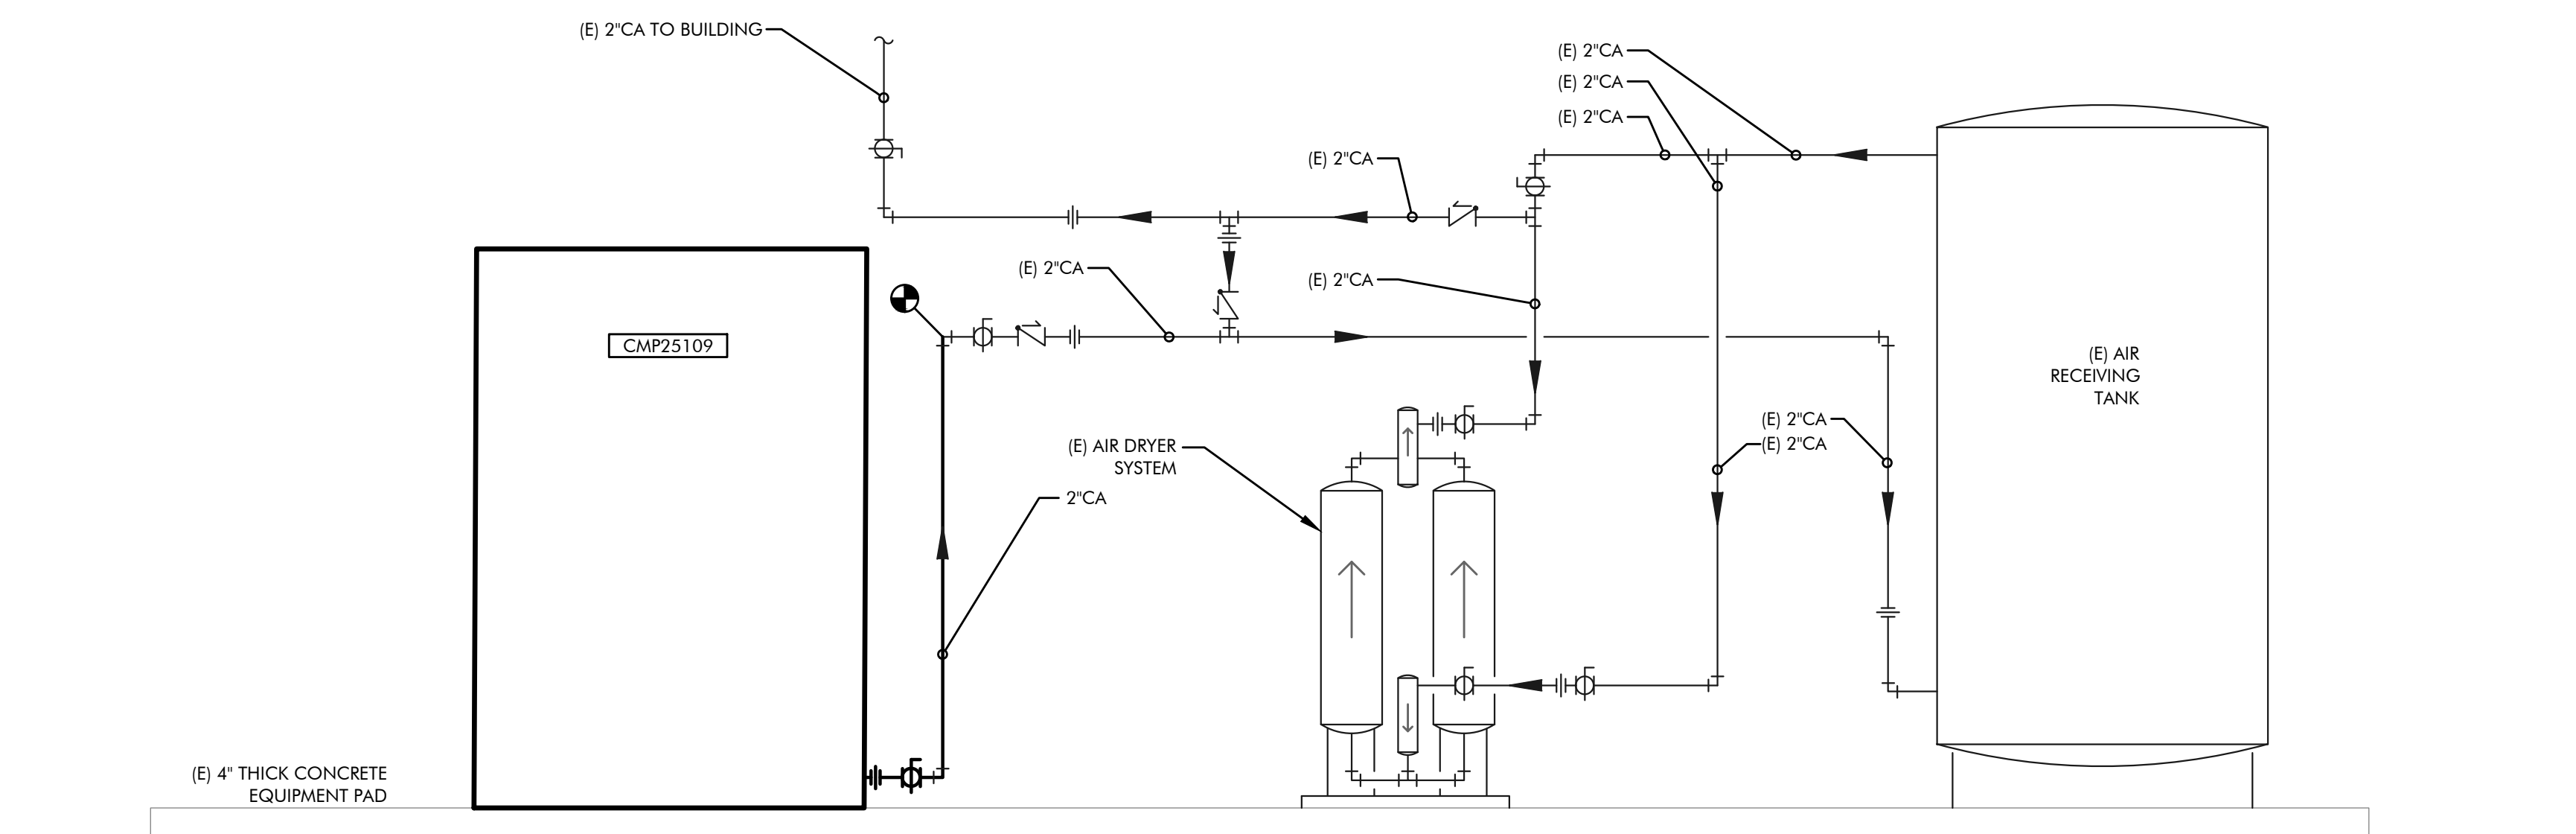


2 MECHANICAL COMPRESSED AIR PIPING DIAGRAM
M4.2 SCALE: NONE

DRAWING ON 11x17 SHEET IS HALF SCALE

REV	DATE	BY	DESCRIPTION	APVD	DATE

DESIGNED BB
DRAWN BB
CHECKED CLR
DATE 10/09/20

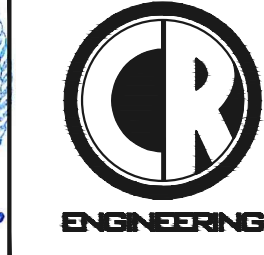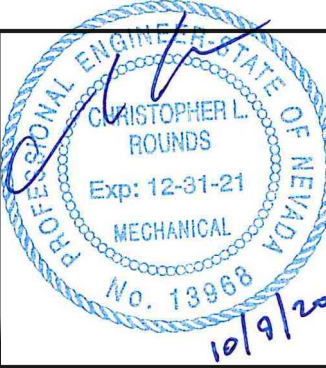


5434 LONGLEY LANE
RENO, NEVADA 89511
PHONE: (775) 826-1919
PROJECT NO: 135220




CITY OF SPARKS
TMWRF AIR COMPRESSOR #3 REPLACEMENT
MECHANICAL PIPING DIAGRAMS

VERIFY SCALES
BAR IS ONE INCH ON ORIGINAL DRAWING
0 1" IF NOT ONE INCH ON THIS SHEET, ADJUST SCALES ACCORDINGLY

JOB NO. 135220
DRAWING NO. M4.2
SHEET NO. 6 OF 12

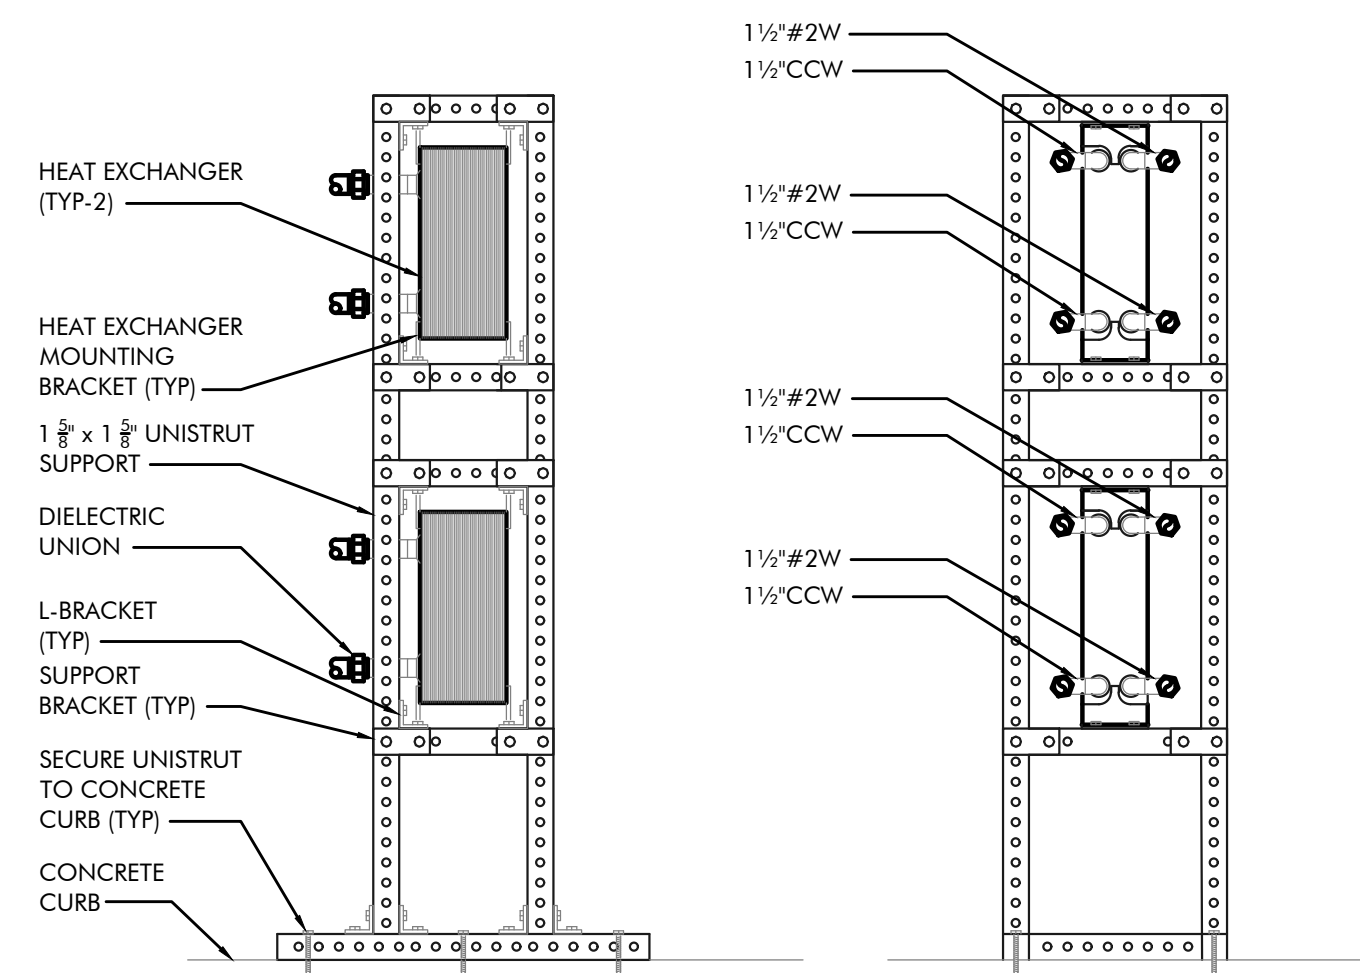

1 HEAT EXCHANGER MOUNTING DETAIL
 M5.1 SCALE: 1"=1'-0"

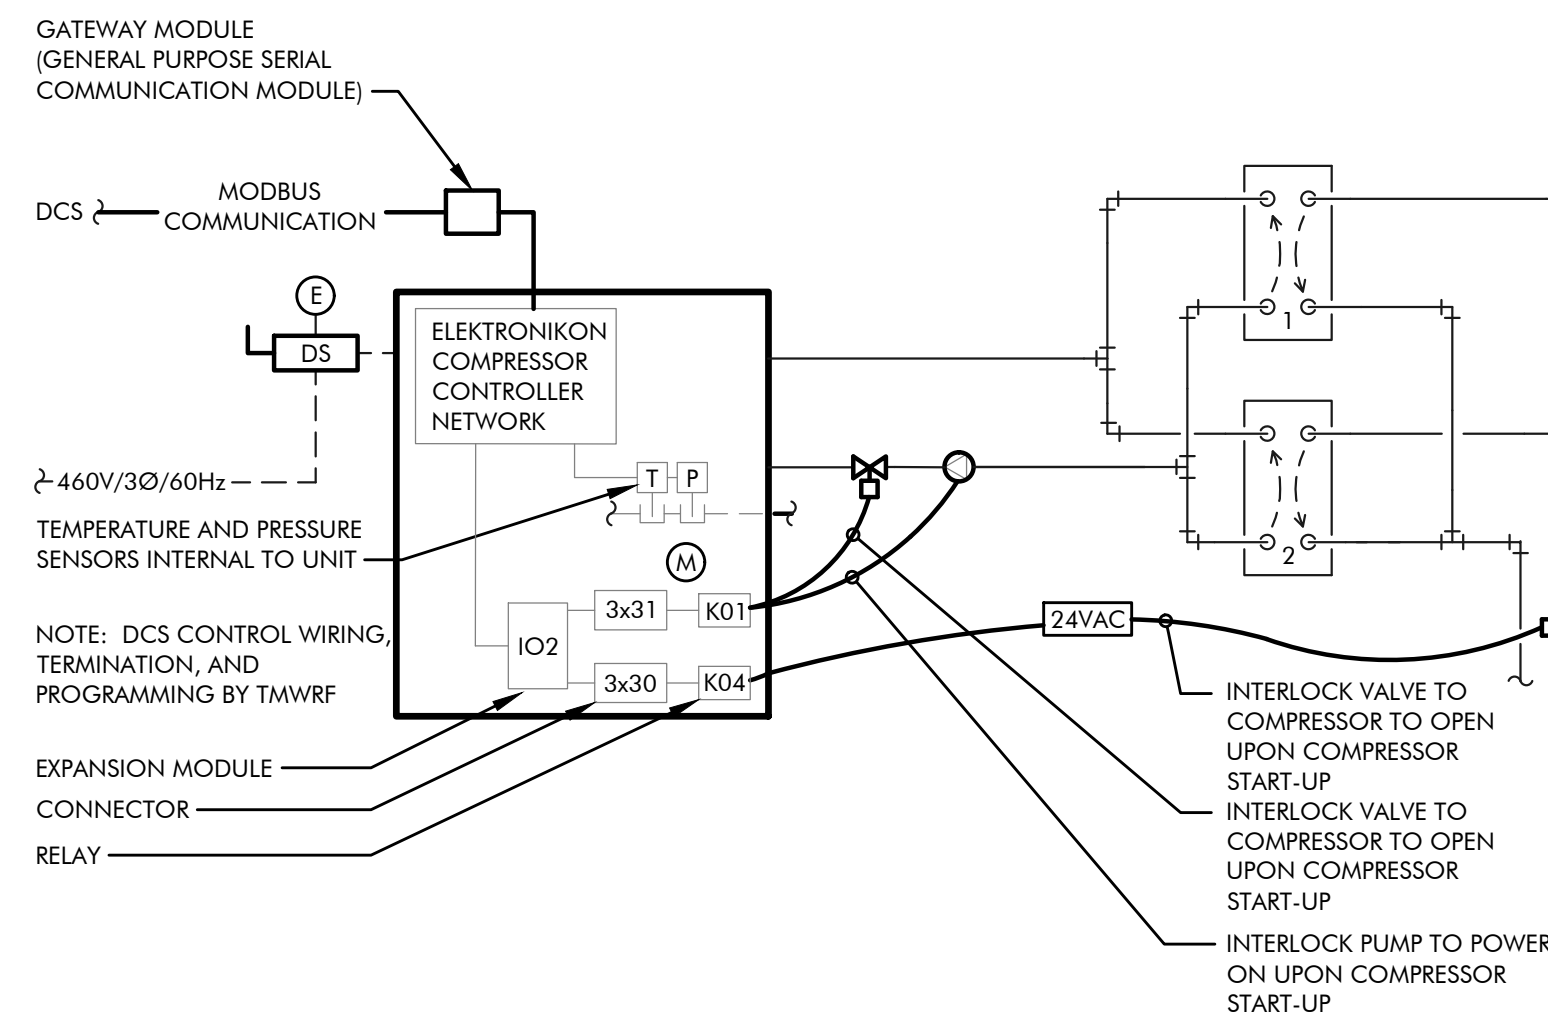

2 AIR COMPRESSOR AND HEAT EXCHANGER CONTROL DIAGRAM
 M5.1 SCALE: NONE

CONTROLS SYMBOL LEGEND

SYMBOL	DESCRIPTION
CS	CURRENT SENSOR
	2-WAY CONTROL VALVE
DS	DISCONNECT SWITCH
VFD	VARIABLE FREQUENCY DRIVE
	PUMP
	EQUIPMENT FURNISHED AND INSTALLED BY MECHANICAL CONTRACTOR
	EQUIPMENT FURNISHED AND INSTALLED BY ELECTRICAL CONTRACTOR
---	CONDUIT AND POWER WIRE FURNISHED AND INSTALLED BY ELECTRICAL CONTRACTOR
---	CONDUIT AND CONTROL WIRE FURNISHED AND INSTALLED BY ELECTRICAL CONTRACTOR

AIR COMPRESSOR SEQUENCE OF OPERATION

- AUTOMATIC OPERATION:**
- THE AIR COMPRESSOR WILL BE ENABLED WHEN PRESSURE DROPS BELOW THE SETPOINT. THE SETPOINT IS 100 PSI WITH A ±5 PSI DEADBAND (ADJUSTABLE).
 - WHEN THE COMPRESSOR IS POWERED-ON:
 - #2 WATER CONTROL VALVE SHALL OPEN. 24VAC WILL BE SUPPLIED FROM EXPANSION MODULE (IO2) THROUGH RELAY (K04) TO VALVE (MOV83190).
 - THE PUMP WILL POWER ON. 120V WILL BE SUPPLIED FROM EXPANSION MODULE (IO2) THROUGH RELAY (K01) TO PUMP (PMP83243).
 - ONCE THE PLANTS COMPRESSED AIR SYSTEM PRESSURE REQUIREMENTS HAVE BEEN MET THE COMPRESSOR WILL SHUT-DOWN, PUMP WILL SHUT OFF, AND #2 WATER CONTROL VALVE WILL SHUT OFF.
- HEAT EXCHANGERS:**
- HEAT EXCHANGERS ARE TO BE 100% REDUNDANT. ONCE HEAT EXCHANGER (1)* HAS FOULED UP, IT WILL BE COMPLETELY VALVED OFF AND HEAT EXCHANGER (2)* WILL BE VALVED ON. ONCE HEAT EXCHANGER (2)* IS WORKING, HEAT EXCHANGER (1)* IS TO BE REMOVED AND REPLACED.
- * HEAT EXCHANGER (1): HEX83241, HEAT EXCHANGER (2): HEX83242

DRAWING ON 11x17 SHEET IS HALF SCALE

REV	DATE	BY	DESCRIPTION	APVD	DATE

DESIGNED BB			5434 LONGLEY LANE RENO, NEVADA 89511 PHONE: (775) 826-1919 PROJECT NO: 135220		
DRAWN BB					
CHECKED CLR					
DATE 10/09/20					

CITY OF SPARKS
 TMWRF AIR COMPRESSOR #3 REPLACEMENT
 MECHANICAL DETAILS

VERIFY SCALES BAR IS ONE INCH ON ORIGINAL DRAWING 0 1" IF NOT ONE INCH ON THIS SHEET, ADJUST SCALES ACCORDINGLY	JOB NO. 135220 DRAWING NO. M5.1 SHEET NO. 7 OF 12
---	--

ELECTRICAL SYMBOLS AND NOMENCLATURE

	SINGLE-OUTLET RECEPTACLE		SINGLE-PHASE, 1-POLE CIRCUIT PATH (1/2" CONDUIT, (2) - #10 Cu, UNLESS OTHERWISE NOTED) BELOW FLOOR
	DOUBLE-OUTLET 'DUPLEX' RECEPTACLE		SINGLE-PHASE, 2-POLE CIRCUIT PATH (1/2" CONDUIT, (3) - #10 Cu, UNLESS OTHERWISE NOTED) BELOW FLOOR
	THREE-PHASE (3W) RECEPTACLE (CONFIGURATION AS NOTED)		THREE-PHASE, 1-POLE CIRCUIT PATH (1/2" CONDUIT, (4) - #10 Cu, UNLESS OTHERWISE NOTED) BELOW FLOOR
	QUADRUPLE-OUTLET 'QUAD' RECEPTACLE		RETURN CIRCUIT TO PANEL 'HOMERUN' (CIRCUIT AS NOTED) ABOVE FLOOR
	SPECIAL RECEPTACLE (VOLTAGE/CONFIGURATION AS NOTED)		CIRCUIT BREAKER (AMPS/POLES AS NOTED)
	JUNCTION BOX		FUSE (AMPS/POLES AS NOTED)
	FLOOR MOUNT RECEPTACLE		SHEET NOTE INDICATOR
	THERMOSTAT		EQUIPMENT NOTE INDICATOR
	SAFETY DISCONNECT SWITCH (SIZE/VOLTAGE/CONFIGURATION AS NOTED)		REVISION 'DELTA' NOTE INDICATOR
	COMBINATION SAFETY SWITCH/MAGNETIC STARTER		FEEDER NOTE INDICATOR
	TELEPHONE/DATA JUNCTION BACKBOX		48" 48" MOUNTING HEIGHT AFF. (ACTUAL HEIGHT AS NOTED)
	SINGLE-POLE TOGGLE SWITCH (VOLTAGE AS REQUIRED)		AFF. ABOVE FINISHED FLOOR
	PANELBOARD (NAME/AMP/PHASE/VOLTAGE/CONFIGURATION AS NOTED)		A.F.G. ABOVE FINISHED GRADE
	TRANSFORMER (NAME/KVA RATING/PHASE/VOLTAGE AS NOTED)		A.T.S. AUTOMATIC TRANSFER SWITCH
	INDICATES MECHANICAL EQUIPMENT		C CONDUIT
	PHOTO ELECTRIC CELL		CB CIRCUIT BREAKER
	TIME CLOCK		CLG CEILING
	CONTACTOR (CONFIGURATION AS NOTED)		(E) EXISTING
	DUCT DETECTOR FIRE ALARM SYSTEM COMPONENT		FACP FIRE ALARM CONTROL PANEL
	SINGLE-PHASE, 1-POLE CIRCUIT PATH (1/2" CONDUIT, (2) - #10 Cu, UNLESS OTHERWISE NOTED) ABOVE FLOOR		F.B.O. FURNISHED BY OTHERS
	SINGLE-PHASE, 2-POLE CIRCUIT PATH (1/2" CONDUIT, (3) - #10 Cu, UNLESS OTHERWISE NOTED) ABOVE FLOOR		GFI GROUND FAULT INTERRUPTING TYPE
	THREE-PHASE, 1-POLE CIRCUIT PATH (1/2" CONDUIT, (4) - #10 Cu, UNLESS OTHERWISE NOTED) ABOVE FLOOR		HID HIGH INTENSITY DISCHARGE
	RETURN CIRCUIT TO PANEL 'HOMERUN' (CIRCUIT AS NOTED) ABOVE FLOOR		L.T.G. LIGHTING
	MOTOR (HORSEPOWER AS NOTED)		N.T.S. NOT TO SCALE
	TYPICAL		M.C.B. MAIN CIRCUIT BREAKER
	UNDER GROUND		M.S.B. MAIN SWITCH BOARD
	UNLESS OTHERWISE NOTED		(N) NEW
	WEATHER PROOF		N.L. NIGHT LIGHT
	TRANSFORMER		O.A.A. OR APPROVED ALTERNATE

MECHANICAL EQUIPMENT CONNECTION SCHEDULE:

MEQ #	DISCONNECTING MEANS	STARTER	VOLTS / PH	FED FROM	CONDUIT & WIRE	LOAD KVA	NOTES
PMP25122	NEMA 5-20R & MATCHING CORD SET IN F.S. BOX	--	120 / 1	NOTE #4	1/2" C., (2) - #12 Cu & (1) - #12 Cu GND	0.53	1/6 HP
CMP25109	200A/175F/3P 600V, N12 DISC. SAFETY SWITCH	INCLUDED	480 / 3	MCC-6 POS# 3A	2" C., (3) - #2/0 Cu & (1) - #6 Cu GND	103.09	100 HP, NOTE #5 & #6

MECHANICAL EQUIPMENT CONNECTION SCHEDULE NOTES:

- ELECTRICAL CONTRACTOR SHALL VERIFY ALL ELECTRICAL, TEMPERATURE CONTROLS AND DUCT DETECTOR CONNECTIONS AS REQUIRED BY THE MECHANICAL DRAWINGS AND DETAILS PRIOR TO SUBMITTING A BID.
- SEE MECHANICAL PLANS FOR EXACT LOCATIONS OF MECHANICAL EQUIPMENT.
- CONTRACTOR'S BID SHALL INCLUDE NEW (OVERHEAD) CONDUITS AND PATHWAYS AS REQUIRED FOR ALL EQUIPMENT CONNECTIONS. NEVERTHELESS, CONTRACTOR MAY REUSE ANY EXISTING CONDUITS, BACK BOXES, AND PATHWAYS THAT ARE MADE AVAILABLE DURING THE DEMOLITION PHASE OF WORK.
- THE CIRCULATION PUMP (PMP25122) IS TO BE FED FROM AND CONTROLLED BY THE AIR COMPRESSOR (CMP25109) BUILT-IN CONTROL BOARD.
- REMOVE AND RETIRE (E) 200A BREAKER IN MCC-6 AT POSITION #3A FEEDING (E) AIR COMPRESSOR #3.
- PROVIDE AND INSTALL (N) 175A BREAKER IN MCC-6 AT POSITION #3A TO FEED (N) AIR COMPRESSOR #3.

DRAWING ON 11x17 SHEET IS HALF SCALE

<p>JENSEN ENGINEERING INC. Electrical Engineers 9655 Gateway Drive Reno, Nevada 89521-2968 Ph. (775) 852-2288 Fax (775) 852-3388 email: jeneng@nvtbell.com web: www.jeneng.com</p> <p>PERMIT SET</p>	REV	DATE	BY	DESCRIPTION	APVD	DATE		DESIGNED KPJ/GGJ	<p>5434 LONGLEY LANE RENO, NEVADA 89511 PHONE: (775) 826-1919 FAX: (775) 826-1918 PROJECT NO: 105717</p>		CITY OF SPARKS		VERIFY SCALES BAR IS ONE INCH ON ORIGINAL DRAWING	JOB NO. S195JK
								CHECKED GGJ			TMWRF AIR COMPRESSOR #3 REPLACEMENT ELECTRICAL SYMBOLS AND MECHANICAL EQUIPMENT CONNECTION SCHEDULE	0 1"	DRAWING NO. E0.1	
FILENAME:								DATE 10/09/2020				IF NOT ONE INCH ON THIS SHEET, ADJUST SCALES ACCORDINGLY	SHEET NO. 8 OF 12	

4

3

2

1

A

B


C

D

(D) AIR COMPRESSOR DISCONNECT

1 (D) AIR COMPRESSOR #CMP25109

(E) COMPRESSED AIR RECEIVING TANK

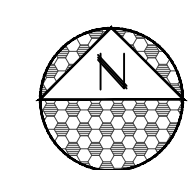

ELECTRICAL PARTIAL DEMOLITION FLOOR PLAN

SCALE: 1" = 1'-0"

A
E1.1


SHEET NOTES: (THIS SHEET ONLY)

- 1 REMOVE AND RETIRE (E) CONDUIT AND CONDUCTORS TO (E) AIR COMPRESSOR

DRAWING ON 11x17 SHEET IS HALF SCALE

JENSEN ENGINEERING INC.
 Electrical Engineers
 9655 Gateway Drive Reno, Nevada 89521-2968
 Ph. (775) 852-2288 Fax (775) 852-3388
 email: jeneng@nvtbell.com web: www.jeneng.com
PERMIT SET

REV	DATE	BY	DESCRIPTION	APVD	DATE

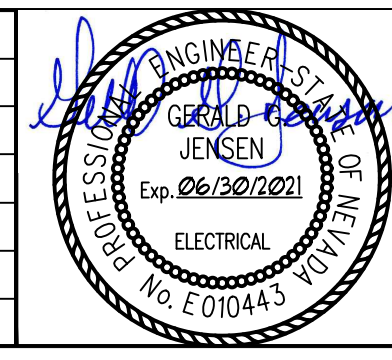


DESIGNED
KPJ/GGJ

DRAWN
KPJ

CHECKED
GGJ

DATE
10/09/2020

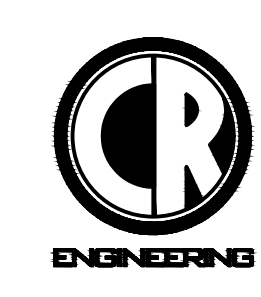

5434 LONGLEY LANE
 RENO, NEVADA 89511
 PHONE: (775) 826-1919
 FAX: (775) 826-1918
 PROJECT NO: 105717



TRUCKEE MEADOWS
 WATER RECLAMATION FACILITY

CITY OF SPARKS

TMWRF AIR COMPRESSOR #3 REPLACEMENT


ELECTRICAL PARTIAL DEMOLITION FLOOR PLAN

VERIFY SCALES
 BAR IS ONE INCH ON ORIGINAL DRAWING
 0 1" IF NOT ONE INCH ON THIS SHEET, ADJUST SCALES ACCORDINGLY

JOB NO.
S195JK

DRAWING NO.
E1.1

SHEET NO.
9 OF 12

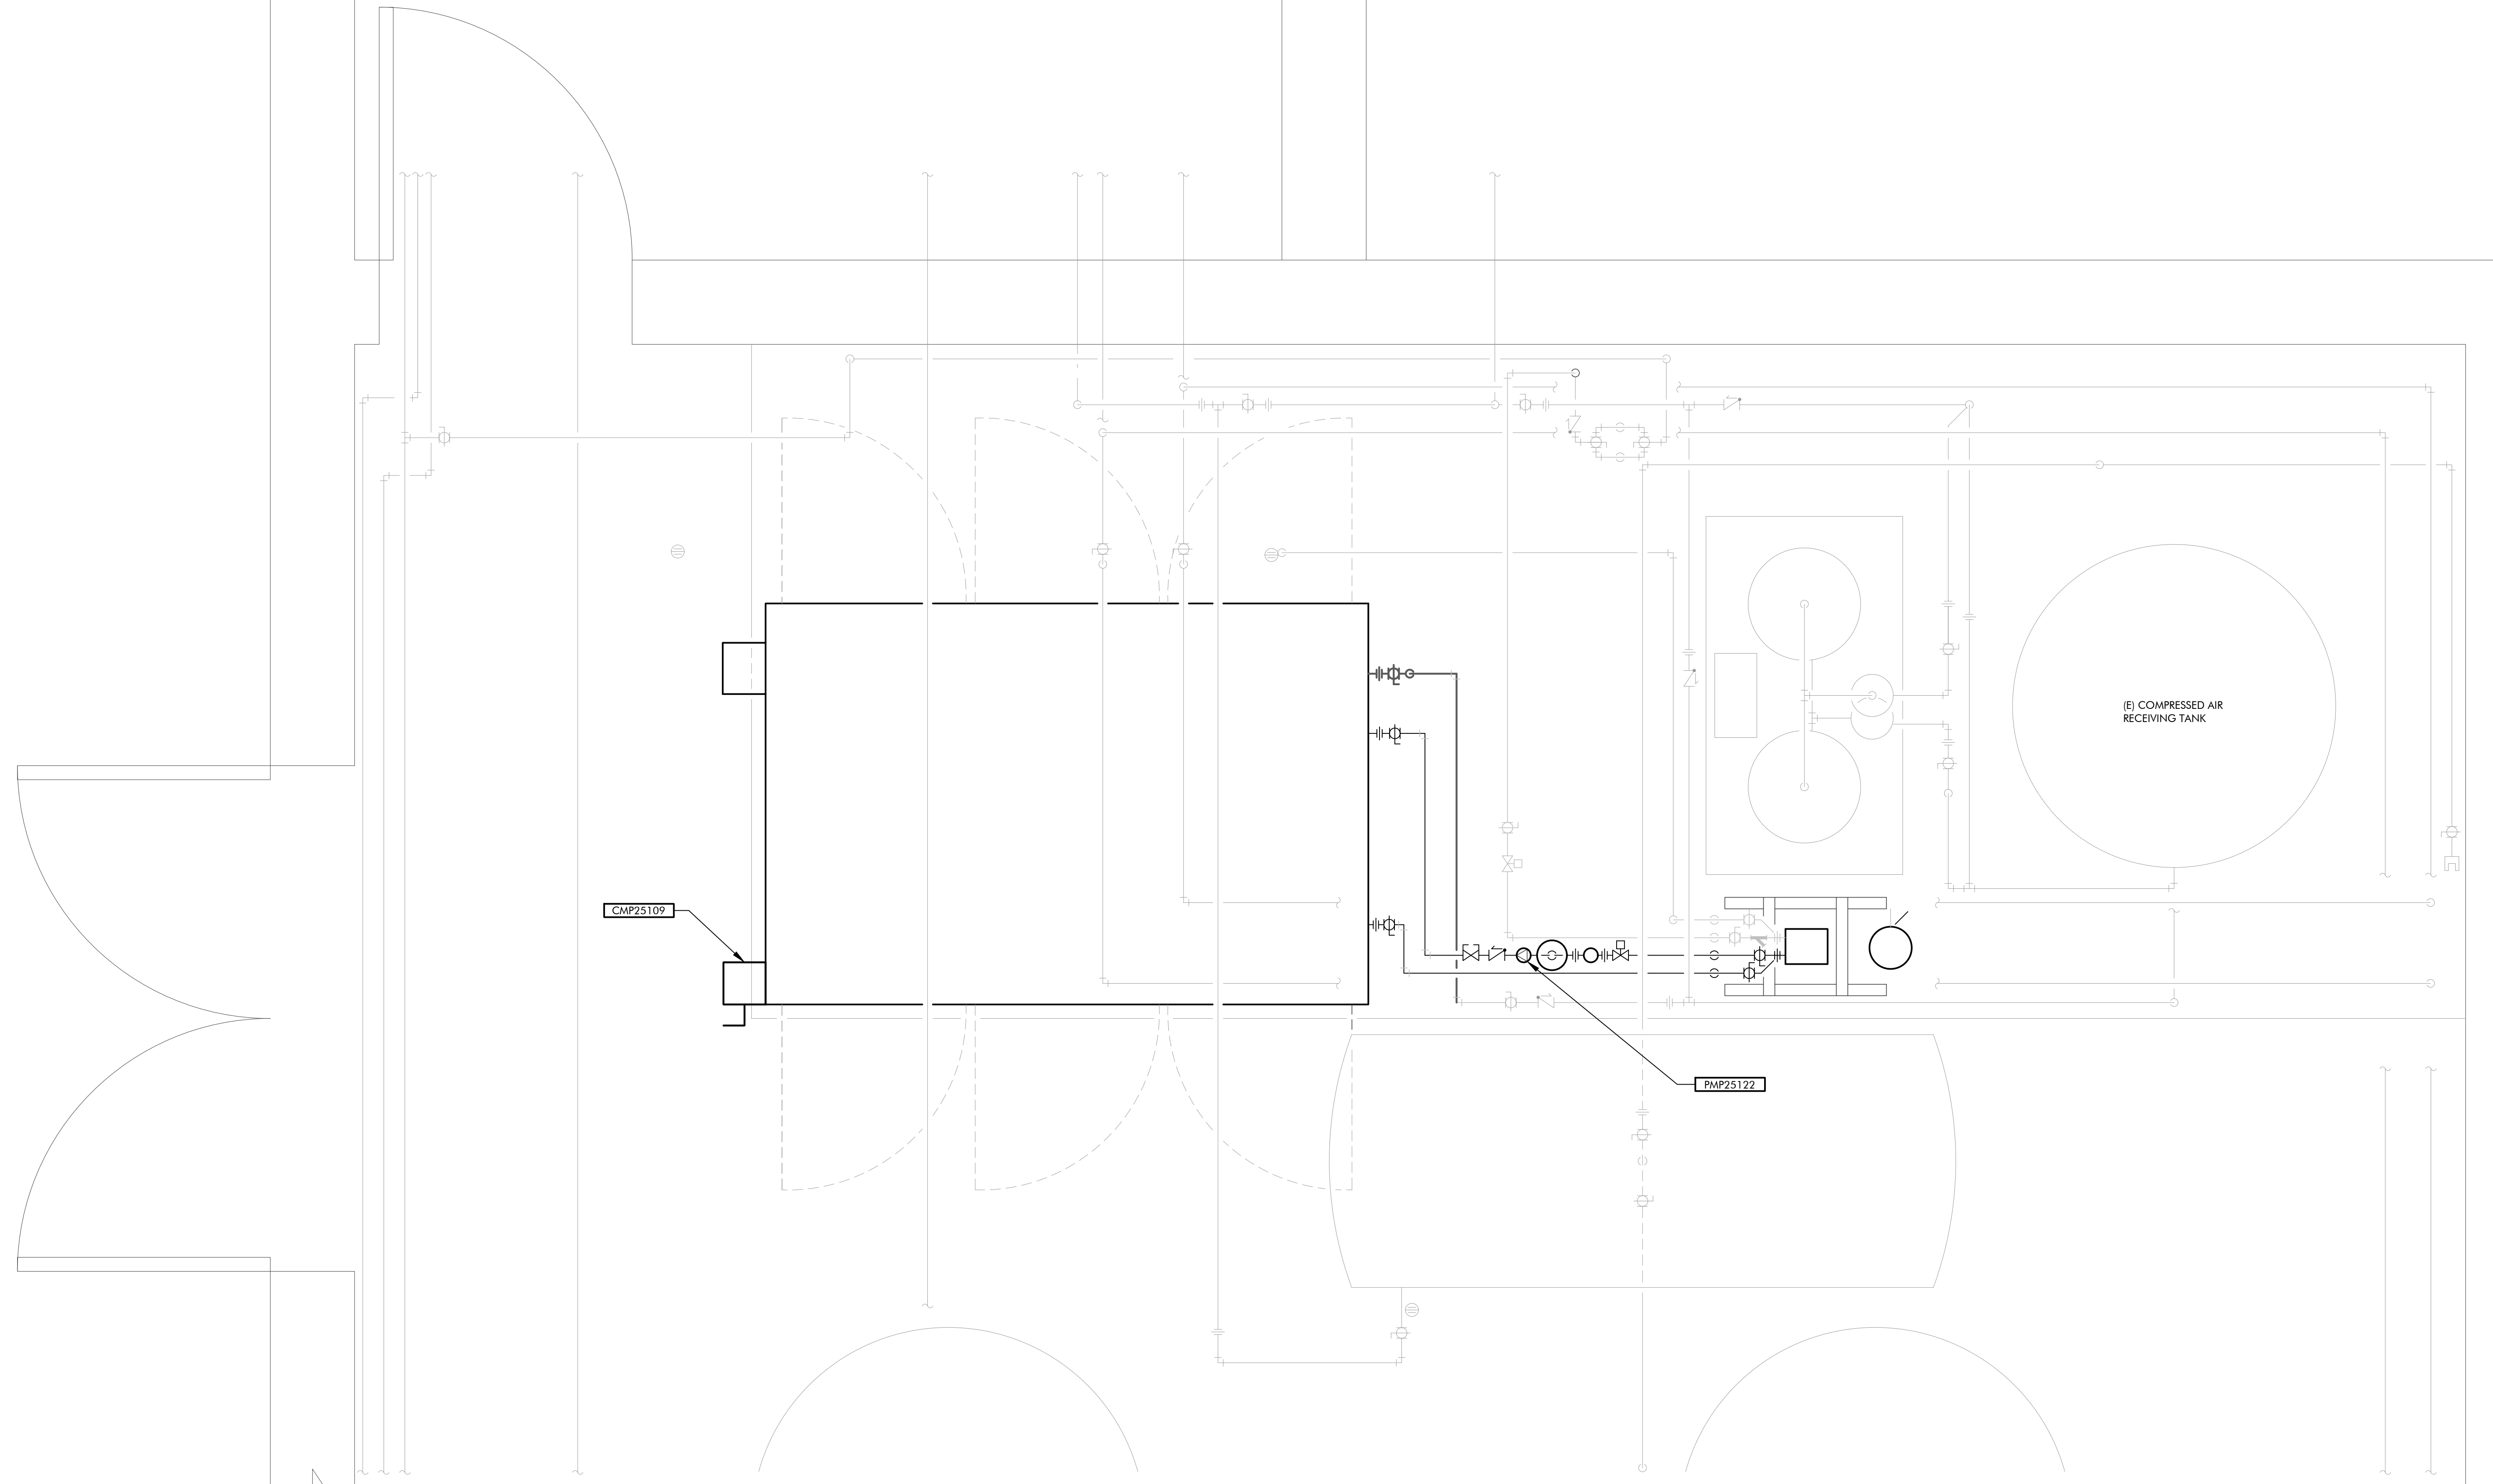


ELECTRICAL PARTIAL FLOOR PLAN
 SCALE: 1" = 1'-0" A
E2.1

DRAWING ON 11x17 SHEET IS HALF SCALE

JENSEN ENGINEERING INC. Electrical Engineers
 9655 Gateway Drive Reno, Nevada 89521-2968
 Ph. (775) 852-2288 Fax (775) 852-3388
 email: jeneng@nvtbell.com web: www.jeneng.com
PERMIT SET

REV	DATE	BY	DESCRIPTION	APVD	DATE

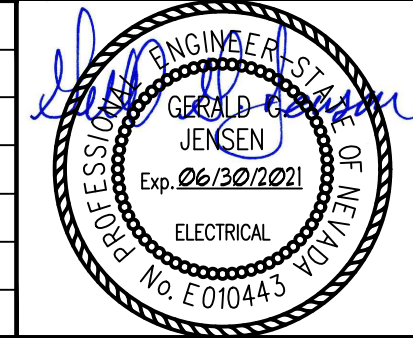

DESIGNED
KPJ/GGJ
 DRAWN
KPJ
 CHECKED
GGJ
 DATE
10/09/2020



ENGINEERING
 5434 LONGLEY LANE
 RENO, NEVADA 89511
 PHONE: (775) 826-1919
 FAX: (775) 826-1918
 PROJECT NO: 105717



CITY OF SPARKS
 TMWRF AIR COMPRESSOR #3 REPLACEMENT
ELECTRICAL PARTIAL FLOOR PLAN

VERIFY SCALES
 BAR IS ONE INCH ON ORIGINAL DRAWING
 0 1" IF NOT ONE INCH ON THIS SHEET, ADJUST SCALES ACCORDINGLY


JOB NO.
S195JK
 DRAWING NO.
E2.1
 SHEET NO.
10 OF 12

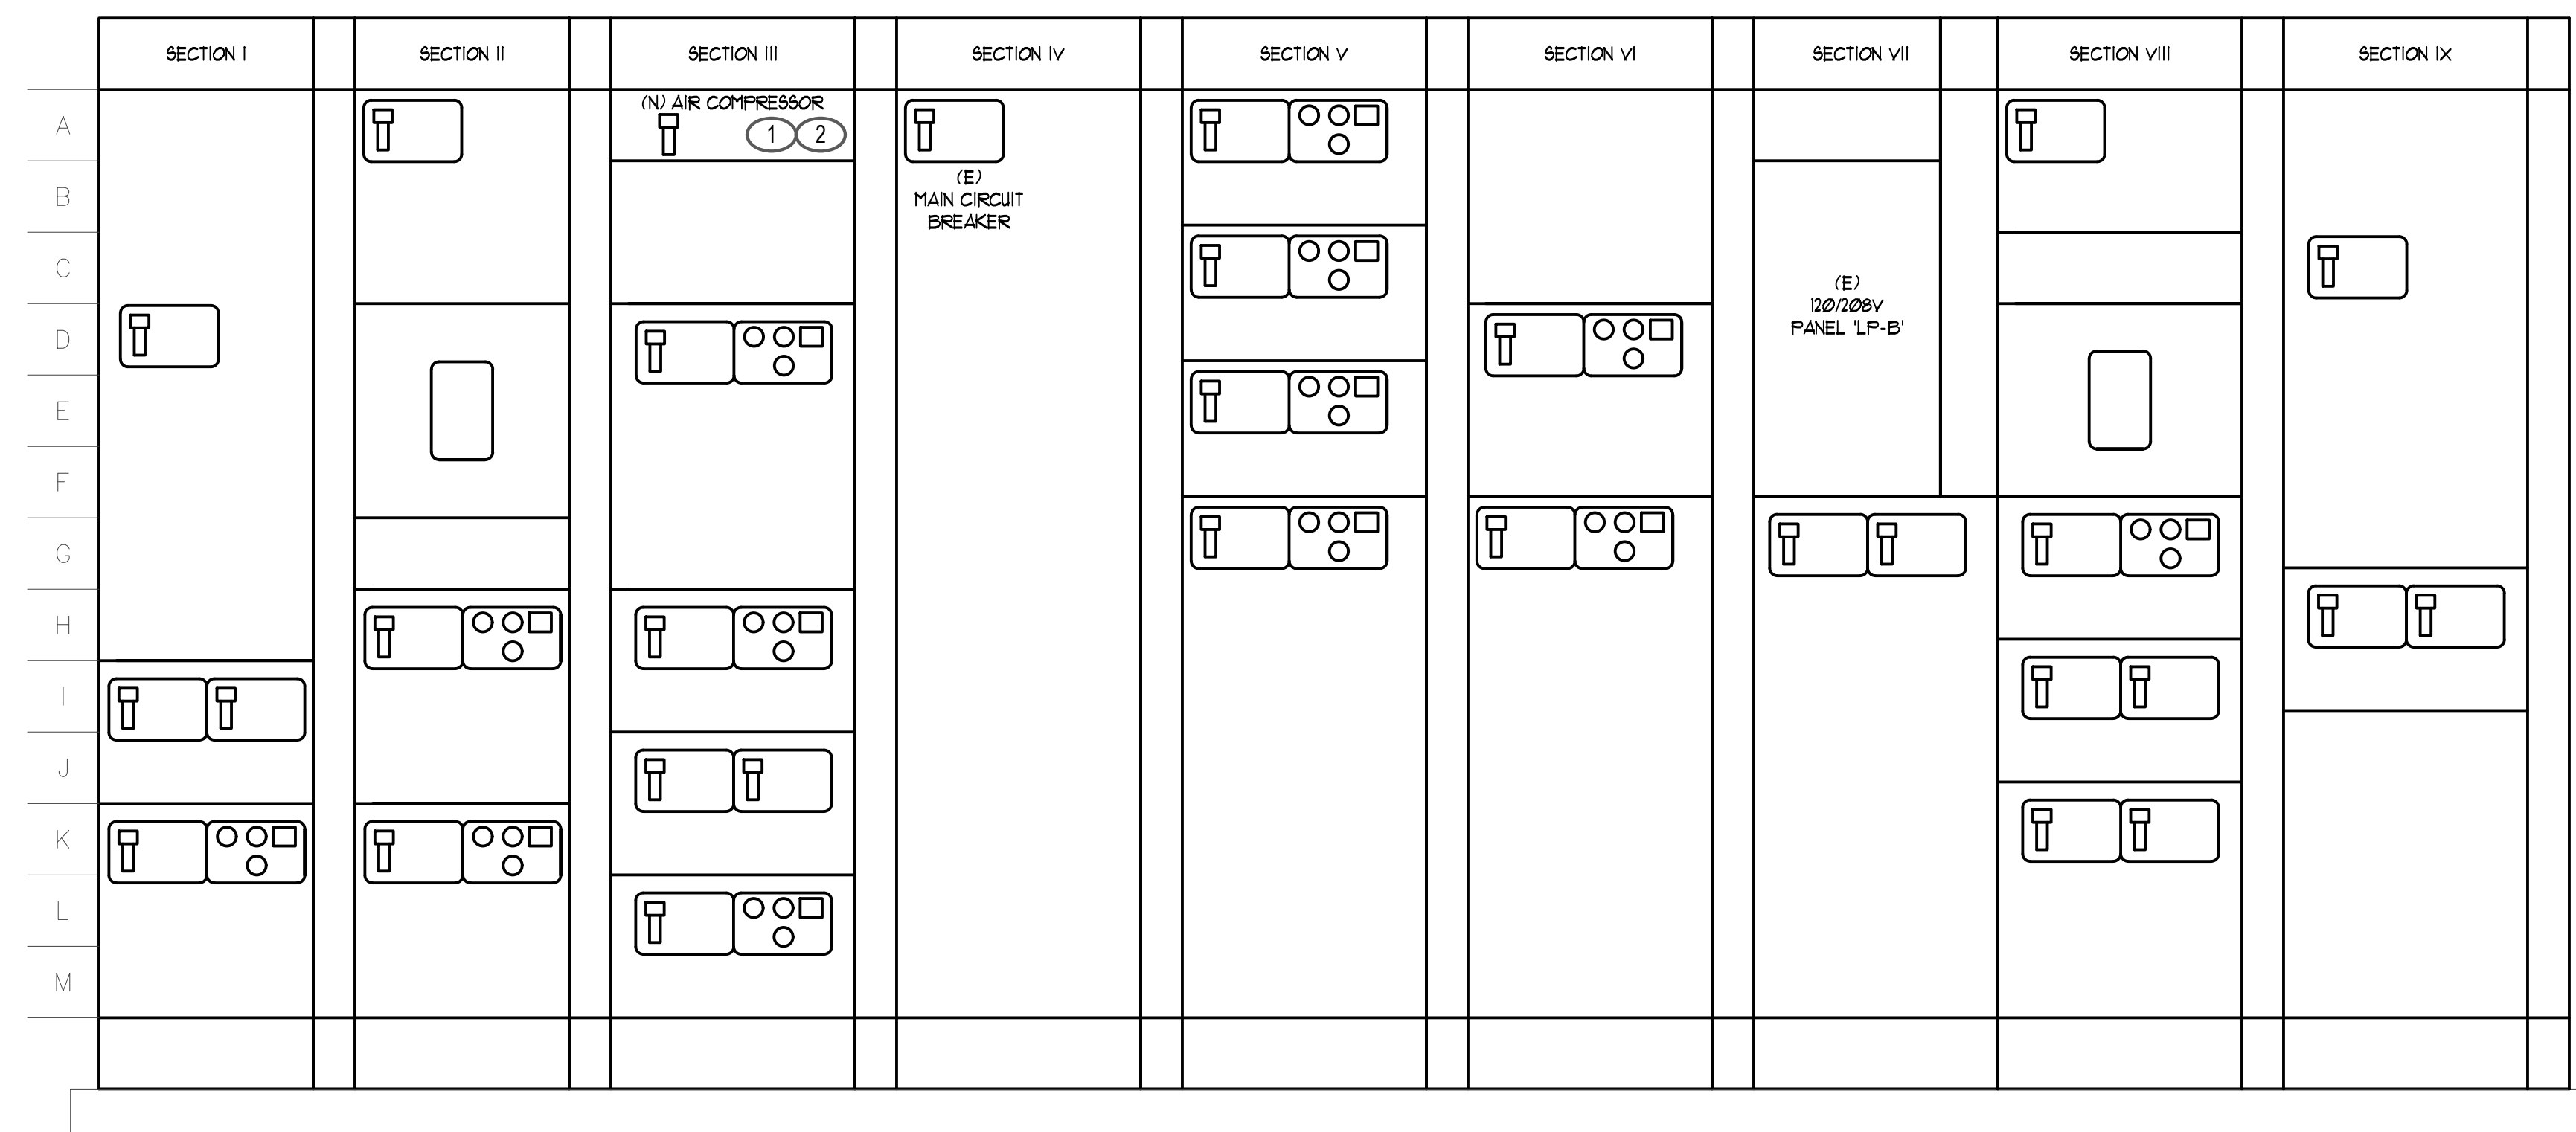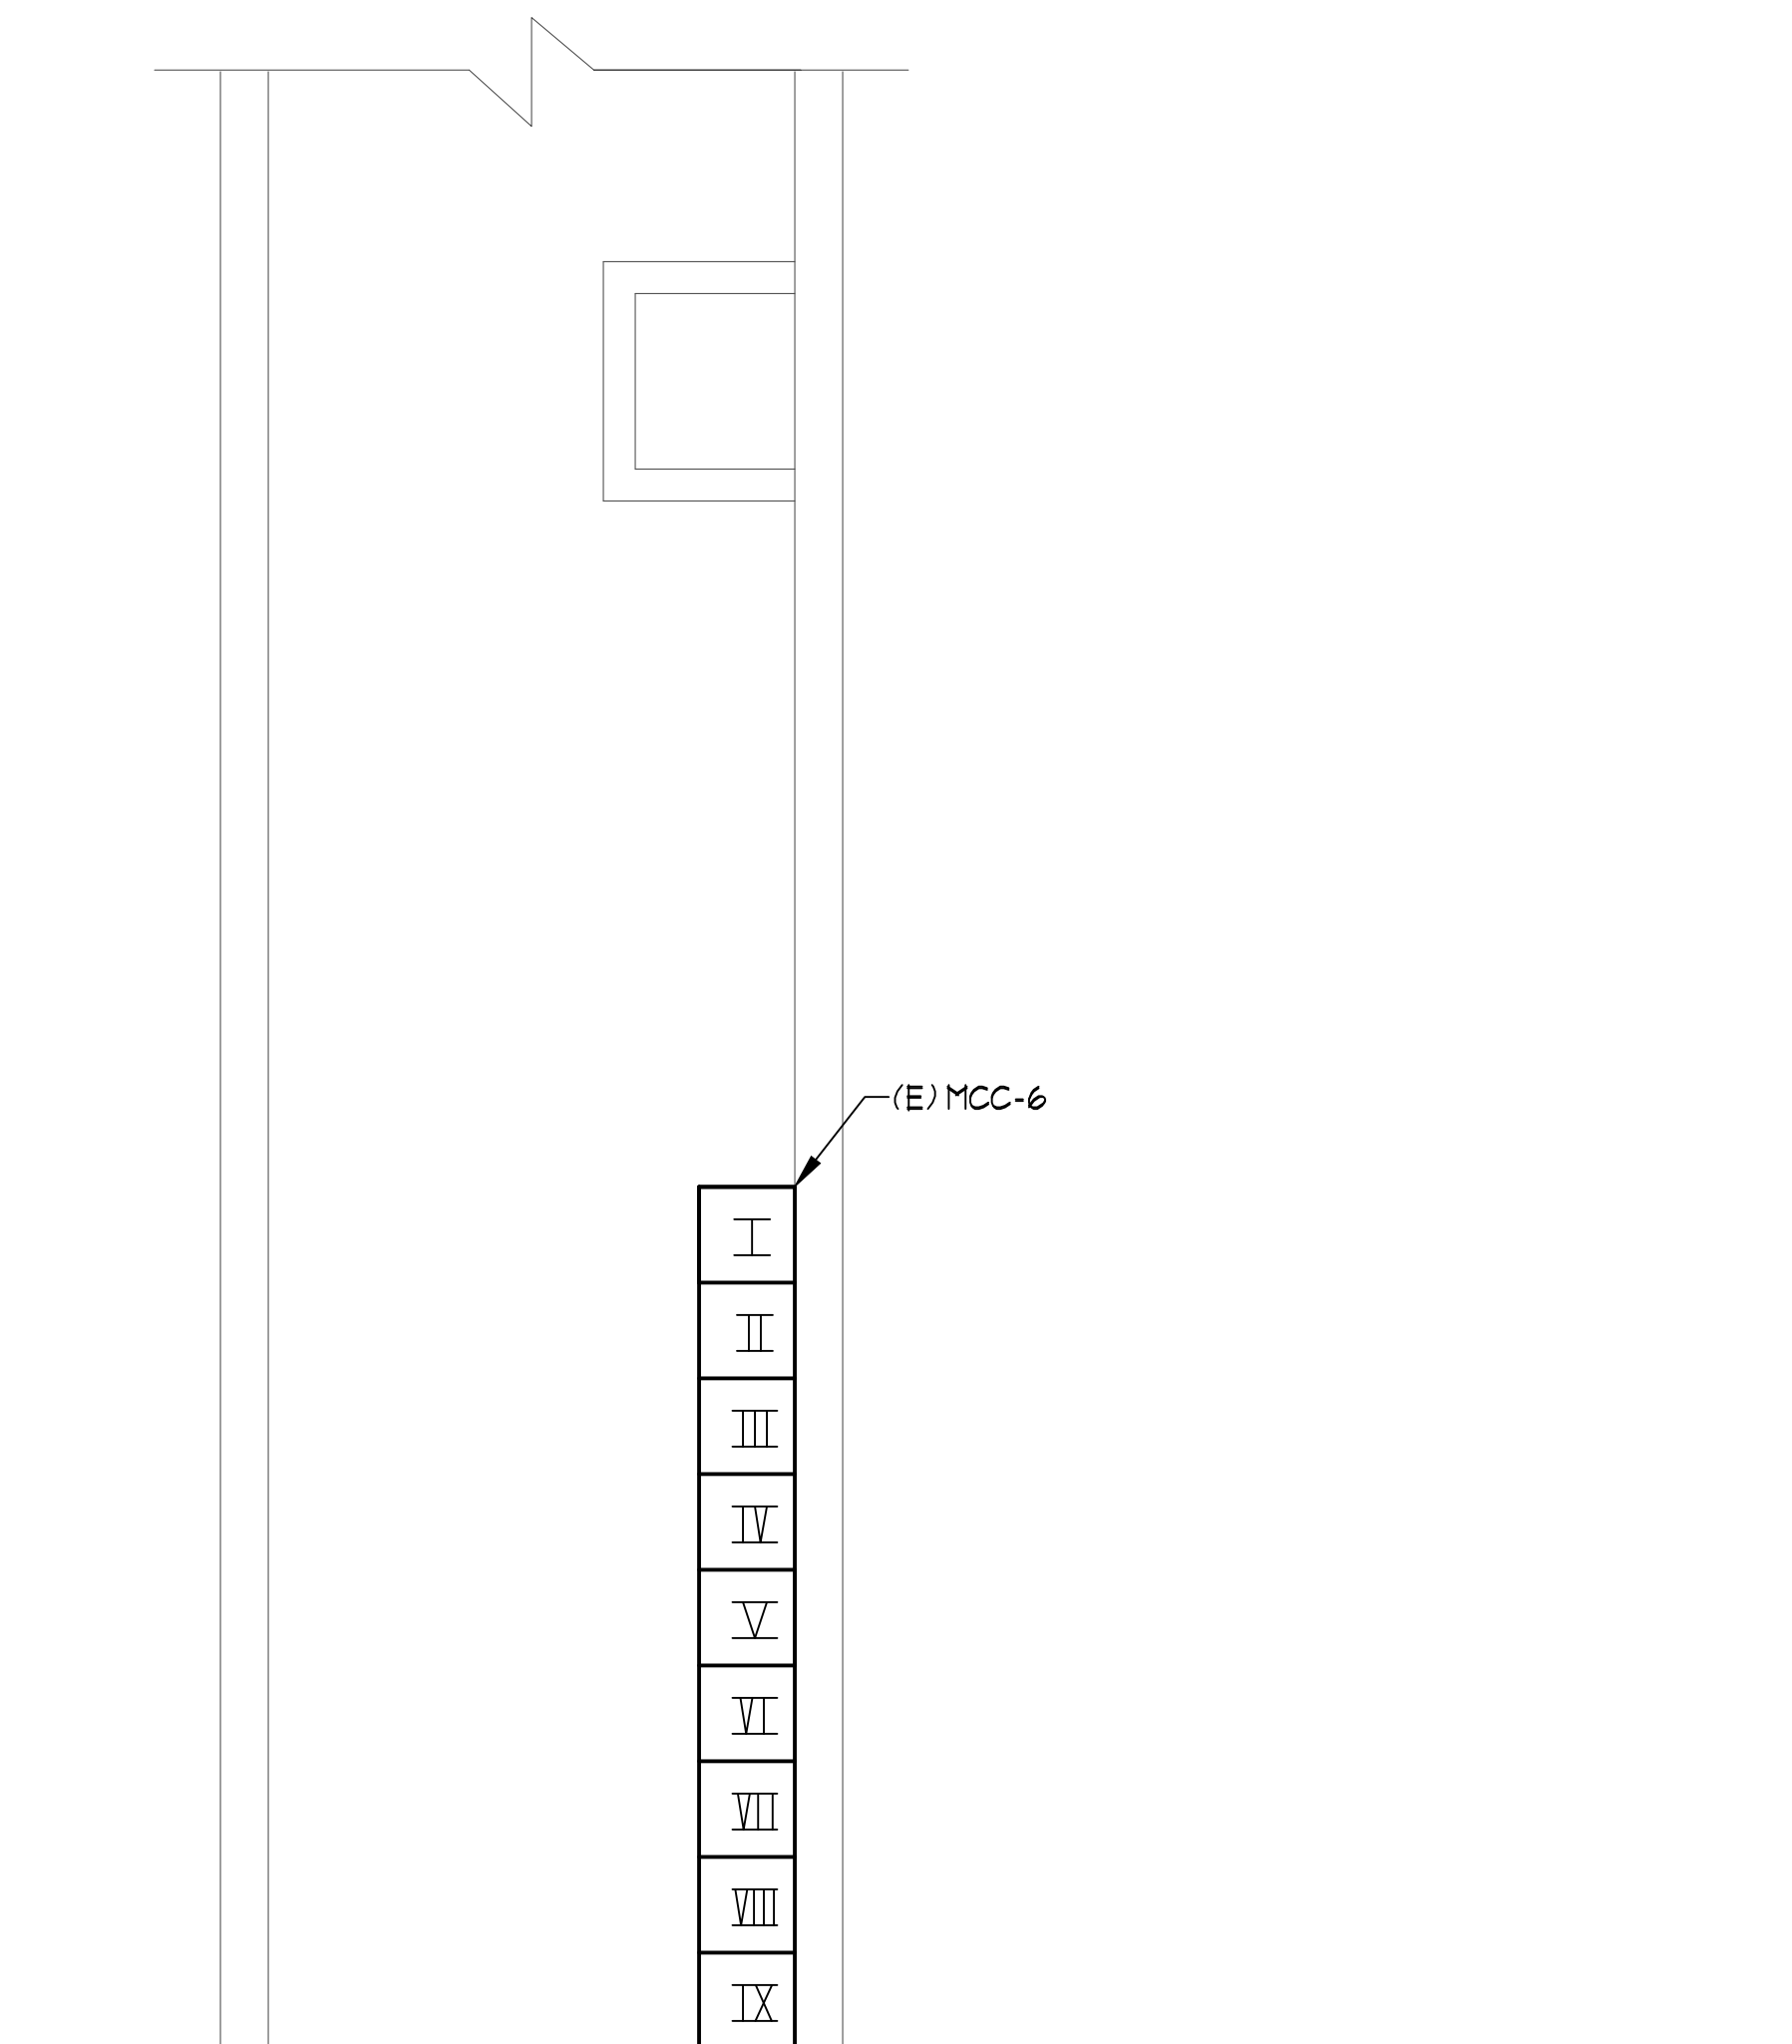

MCC-6 ELEVATION B
SCALE: 1" = 1'-0" E3.1

SHEET NOTES: (THIS SHEET ONLY)

- ① REMOVE AND RETIRE (E) 200A BREAKER IN MCC-16 AT POSITION #3A FEEDING (E) AIR COMPRESSOR #3.
- ② PROVIDE AND INSTALL (N) 175A BREAKER IN MCC-16 AT POSITION #3A TO FEED (N) AIR COMPRESSOR #3.

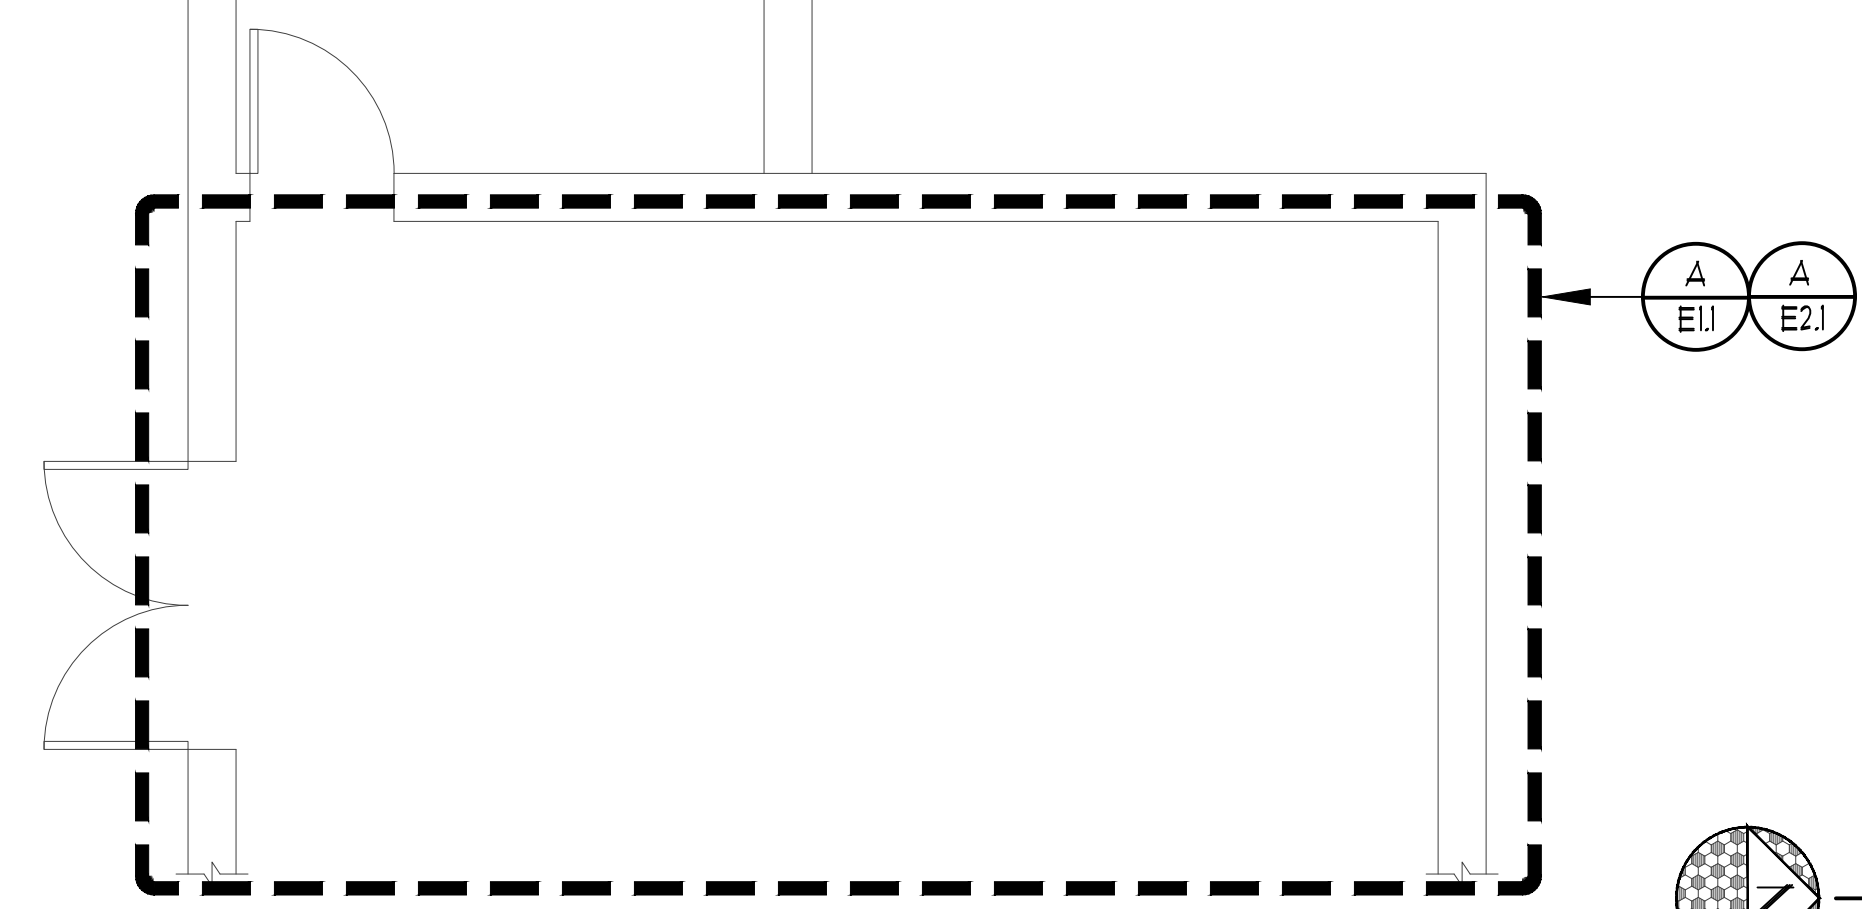


ELECTRICAL PARTIAL FLOOR PLAN A
SCALE: 1/4" = 1'-0" E3.1

DRAWING ON 11x17 SHEET IS HALF SCALE

JENSEN ENGINEERING INC. Electrical Engineers
9655 Gateway Drive Reno, Nevada 89521-2968
Ph. (775) 852-2288 Fax (775) 852-3388
email: jeneng@nvtbell.com web: www.jeneng.com

PERMIT SET

REV	DATE	BY	DESCRIPTION	APVD	DATE

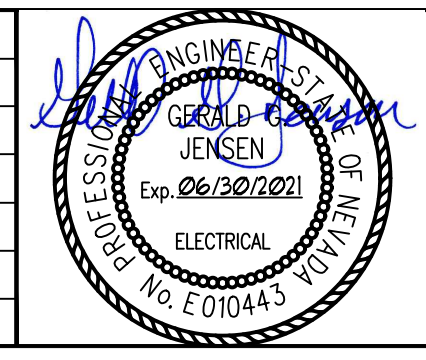

DESIGNED
KPJ/GGJ

DRAWN
KPJ

CHECKED
GGJ

DATE
10/09/2020

ENGINEERING

5434 LONGLEY LANE
RENO, NEVADA 89511
PHONE: (775) 826-1919
FAX: (775) 826-1918
PROJECT NO: 105717



CITY OF SPARKS

TMWRF AIR COMPRESSOR #3 REPLACEMENT

ELECTRICAL PARTIAL FLOOR PLAN

VERIFY SCALES
BAR IS ONE INCH ON ORIGINAL DRAWING


0 1" 1"

IF NOT ONE INCH ON THIS SHEET, ADJUST SCALES ACCORDINGLY

JOB NO.
S195JK

DRAWING NO.
E3.1

SHEET NO.
11 OF 12

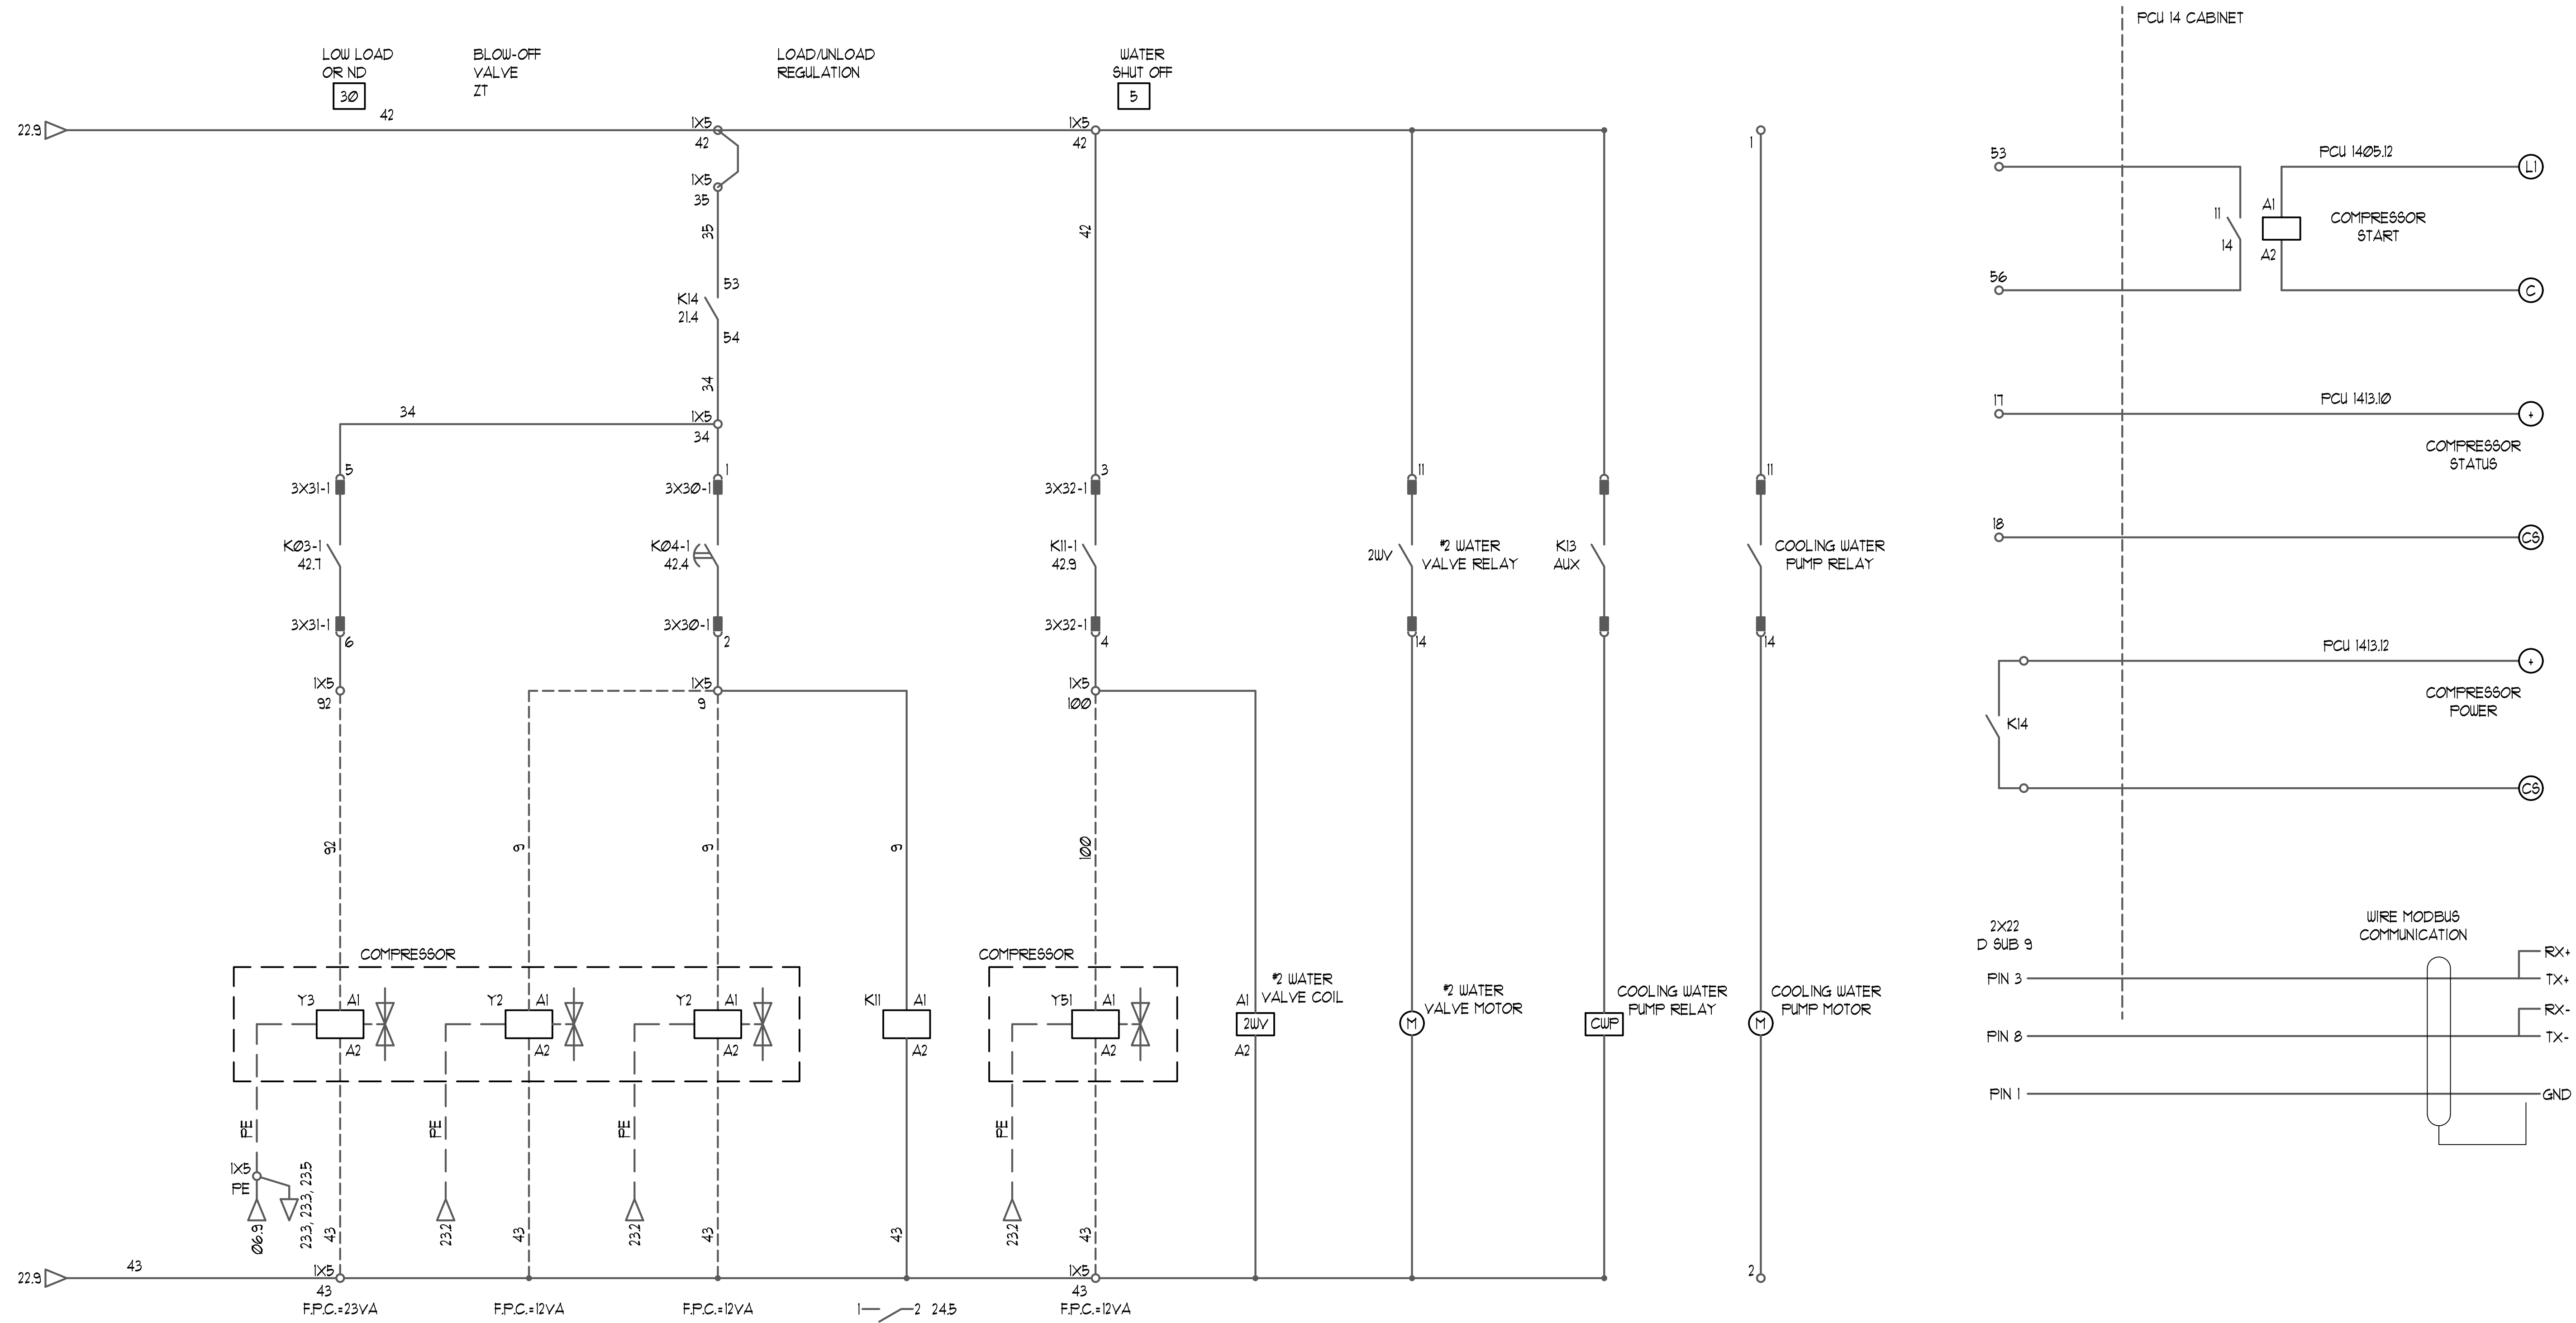

AIR COMPRESSOR SCHEMATIC


NOT TO SCALE

A
E4.1


DRAWING ON 11x17 SHEET IS HALF SCALE

JENSEN ENGINEERING INC.
 Electrical Engineers
 9655 Gateway Drive Reno, Nevada 89521-2968
 Ph. (775) 852-2288 Fax (775) 852-3388
 email: jeneng@nvtbell.com web: www.jeneng.com
PERMIT SET

REV	DATE	BY	DESCRIPTION	APVD	DATE

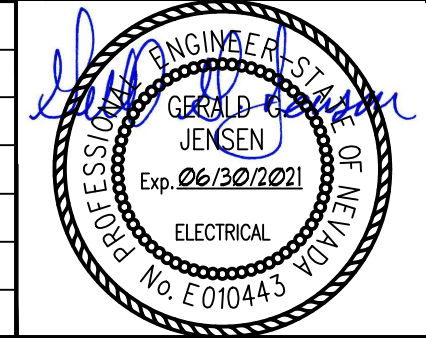

DESIGNED
KPJ/GGJ
 DRAWN
KPJ
 CHECKED
GGJ
 DATE
10/09/2020

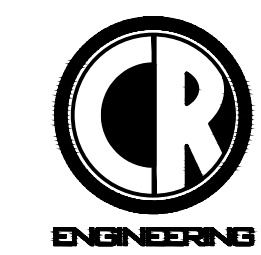

5434 LONGLEY LANE
 RENO, NEVADA 89511
 PHONE: (775) 826-1919
 FAX: (775) 826-1918
 PROJECT NO: 105717



CITY OF SPARKS
 TMWRF AIR COMPRESSOR #3 REPLACEMENT
 ELECTRICAL PARTIAL FLOOR PLAN

VERIFY SCALES
 BAR IS ONE INCH ON ORIGINAL DRAWING
 0 1" 1"
 IF NOT ONE INCH ON THIS SHEET, ADJUST SCALES ACCORDINGLY

JOB NO.
S195JK
 DRAWING NO.
E4.1
 SHEET NO.
12 OF 12