SPARKS, NEVADA

BID #21/22-002, PWP #WA-2021-356

OWNER:

CITY OF SPARKS

431 PRATER WAY
P.O. BOX 857

SPARKS, NV 89431-0857

PHONE: (775) 353-2273

FAX: (775) 353-2399

ENGINEER/SURVEYOR:


FARR WEST ENGINEERING

5510 LONGLEY LANE

RENO, NV 89511

PHONE: (775) 851-4788

FAX: (775) 851-0766

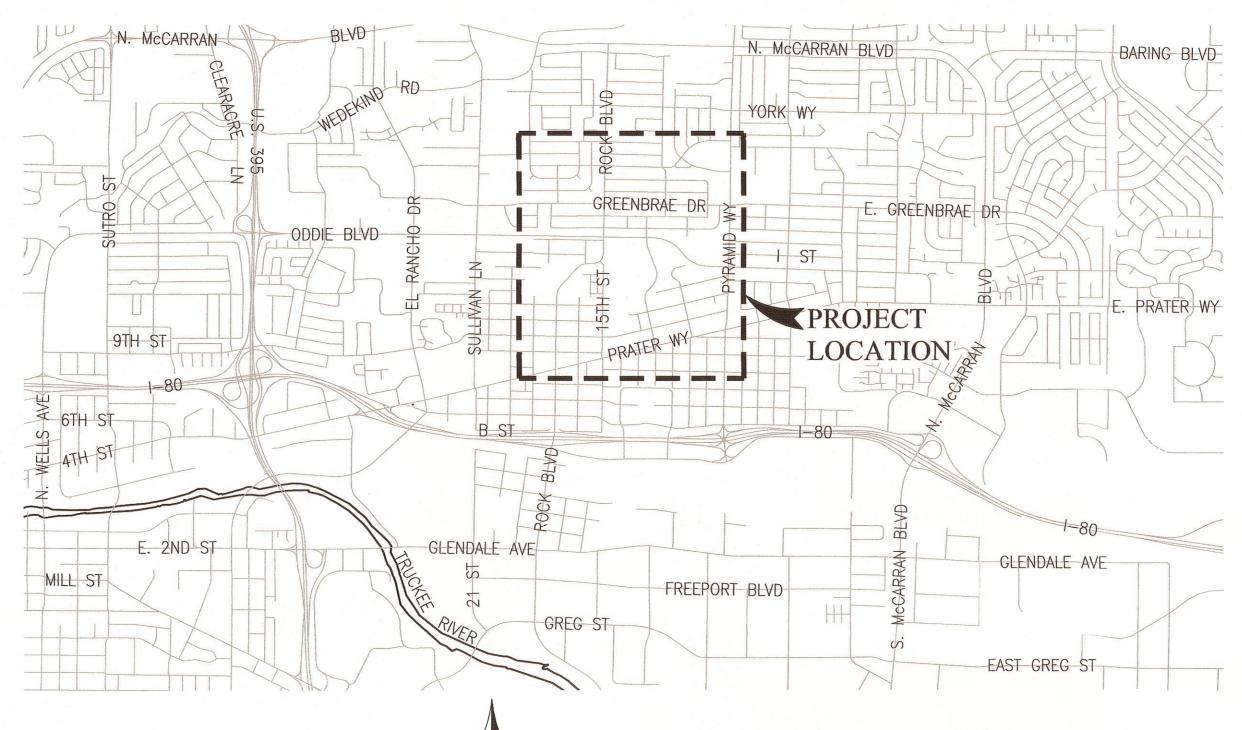

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JON R. ERICSON, P.E., P.T.O.E. CITY ENGINEER

.

CITY OF SPARKS

ED LAWSON
DONALD ABBOTT
DIAN VANDERWELL
PAUL ANDERSON
CHARLENE BYBEE
KRISTOPHER DAHIR
NEIL KRUTZ

MAYOR
COUNCIL MEMBER WARD 1
COUNCIL MEMBER WARD 2
COUNCIL MEMBER WARD 3
COUNCIL MEMBER WARD 4
COUNCIL MEMBER WARD 5
CITY MANAGER

Know what's below Call before you


FARR WEST ENGINEERING ASSUMES NO RESPONSIBILITY FOR EXISTING UTILITY LOCATIONS AND ELEVATIONS. THE UTILITIES SHOWN ON THESE DRAWINGS HAVE BEEN PLOTTED FROM THE BEST AVAILABLE INFORMATION. IT IS, HOWEVER, THE CONTRACTOR'S RESPONSIBILITY TO FIELD VERIFY THE LOCATION AND ELEVATION OF ALL UTILITIES PRIOR TO THE COMMENCEMENT OF ANY CONSTRUCTION. CONTRACTOR TO FIELD VERIFY ALL EXISTING SITE CONDITIONS PRIOR TO CONSTRUCTION. IF A CONFLICT EXISTS BETWEEN WHAT IS SHOWN ON THESE DRAWINGS AND WHAT EXISTS IN THE FIELD, THE CONTRACTOR IS TO NOTIFY THE ENGINEER IMMEDIATELY.

City of parks

ATE: JULY 2021 REVISION DESCRIPTION B'
CALE: SEE SHEET
ESIGNED: EYK
HECKED: KK

ENGINEERING

5510 LONGLEY LANE
RENO, NEVADA 89511
PHONE: (775) 851–4788
FAX: (775) 851–0766
FARRWESTENGINEERING.COM

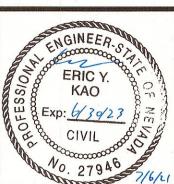

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DATE

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2. THE CONTRACTOR SHALL CALL THE CITY OF SPARKS PUBLIC WORKS FORTY-EIGHT (48) HOURS PRIOR TO THE START OF CONSTRUCTION, REQUIRED INSPECTIONS, AND TESTING.

3. MODIFICATIONS TO THE APPROVED PLANS REQUIRE REVIEW AND APPROVAL BY THE OWNER & ENGINEER. WORK PERFORMED WITHOUT WRITTEN APPROVAL WILL REQUIRE REMOVAL AT THE CONTRACTOR'S EXPENSE.

4. THE APPROVED PLANS, PERMITS AND INSPECTION RECORDS MUST BE ON THE JOBSITE AT ALL TIMES.

5. OUTSIDE OF AN UNFORESEEN CIRCUMSTANCE, SEWER MAIN SHUTDOWNS AND INTERRUPTION OF SERVICE IS NOT PERMITTED UNLESS APPROVED BY OWNER AND ENGINEER WITH PROPER NOTIFICATIONS PROVIDED. OWNER APPROVAL IS REQUIRED 48 HOURS PRIOR TO NOTIFICATION OF CUSTOMERS. RESIDENTIAL CUSTOMERS SHALL RECEIVE 48 HOURS WRITTEN NOTICE. THE OWNER IS RESPONSIBLE FOR THE NOTIFICATION WHEN WORK IS PERFORMED BY THE OWNER. THE CONTRACTOR IS RESPONSIBLE IN ALL OTHER CASES. A LIST SHALL BE KEPT BY THE RESPONSIBLE PARTY LISTING THE DATE, TIME, AND ADDRESS OF ALL PERSONS NOTIFIED. THE CONTRACTOR WILL BE SUBJECT TO DAMAGE CLAIMS SHOULD THEY FAIL TO NOTIFY CUSTOMERS OR MAINTAIN DOCUMENTATION OF NOTIFICATION OF CUSTOMERS. THE CONTRACTOR SHALL NOT OPERATE ANY EXISTING WATER VALVES WITHOUT AUTHORIZATION OF THE UTILITY OWNER.

6. CONTRACTOR SHALL PURSUE WORK IN A CONTINUOUS AND DILIGENT MANNER CONFORMING TO ALL PERTINENT SAFETY REGULATIONS TO ENSURE A TIMELY COMPLETION OF THE PROJECT.

7. ALL CONSTRUCTION SHALL BE CLOSELY COORDINATED WITH THE OWNER SO THAT THE QUALITY OF WORK CAN BE CHECKED FOR

8. MAINTAIN THE SITE IN A NEAT AND ORDERLY MANNER THROUGHOUT THE CONSTRUCTION PROCESS. ALL MATERIALS SHALL BE STORED WITHIN APPROVED CONSTRUCTION AREAS ON PAVED SURFACES ONLY. CONTRACTOR SHALL STORE/CONTAIN, HANDLE AND TRANSPORT HAZARDOUS OR FLAMMABLE MATERIALS TO MINIMIZE THE POTENTIAL FOR SPILLS, FIRES OR EXPLOSIONS. STORAGE/CONTAINMENT, HANDLING AND TRANSPORT OF HAZARDOUS OR FLAMMABLE MATERIALS SHALL BE IN ACCORDANCE WITH LOCAL, STATE OR FEDERAL REQUIREMENTS.

9. CONTRACTOR SHALL MAINTAIN AND OPERATE EQUIPMENT IN A MANNER TO MINIMIZE THE POTENTIAL FOR SPILLS. SPILLS OF HAZARDOUS OR FLAMMABLE MATERIALS SHALL BE IMMEDIATELY REPORTED TO THE OWNER OR OWNER REPRESENTATIVE.

10. CONTRACTOR SHALL OPERATE VEHICLES IN ACCORDANCE WITH STATE AND LOCAL REQUIREMENTS. VEHICLE AND EQUIPMENT OPERATORS SHALL BE PROPERLY LICENSED AND TRAINED.

11. VEHICLE ACCIDENTS, INJURIES, SPILLS OR OTHER INCIDENTS SHALL BE IMMEDIATELY REPORTED TO THE OWNER OR OWNER REPRESENTATIVE.

12. ROAD SHOULDERS MAY NOT BE UTILIZED FOR OVERNIGHT EQUIPMENT AND MATERIALS STORAGE, BUT MAY BE USED FOR THE APPLICABLE SECTION OF EACH DAY'S WORK. CONTRACTOR SHALL INQUIRE WITH THE CITY OF SPARKS FOR STAGING AREA. CONTRACTOR SHALL BE RESPONSIBLE FOR THE SECURITY OF ALL EQUIPMENT AND MATERIALS. CONTRACTOR MAY OBTAIN PERMISSIONS TO STAGE AT OTHER LOCATIONS ON OWN ACCORD.

13. THE CONTRACTOR SHALL BE RESPONSIBLE FOR PROTECTION OF ALL EXISTING SURVEY MONUMENTS AND SHALL REPLACE ANY MONUMENTS OBLITERATED OR DAMAGED DURING CONSTRUCTION AT OWN EXPENSE, REPLACEMENT SHALL BE PERFORMED BY A LICENSED PROFESSIONAL LAND SURVEYOR.

14. THE CONTRACTOR SHALL UTILIZE CONSTRUCTION TECHNIQUES TO MINIMIZE GRADING, VEGETATION REMOVAL, AND SURFACE DISTURBANCE. CONTRACTOR WILL BE RESPONSIBLE FOR THE RESTORATION OF ALL LANDSCAPING, SOD, CURBS, ASPHALT, DRIVEWAY PAVERS, RIP RAP, RETAINING WALLS, IRRIGATION PIPING AND LANDSCAPE LIGHTING TO EQUAL OR BETTER THAN EXISTING CONDITION. ALL COST FOR RESTORATION WILL BE INCLUDED IN THE APPLICABLE BID ITEM.

15. THE CONTRACTOR SHALL SUBMIT SUBMITTALS OF ALL MATERIALS TO BE USED ON THE SITE TO INCLUDE, BUT NOT BE LIMITED TO, ASPHALT MIX DESIGN, AGGREGATE BASE QUALIFICATIONS, PIPE BEDDING, PIPING, AND CIPP PRODUCTS PER SPECIFICATION SECTIONS 306D AND 306E TO THE PROJECT ENGINEER FOR APPROVAL PRIOR TO THE MANUFACTURER OR USE OF SUCH ITEMS.

16. IT SHALL BE THE RESPONSIBILITY OF THE CONTRACTOR TO VISIT AND MAKE OWN INTERPRETATIONS WITH REGARD TO MATERIALS. MEANS AND METHODS, AND EQUIPMENT NECESSARY TO PERFORM THE WORK REQUIRED FOR THIS PROJECT PRIOR TO BIDDING AND ORDERING MATERIALS.

17. ANY HAZARDOUS MATERIALS COLLECTED SHALL BE DISPOSED OF IN ACCORDANCE WITH ALL APPLICABLE HAZARDOUS MATERIALS LAWS AND REGULATIONS.

18. CONTRACTOR SHALL EXAMINE THE PROJECT WORK AREAS PRIOR TO BIDDING TO SATISFY HIMSELF AS TO THE NATURE AND EXTENT OF EXISTING SITE CONDITIONS THAT WILL BE ENCOUNTERED.

19. THE CONTRACTOR SHALL BE RESPONSIBLE FOR JOB SITE CONDITIONS DURING THE COURSE OF CONSTRUCTION OF THIS PROJECT, INCLUDING SAFETY OF ALL PERSONS AND PROPERTY. THIS REQUIREMENT SHALL APPLY CONTINUOUSLY, AND NOT BE LIMITED TO NORMAL WORKING HOURS AND SUBJECT TO THE SPECIAL PROVISIONS OF THE CONTRACT.

20. THE CONTRACTOR SHALL BE RESPONSIBLE FOR ALL EXCAVATING AND SHORING PROCEDURES AND CONFORM TO THE LATEST O.S.H.A. REQUIREMENTS.

21. THE CONTRACTOR SHALL OBTAIN AND PAY FOR ANY OTHER NECESSARY PERMITS AND FEES REQUIRED PRIOR TO BEGINNING WORK.

22. PROJECT BEARINGS IS BASED ON NEVADA STATE PLANE COORDINATE SYSTEM, WEST ZONE, NORTH AMERICAN DATUM OF 1983/1994, HIGH ACCURACY REFERENCE NETWORK (NAD 83/94-HARN). ALL DIMENSIONS SHOWN ARE GRID DISTANCES. COMBINED GRID-TO-GROUND FACTOR=1.000197939. NO SURVEY FIELDWORK WAS PERFORMED FOR THIS PROJECT.

23. ALL SANITARY SEWER MANHOLE RIM AND INVERT (FROM CENTER OF MANHOLE) ELEVATIONS WERE RETRIEVED FROM THE CITY OF SPARKS GEOGRAPHIC INFORMATION SYSTEM'S SPARKS SEWER CONDITION ASSESSMENT APP DATED JUNE 11, 2021. NO SURVEY FIELDWORK WAS PERFORMED FOR THIS PROJECT.

EROSION CONTROL NOTES

I. BEST MANAGEMENT PRACTICES SHALL BE IN PLACE FOR DUST CONTROL, SEDIMENT CONTROL, AND EROSION CONTROL DURING CONSTRUCTION.

2. THE CONTRACTOR SHALL INCORPORATE ADEQUATE DRAINAGE PROCEDURES DURING THE CONSTRUCTION PROCESS TO ELIMINATE EXCESSIVE EROSION OR PONDING AND TO PROTECT ADJACENT IMPROVEMENTS AND PROPERTIES FROM AN INFLUX OF RUNOFF OR

3. SURPLUS OR WASTE MATERIAL AND/OR FILL OF EARTHEN MATERIAL SHALL NOT BE PLACED IN DRAINAGE WAYS.

4. ALL LOOSE PILES OF SOIL, SILT, CLAY, SAND, DEBRIS OR OTHER EARTHEN MATERIALS MUST BE PROTECTED IN A REASONABLE MANNER TO PREVENT THE DISCHARGE OF THESE MATERIALS TO WATERS OF THE STATE. THESE MATERIALS MUST BE REMOVED FROM THE SITE AT THE END OF EACH WORKING DAY.

5. IF NECESSARY, CONTRACTOR SHALL ENHANCE EROSION CONTROL MEASURES IN THE FIELD.

CONTRACTOR SHALL INSTALL SEDIMENT CONTROL DEVICES PRIOR TO CONSTRUCTION.

7. THE CONTRACTOR SHALL REMOVE ALL GRADING AND CONSTRUCTION DEBRIS AT THE END OF EACH WORKING DAY.

8. DEWATERING EFFLUENT SHALL BE TREATED PRIOR TO DISCHARGE BY MEANS OF DEWATERING STRUCTURES (e.g. STRAW BALE FILTER/SILT FENCE PIT, GRAVEL FILTER, ETC.).

DUST CONTROL NOTES:

1. CONTRACTOR IS RESPONSIBLE FOR PREVENTING CONTROLLABLE FUGITIVE DUST FROM THE PROJECT'S DISTURBED AREAS TO BECOME AIRBORNE ON A 7-DAY/WEEK, 24-HOUR/DAY BASIS FROM COMMENCEMENT OF THE PROJECT TO FINAL COMPLETION.

2. REGULAR VACUUM OR SWEEPING OF PAVED SURFACES WHERE CONSTRUCTION IS OCCURRING WILL BE PERFORMED AT LEAST DAILY AND MORE OFTEN IF NECESSARY TO REMOVE DIRT OR WASTE RESULTING FROM THE CONSTRUCTION.

3. STOCKPILED EARTHEN MATERIALS SHALL BE REMOVED FROM THE SITE AT THE END OF EACH WORKING DAY.

4. ALL TRUCKS IMPORTING OR EXPORTING DIRT, ROCK OR OTHER FILL MATERIALS SHALL PREVENT SPILLAGE OR LOSS OF BULK MATERIAL FROM HOLES OR OTHER OPENINGS IN THE CARGO COMPARTMENT FLOOR, SIDES, AND/OR TAILGATE, ALL HAUL TRUCKS MUST BE COVERED WITH A TARP OR OTHER SUITABLE CLOSURE; OR BULK MATERIALS MUST CONTAIN ENOUGH MOISTURE AND/OR DUST SUPPRESSANT TO PREVENT FUGITIVE DUST EMISSIONS DURING TRANSPORT; OR LOAD ALL TRUCKS SUCH THAT THE FREEBOARD IS NOT LESS THAN SIX (6) INCHES.

5. ALL PROJECT RELATED VEHICLES SHALL PARK ON EXISTING PAVED SURFACES. CONTRACTOR SHALL MINIMIZE CONSTRUCTION RELATED VEHICLE AND EQUIPMENT EMISSIONS DURING CONSTRUCTION BY SHUTTING OFF EQUIPMENT AND VEHICLES NOT IN USE. IDLING OF DIESEL ENGINES SHALL BE KEPT AT A MINIMUM SO FAR AS PRACTICAL

ACCESS/TRAFFIC CONTROL NOTES:

1. PROVIDE AND MAINTAIN ALL NECESSARY TRAFFIC CONTROL, THROUGHOUT CONSTRUCTION, IN ACCORDANCE WITH APPLICABLE PARTS OF SSPWC SECTION 332 AND THE MANUAL ON UNIFORM TRAFFIC CONTROL DEVICES, (MUTCD, LATEST EDITION).

2. THE CONTRACTOR SHALL MAINTAIN TRAFFIC CONTROL IN STRICT ACCORDANCE WITH PLANS AND SPECIFICATIONS AT ALL TIMES. ROADS WITHIN THE PROJECT MAY HAVE LIMITED SIGHT DISTANCE.

3. STREETS SHALL REMAIN OPEN TO LOCAL TRAFFIC AND ONE-WAY TRAFFIC SHALL BE PROVIDED AT ALL TIMES.

4. RESIDENCES SHALL HAVE ACCESS TO/FROM DRIVEWAY AT ALL TIMES. CONTRACTOR SHALL PROVIDE COORDINATION FOR ACCESS (TRENCH PLATE, MOVE EQUIPMENT, ETC.) WITH RESIDENCES.

5. TRAFFIC DELAYS SHALL BE HELD TO 10 MINUTES OR LESS.

6. CONTRACTOR SHALL BECOME FAMILIAR WITH THE SITE AND ACCESS TO THE SITE PRIOR TO BID.

7. CONTRACTOR SHALL DETERMINE BEST METHODS FOR ACCESS WHEN OFF HAULING WASTE, DELIVERY OF MATERIALS, AND DAY TO DAY ACTIVITIES.

8. TRAFFIC CONTROL PLANS TO BE SUBMITTED TO CITY OF SPARKS FOR REVIEW. SUBMIT TRAFFIC CONTROL PLANS TO:

NAME: ASHLEY ELSON TEL: (775)353-2375

EMAIL: AELSON@CITYOFSPARKS.US OFFICE LOCATION: SPARKS CITY HALL, 431 PRATER WAY, SPARKS, NV 89431

9. THE HOURS OF WORK SHALL BE FROM 7:00 AM TO 7:00 PM MONDAY THROUGH FRIDAY; WEEKEND AND HOLIDAY WORK UPON APPROVAL BY CITY PROJECT COORDINATOR.

10. THE WORK OF SETTING UP AND TEARING DOWN TRAFFIC CONTROL DEVICES AS REQUIRED SHALL BE COMPLETED EACH DAY WITHIN THE HOURS SPECIFIED ON THE PERMIT AND/OR ON THE APPROVED TRAFFIC CONTROL PLAN. ALL TRAFFIC CONTROL DEVICES SHALL BE COMPLETELY REMOVED FROM THE ROADWAY AT THE END OF EACH WORKING DAY.

NDOT REQUIREMENTS:

1. CONTRACTOR SHALL BE RESPONSIBLE FOR OBTAINING A TEMPORARY OCCUPANCY PERMIT FROM NDOT.

2. CONTRACTOR SHALL BE BOUND TO ALL NDOT PERMIT REQUIREMENTS.

3. THE CONTRACTOR IS REQUIRED TO SUBMIT A TRAFFIC CONTROL PLAN TO NDOT FOR APPROVAL PRIOR TO CONSTRUCTION WITHIN ALL NDOT ROADWAYS. THE TRAFFIC CONTROL PLAN MUST CONFORM TO ALL REQUIREMENTS ESTABLISHED BY NDOT.

4. THE APPROVED PLANS, PERMITS, AND INSPECTION RECORD MUST BE ON THE JOB AT ALL TIMES.

5. CONTRACTOR TO NOTIFY NDOT PERMIT OFFICE <u>TWO (2) WORKING DAYS</u> PRIOR TO COMMENCING WORK WITHIN NDOT R/W.

BYPASS PUMPING NOTES

1. CONTRACTOR SHALL BE RESPONSIBLE TO COORDINATE ALL CONSTRUCTION ACTIVITIES TO PROPERLY CONTROL AND DISPOSE OF RAW SEWAGE FROM EACH CONSTRUCTION SITE IN ACCORDANCE WITH APPLICABLE REGULATIONS AND LAWS FOR THE DURATION OF THE PROJECT. CONTRACTOR SHALL SUPPLY ALL NECESSARY EQUIPMENT AND WORK WITH SPARES TO MEET THIS REQUIREMENT.

2. CONTRACTOR TO PROVIDE TEMPORARY CONNECTION TO NEW MAIN OR BYPASS PUMPING TO PROVIDE UNINTERRUPTED FLOW TO THE SYSTEM NOT BEING WORKED ON. SEWER TO BE COUPLED TO EXISTING AND FLOW REESTABLISHED AT END OF EACH DAY.

3. REFER TO SPECIFICATION SECTION SECTION 306A - BYPASS PUMPING FOR ADDITIONAL REQUIREMENTS.

IN-SITU CONSTRUCTION GENERAL NOTES

1. IDENTIFIED EXISTING SEWER MAINS AND LATERALS SHALL RECEIVE CURED-IN-PLACE PIPE (CIPP). REFER TO SPECIFICATION SECTION 306E FOR INFORMATION.

2. CONTRACTOR TO PRE CLEAN AND VIDEO EXISTING CONDITIONS PRIOR TO CONSTRUCTION.

3. ALL CIPP SHALL HAVE A COLOR TELEVISION INSPECTION PRIOR TO ACCEPTANCE BY OWNER.

4. NOTE THAT MAIN AND LATERAL SIZES ARE SHOWN BASED ON BEST AVAILABLE INFORMATION. CONTRACTOR SHALL CONFIRM AND NOTIFY THE ENGINEER OF ANY SIGNIFICANT ALTERATIONS PRIOR TO PROCURING MATERIALS.

SEWER LATERAL NOTES

1. CONTRACTOR SHALL VERIFY ALL LATERAL LOCATIONS DURING CONSTRUCTION. CONTRACTOR SHALL VERIFY THAT ALL SANITARY SEWER LATERALS ARE ACTIVE OR INACTIVE PRIOR TO THE INSTALLATION OF CIPP LINING.

2. IF NO INDICATIONS OF FLOW ARE PRESENT THEN A PUSH TYPE CAMERA WITH VIDEO TAPE INSPECTION CAPABILITY, DYE TESTING, OR SURFACE LOCATE CAPABILITY SHALL BE USED TO CONFIRM IF LATERAL IS ACTIVE OR INACTIVE. EACH LATERAL SHALL BE CONSIDERED ACTIVE UNLESS IT CAN BE POSITIVELY DETERMINED TO BE INACTIVE. THE CONTRACTOR SHALL MAINTAIN A LOG OF ALL INACTIVE AND ACTIVE LATERALS PRIOR TO RECONNECTION OR ABANDONMENT PER THE SPECIFICATIONS.

3. CONTRACTOR SHALL CONFIRM EACH BUILDING ON EACH STREET HAS AN ACTIVE SANITARY SEWER LATERAL THAT IS CONNECTED TO A SEWER MAIN. IF NO LATERAL CAN BE FOUND, CONTRACTOR SHALL EMPLOY THE USE OF A LOCATOR DOWN AN EXISTING PLUMBING VENT, CLEANOUT OR BUILDING FIXTURE WITHIN THE BUILDING TO LOCATE AND PROVIDE CONNECTION TO THE SEWER MAIN.

4. CONTRACTOR SHALL VERIFY LATERAL SIZES (2", 3", 4" OR 6") PRIOR TO LATERAL REINSTATEMENT AND MATCH EXISTING.

EXISTING LEGEND:

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— EX W ——— WATERLINE SANITARY SEWER — EX SS ——— — EX SD ——— STORM DRAIN ELECTRICAL —— FX F ———— OVER HEAD POWER — EX OHP----— EX TELE ——— TELEPHONE/COMM LINE — EX G ——— GAS MAIN/LATERAL ABANDONED UTILITY ------ ABANDONED -----PROPERTY LINE

PROPOSED LEGEND:

108+00 CIPP SANITARY SEWER MAIN/CONSTRUCTION CONTROL LINE

EXISTING MANHOLE

EXISTING PLUG-IN-PLACE

ABBREVIATIONS

ASBESTOS CEMENT PIPE CURED-IN-PLACE PIPE

INVERT ELEVATION MANUAL ON UNIFORM TRAFFIC CONTROL DEVICES

NDOT NEVADA DEPARTMENT OF TRANSPORTATION PVC POLYVINYL CHLORIDE


REINFORCED CONCRETE PIPE

SSPWC STANDARD SPECIFICATIONS FOR PUBLIC WORKS CONSTRUCTION

SSL SANITARY SEWER LINE SSMH SANITARY SEWER MANHOLE

SSN SANITARY SEWER NUMBER STA STATION UNK UNKNOWN

VITRIFIED CLAY PIPE

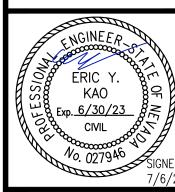

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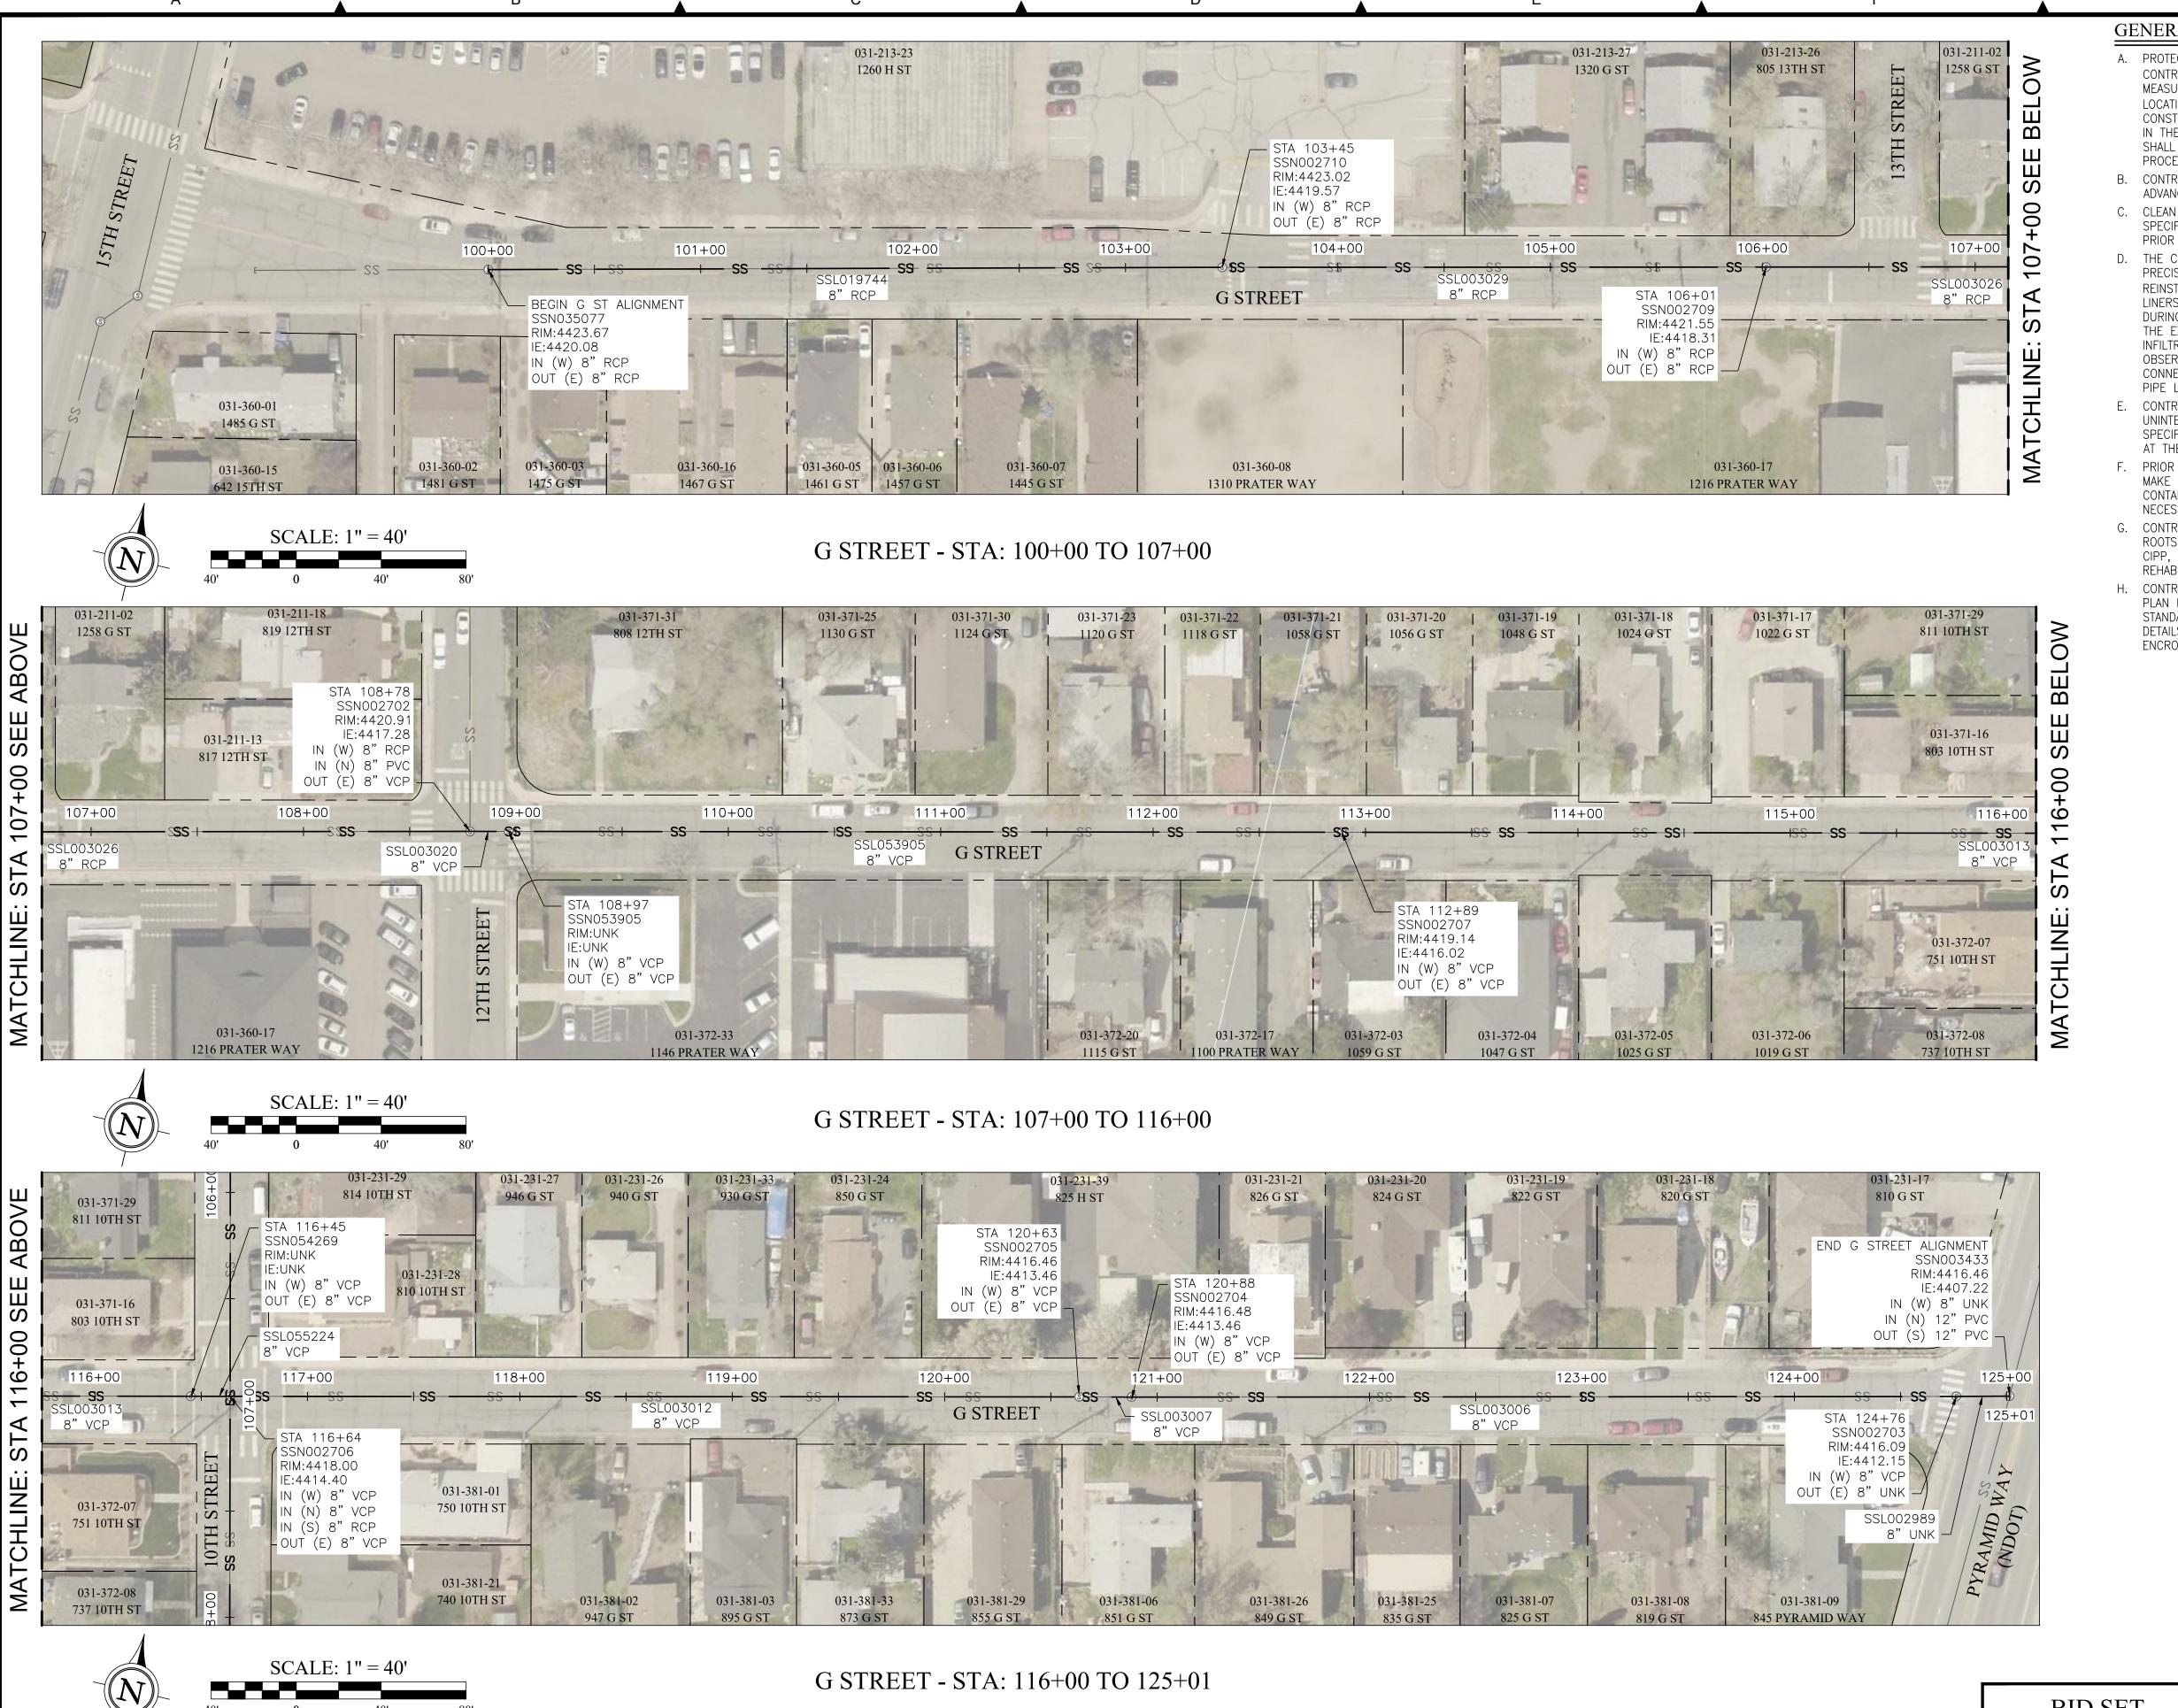
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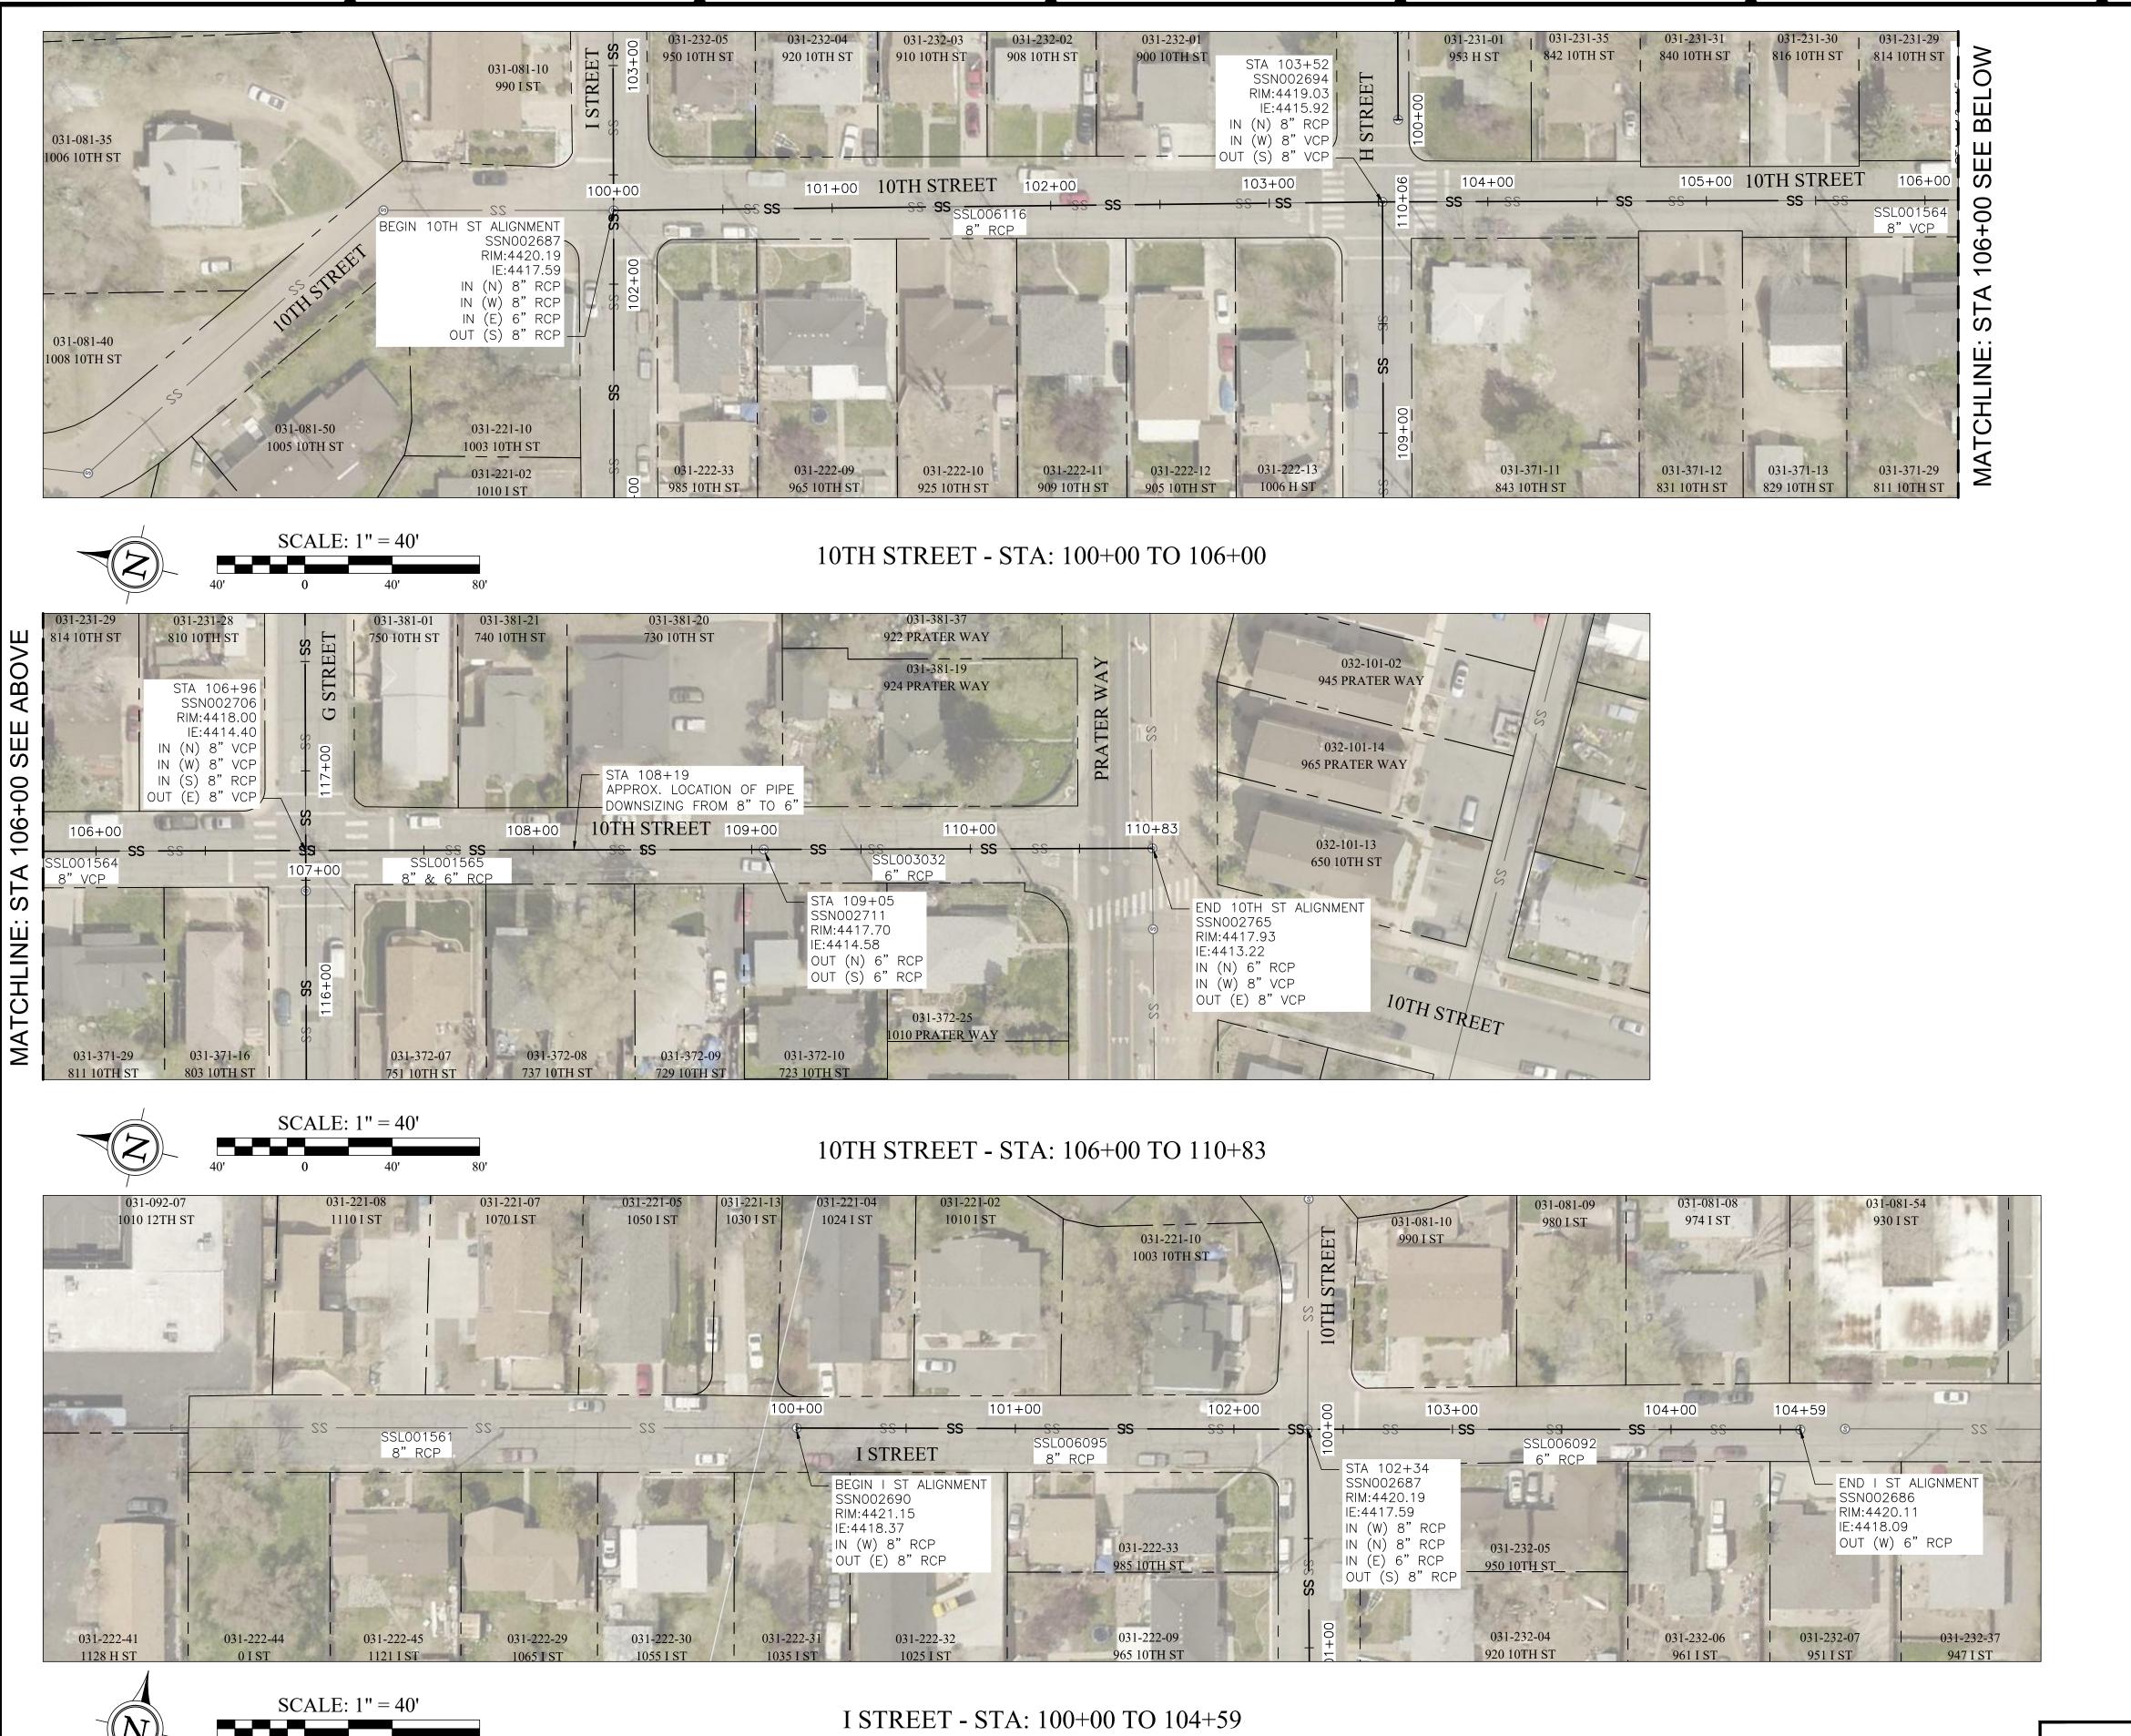
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- B. CONTRACTOR SHALL NOTIFY OWNER AND ENGINEER 48 HOURS IN ADVANCE OF ANY SECTION REPLACEMENT.
- C. CLEAN AND REHABILITATE EXISTING SEWER MAIN WITH CIPP PER SPECIFICATION SECTIONS 306B & 306E. CONFIRM INNER DIAMETER PRIOR TO PROCURING MATERIALS.
- D. THE CONTRACTOR SHALL VERIFY THE SIZE, SIGN OF ACTIVITY, AND PRECISE LOCATION OF EACH LATERAL PRIOR TO LATERAL REINSTATEMENT AND/OR INSTALLING SERVICE LATERAL CONNECTION LINERS. SERVICE LATERAL CONNECTION LINERS WILL BE DETERMINED DURING THE TIME OF CONSTRUCTION BASED ON THE CONDITION OF THE EXISTING LATERAL TO MAIN CONNECTION. IF GROUNDWATER INFILTRATION, TREE ROOT INTRUSION, OR ANY OTHER DAMAGE IS OBSERVED, CONTRACTOR SHALL INSTALL THE SERVICE LATERAL CONNECTION IN ACCORDANCE WITH SECTION 306E-CURED-IN-PLACE PIPE LINING SUBSECTION 2.7 - SERVICE LATERAL CONNECTIONS.
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- F. PRIOR TO PERFORMING POINT REPAIRS, IF ANY, CONTRACTOR SHALL MAKE OWN DETERMINATION AS TO WHETHER EXISTING PIPE CONTAINS ASBESTOS, AND USE APPROPRIATE ABATEMENT AS NECESSARY.
- G. CONTRACTOR SHALL BE RESPONSIBLE TO IDENTIFY AND TRIM ALL ROOTS WHICH HAVE THE POTENTIAL TO REFLECT THROUGH THE CIPP, INCLUDING IN THE PORTIONS OF LATERALS WHICH ARE TO BE REHABILITATED.
- H. CONTRACTOR SHALL PROVIDE AND IMPLEMENT A TRAFFIC CONTROL PLAN PER THE SPECIFICATIONS, MUTCD LATEST EDITION, NDOT STANDARD SPECIFICATIONS FOR ROAD AND BRIDGE CONSTRUCTION, DETAILS ON SHEETS D1 & D2, AND EXCAVATION AND ENCROACHMENT PERMIT OR NDOT TEMPORARY OCCUPANCY PERMIT.

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CITY OF SPARKS SEWER CIPP LINING

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 SCALE:
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 VADA 89511
 DRAWN:
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 5) 851-4788
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FAX: (775) 851-0766
FARRWESTENGINEERING.CON

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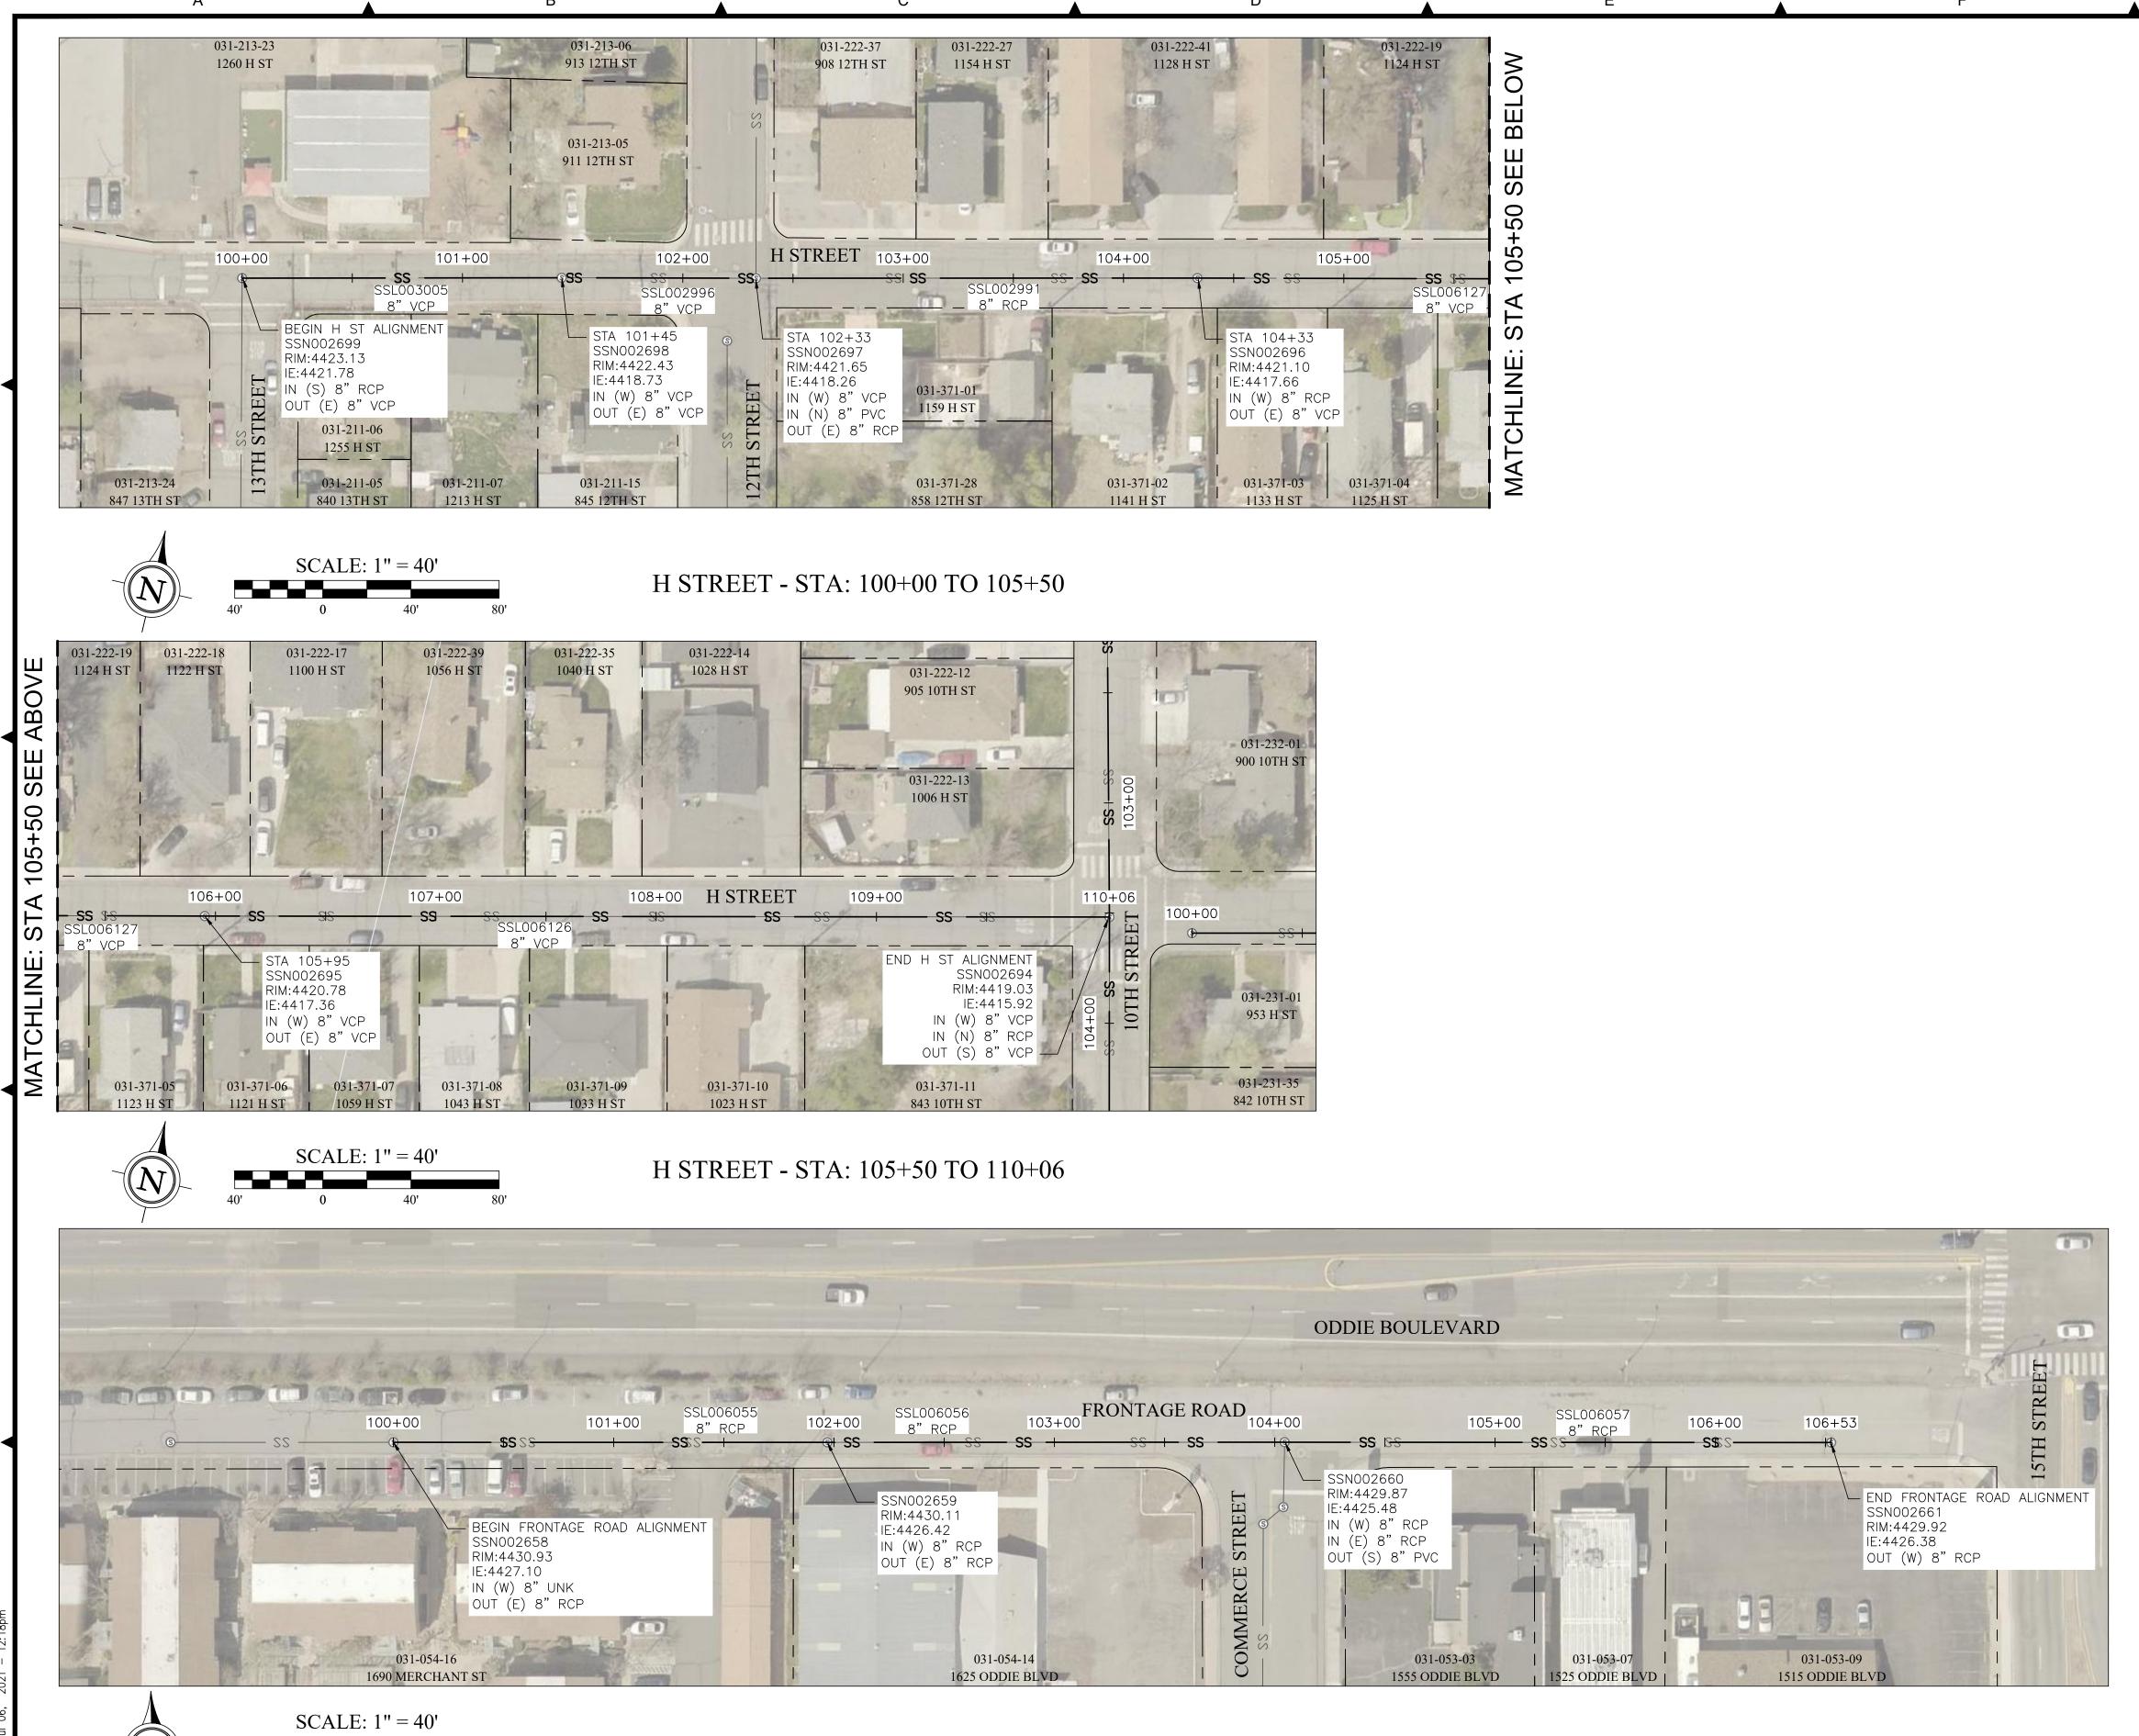
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CITY OF SPARKS

FARY SEWER CIPP LINING - FISOMETH ST & I ST

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- H. CONTRACTOR SHALL PROVIDE AND IMPLEMENT A TRAFFIC CONTROL PLAN PER THE SPECIFICATIONS, MUTCD LATEST EDITION, NDOT STANDARD SPECIFICATIONS FOR ROAD AND BRIDGE CONSTRUCTION, DETAILS ON SHEETS D1 & D2, AND EXCAVATION AND ENCROACHMENT PERMIT OR NDOT TEMPORARY OCCUPANCY PERMIT.

REVISION DESCRIPTION BY APP DATE

SCALE: JULY 2021

SCALE: SEE SHEET

DESIGNED: EYK

BS DRAWN: EYK

CHECKED: KK

A CHECKED: KK

ENGINEERING

5510 LONGLEY LANE
RENO, NEVADA 89511
PHONE: (775) 851-4788
FAX: (775) 851-0766
FARRWESTENGINEERING.COM

ERIC Y. KAO 897 CIVIL Wo. 027946 SIGNED: 7/6/21

7/6/2 NEVADA

SEWER CIPP LINING - FISCAL 20 H ST & FRONTAGE RD

H ST

SHEET NUMBER

C3
__6__ OF __11__


031-353-08


1640 PRATER WAY




1658 PRATER WAY

16TH STREET ALLEY - STA: 100+00 TO 104+30

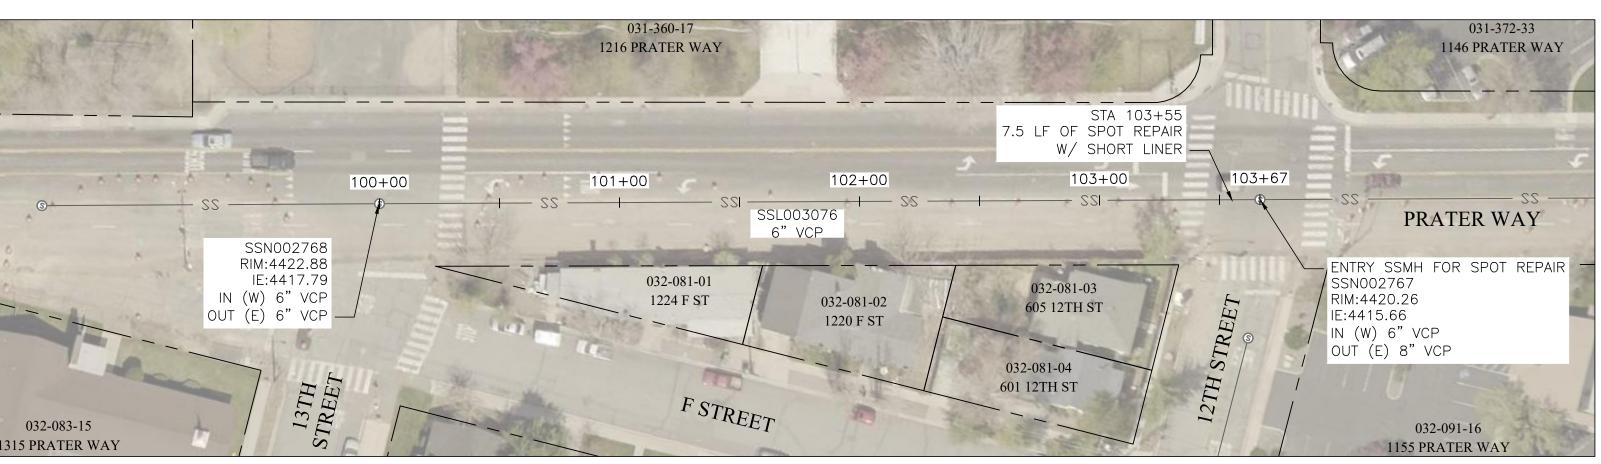

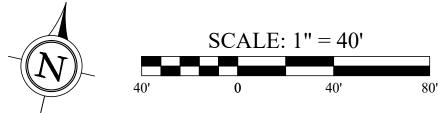

PRATER WAY SPOT REPAIR 1 - STA: 100+00 TO 103+67

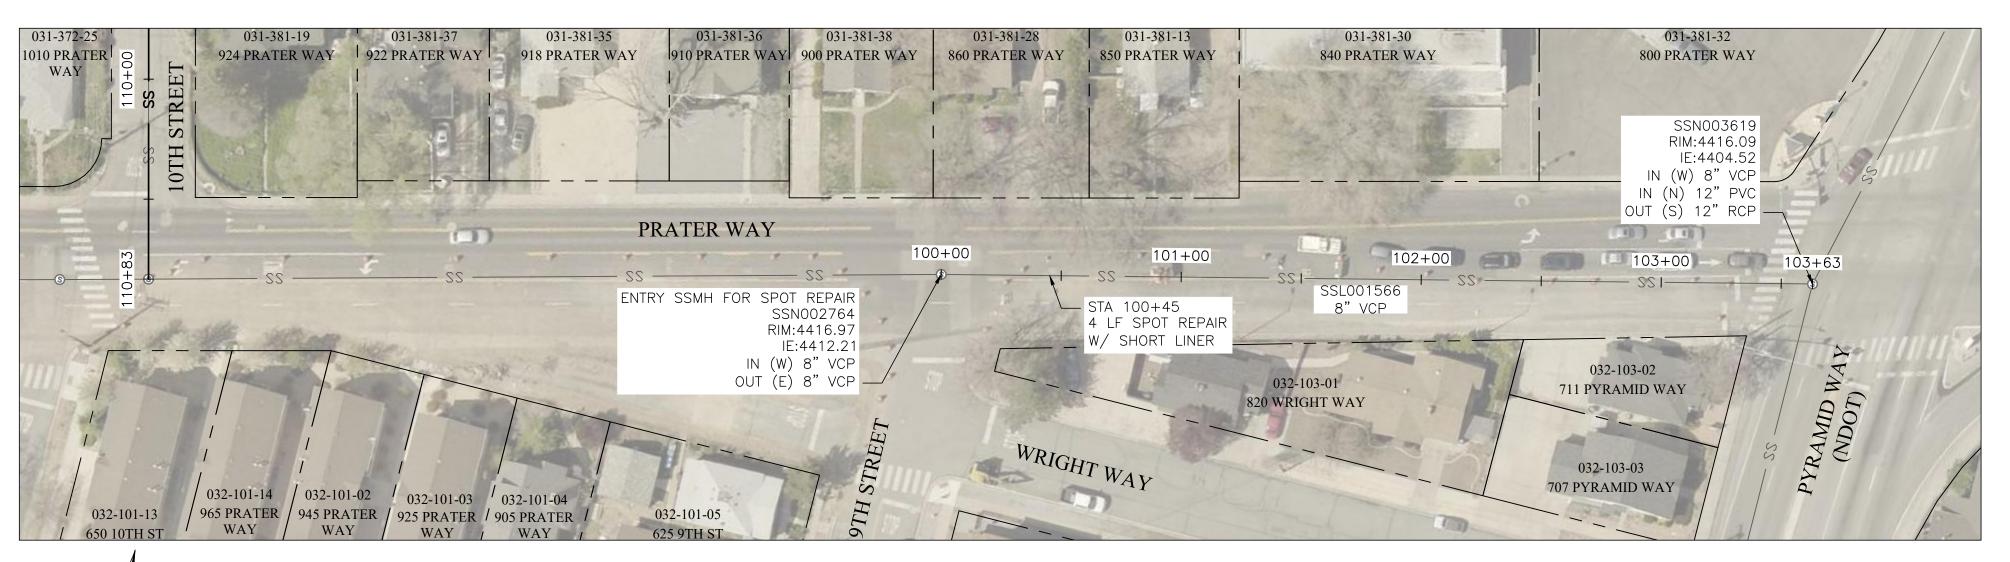

PRATER WAY SPOT REPAIR 2 - STA: 100+00 TO 103+63

GENERAL NOTES:

- A. PROTECTION OF ALL UTILITIES IS THE RESPONSIBILITY OF THE CONTRACTOR. IT IS THE CONTRACTOR'S RESPONSIBILITY TO VIDEO, MEASURE THE DISTANCE FROM INSIDE MANHOLE, AND VERIFY THE LOCATIONS AND/OR ELEVATIONS PRIOR TO BIDDING AND CONSTRUCTION. DISCREPANCIES BETWEEN THE EXISTING CONDITIONS IN THE FIELD AND THE INFORMATION SHOWN ON THESE DRAWINGS SHALL BE BROUGHT TO THE ATTENTION OF THE ENGINEER BEFORE PROCEEDING WITH CONSTRUCTION.
- B. CONTRACTOR SHALL NOTIFY OWNER AND ENGINEER 48 HOURS IN ADVANCE OF ANY SECTION REPLACEMENT.
- C. CLEAN AND REHABILITATE EXISTING SEWER MAIN WITH CIPP PER SPECIFICATION SECTIONS 306B & 306E. CONFIRM INNER DIAMETER PRIOR TO PROCURING MATERIALS.
- D. THE CONTRACTOR SHALL VERIFY THE SIZE, SIGN OF ACTIVITY, AND PRECISE LOCATION OF EACH LATERAL PRIOR TO LATERAL REINSTATEMENT AND/OR INSTALLING SERVICE LATERAL CONNECTION LINERS. SERVICE LATERAL CONNECTION LINERS WILL BE DETERMINED DURING THE TIME OF CONSTRUCTION BASED ON THE CONDITION OF THE EXISTING LATERAL TO MAIN CONNECTION. IF GROUNDWATER INFILTRATION, TREE ROOT INTRUSION, OR ANY OTHER DAMAGE IS OBSERVED, CONTRACTOR SHALL INSTALL THE SERVICE LATERAL CONNECTION IN ACCORDANCE WITH SECTION 306E-CURED-IN-PLACE PIPE LINING SUBSECTION 2.7 - SERVICE LATERAL CONNECTIONS.
- CONTRACTOR TO PROVIDE BYPASS PUMPING TO PROVIDE UNINTERRUPTED FLOW TO THE SYSTEM NOT BEING WORKED ON PER SPECIFICATION SECTION 306A. SEWER FLOW TO BE RE-ESTABLISHED AT THE END OF EACH DAY.
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KAO Exp. <u>6/30/23</u>

CITY OF SPARKS
SEWER CIPP LINING

SHEET NUMBER

____7__ OF ___11__

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KAO Exp. <u>6/30/23</u> CIVIL


FISCAL 2022 ALE WAY

MEADOW

SHEET NUMBER


<u>8</u> OF <u>11</u>

CITY OF SPARKS SEWER CIPP LINING

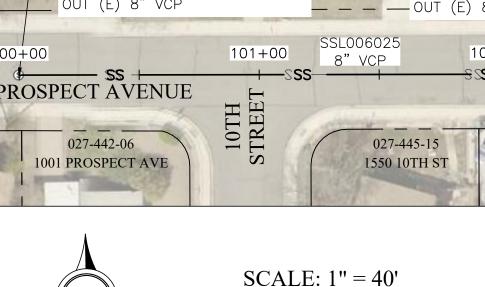

PROSPECT AVENUE - STA: 100+00 TO 107+84 & OXFORD AVENUE SPOT REPAIR - STA: 100+00 TO 101+33


1 PROSPECT AVE

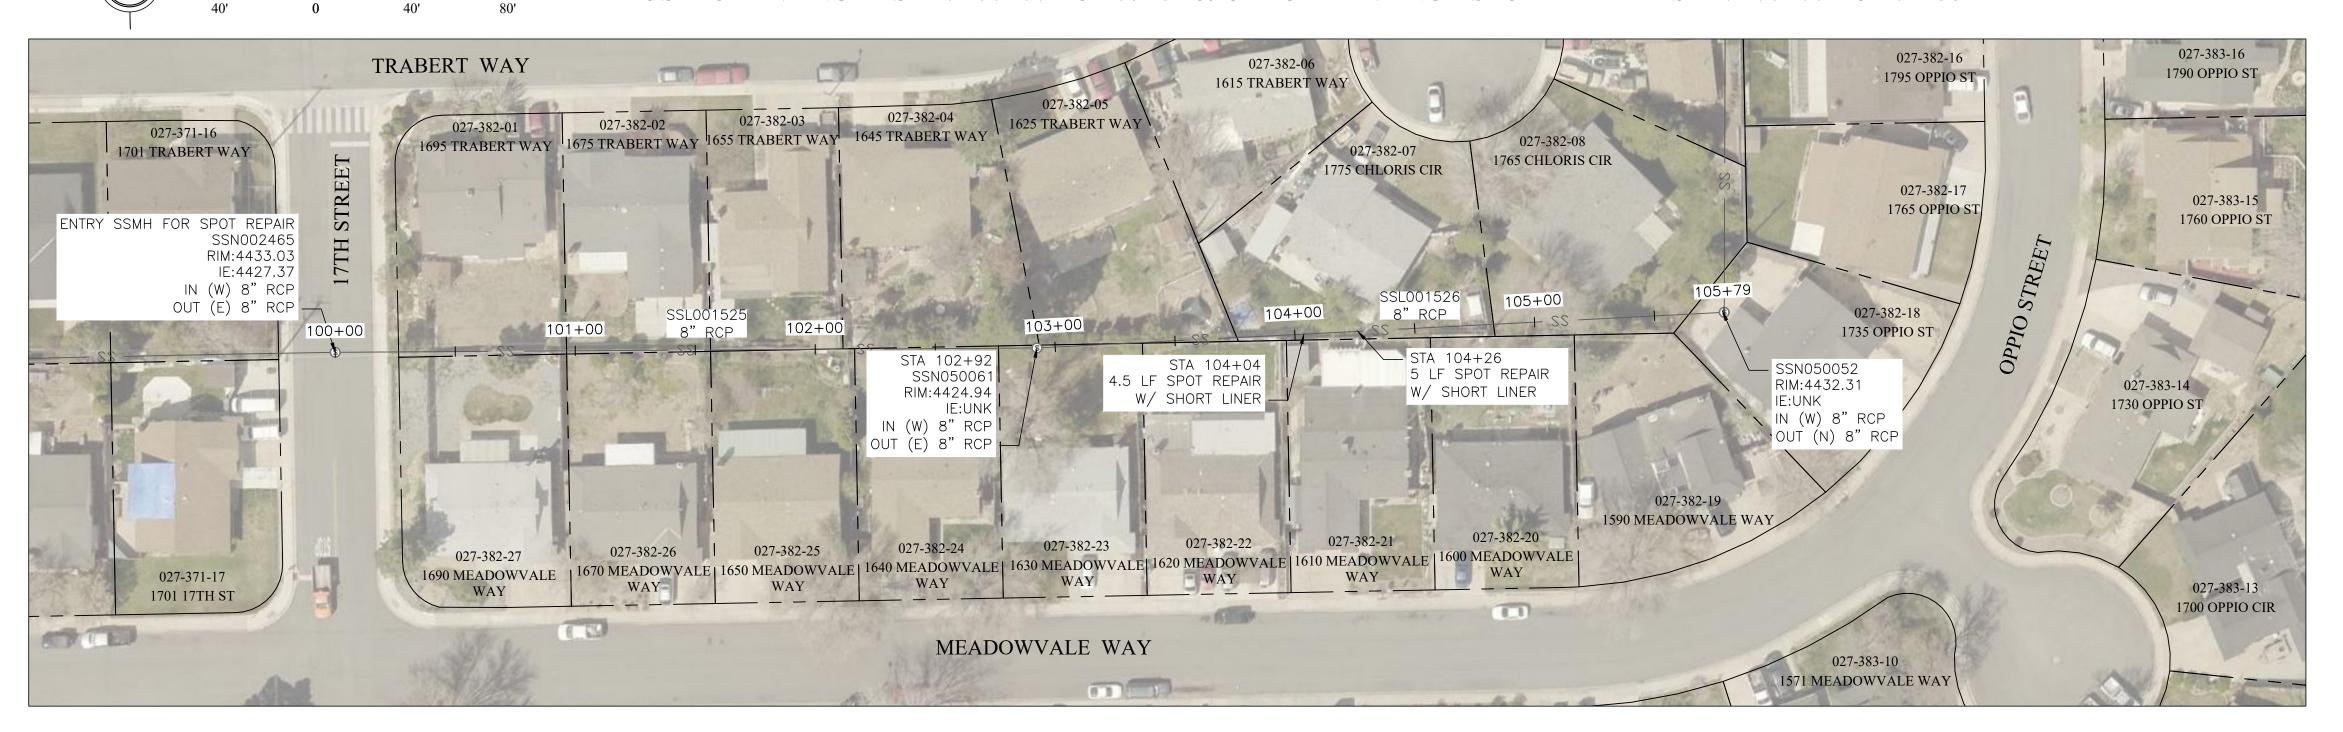





MEADOWVALE WAY SPOT REPAIRS - STA: 100+00 TO 105+79

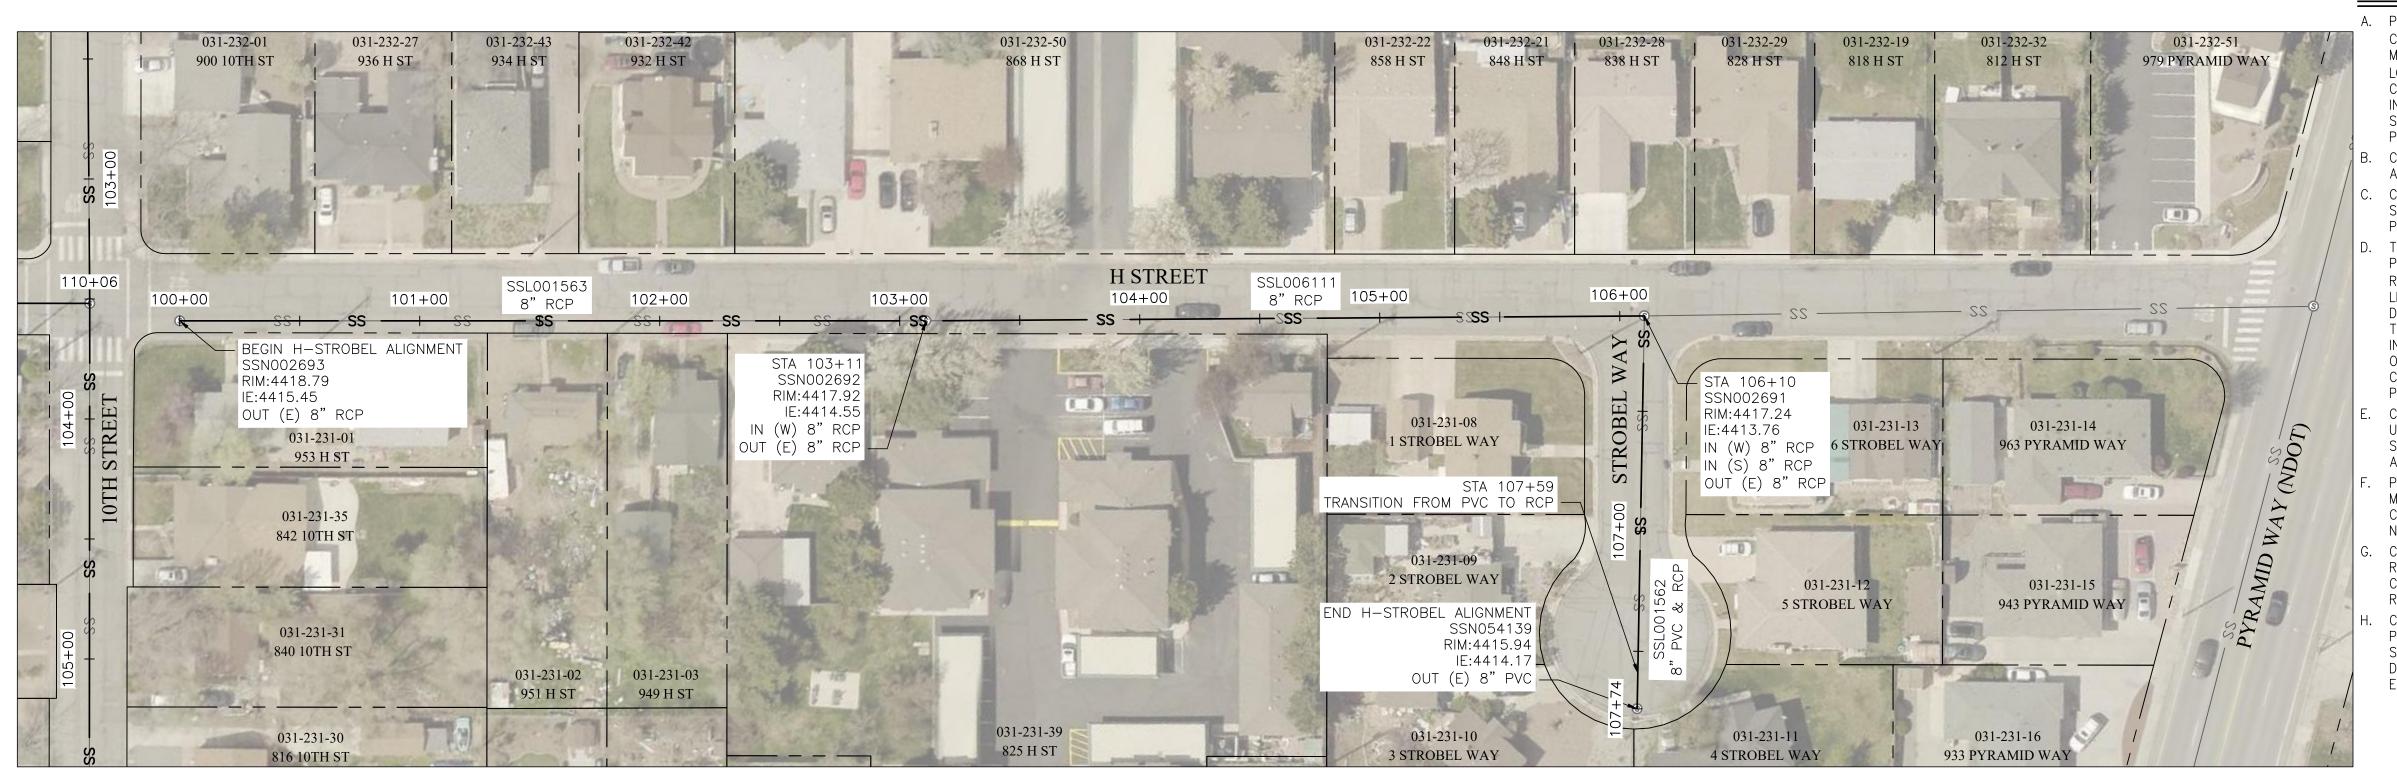

H STREET AND STROBEL - STA: 100+00 TO 107+74

GENERAL NOTES:

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CLEAN AND REHABILITATE EXISTING SEWER MAIN WITH CIPP PER SPECIFICATION SECTIONS 306B & 306E. CONFIRM INNER DIAMETER PRIOR TO PROCURING MATERIALS.


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CITY OF SPARKS
SANITARY SEWER CIPP LINING

SCALE: 1'' = 40'

LANE CLOSURE ON A TWO-LANE ROAD WITH LOW TRAFFIC VOLUMES


SCALE: NTS

- 1) ALL TRAFFIC CONTROL SHALL MEET OR EXCEED THE REQUIREMENTS AS OUTLINED IN THE MANUAL ON UNIFORM TRAFFIC CONTROL DEVICES (MUTCD) LATEST EDITION, NEVADA WORK ZONE TRAFFIC CONTROL HANDBOOK, NDOT STANDARD SPECIFICATIONS FOR ROAD AND BRIDGE CONSTRUCTION, & STANDARD SPECIFICATIONS FOR THE CONSTRUCTION OF PUBLIC WORKS, UNLESS NOTED OTHERWISE. IF DEVIATIONS FROM THE TYPICAL TRAFFIC CONTROL PLANS ARE NECESSARY, THE CONTRACTOR SHALL SUBMIT AN
- 2) PRIOR TO CONSTRUCTION ACTIVITY, THE CONTRACTOR SHALL SUBMIT A
- 3) ALL ADVANCED WARNING SIGNS SHALL BE PER THE TABLE IN DETAIL E ON THIS SHEET.
- 4) PORTABLE DELINEATORS SHALL BE A MINIMUM OF 36" HIGH AND PLACED APPROXIMATELY 25 FEET APART.
- LANE OF TRAFFIC AT ALL TIMES DURING CONSTRUCTION ACTIVITY. AFTER WORKING HOURS ALL TRAFFIC CONTROLS SHALL BE LIFTED, TRAFFIC BARRIERS REMOVED AND TRAFFIC FLOW RETURNED TO NORMAL.
- CONTROL OPERATIONS TO ENSURE PUBLIC SAFETY AND SHALL ASSIGN AN EMPLOYEE TO FULL TIME MAINTENANCE OF TRAFFIC CONTROL DEVICES.
- OWNER AND MAY BE REQUIRED TO BE ALTERED BY THE CONTRACTOR IF IT IS PERCEIVED THAT A DANGEROUS CONDITION MAY EXIST. THE CONTRACTOR SHALL PROACTIVELY MANAGE TRAFFIC CONTROL OPERATIONS & MAKE ADJUSTMENTS AS NECESSARY TO ENSURE PUBLIC SAFETY.

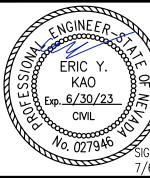TRAFFIC CONTROL NOTES

SCALE: NTS



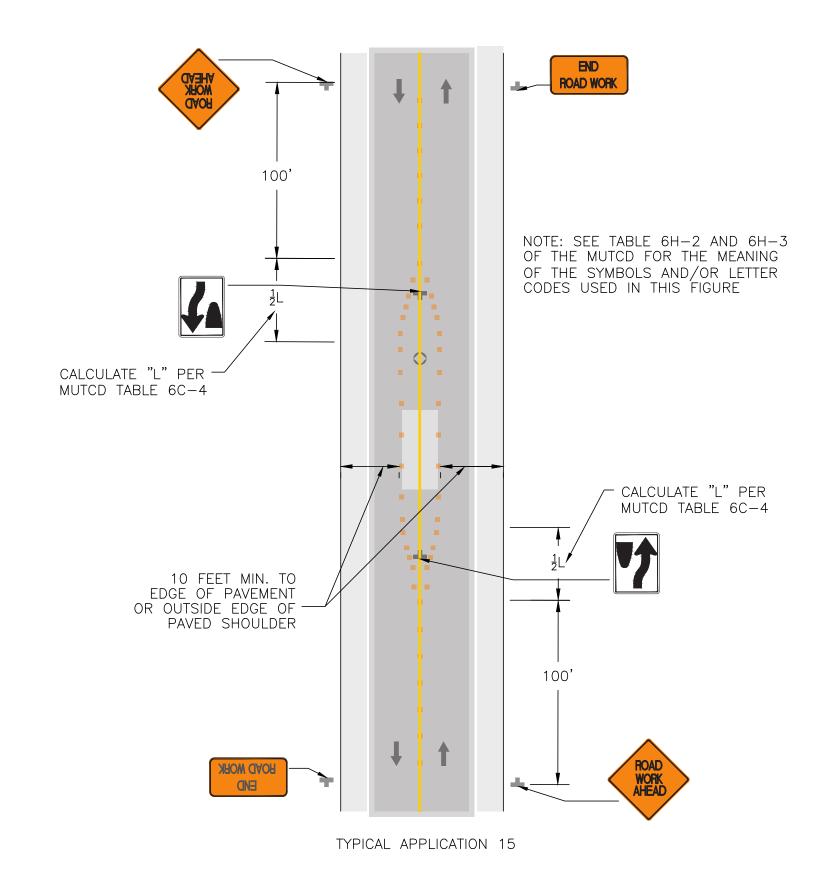

WORK IN THE CENTER OF A ROAD WITH LOW TRAFFIC VOLUMES

SCALE: NTS

TEMPORARY TRAFFIC CONTROL ZONE SIGN AND PLAQUE SIZES			
SIGN OR PLAQUE	SIGN DESIGNATION	MUTCD SECTION	SIGN SIZE
YIELD	R1-2	6F.06	36X36X36
TO ONCOMING TRAFFIC (PLAQUE)	R1-2aP	6F.06	36X30
KEEP RIGHT	R4-7	6F.06	24X30
TURN AND CURVE SIGNS	W1-1,2,3,4	6F.16	36X36
YIELD AHEAD	W3-2	6F.16	36X36
ADVISORY SPEED (PLAQUE)	W13-1P	6F.52	24X24
XX FEET (PLAQUE)	W16-2P	6F.16	24X18

6F.16


TEMPORARY SIGNS TABLE

W20-1


SCALE: NTS

|ROAD WORK (WITH|

DISTANCE)

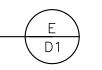


36X36

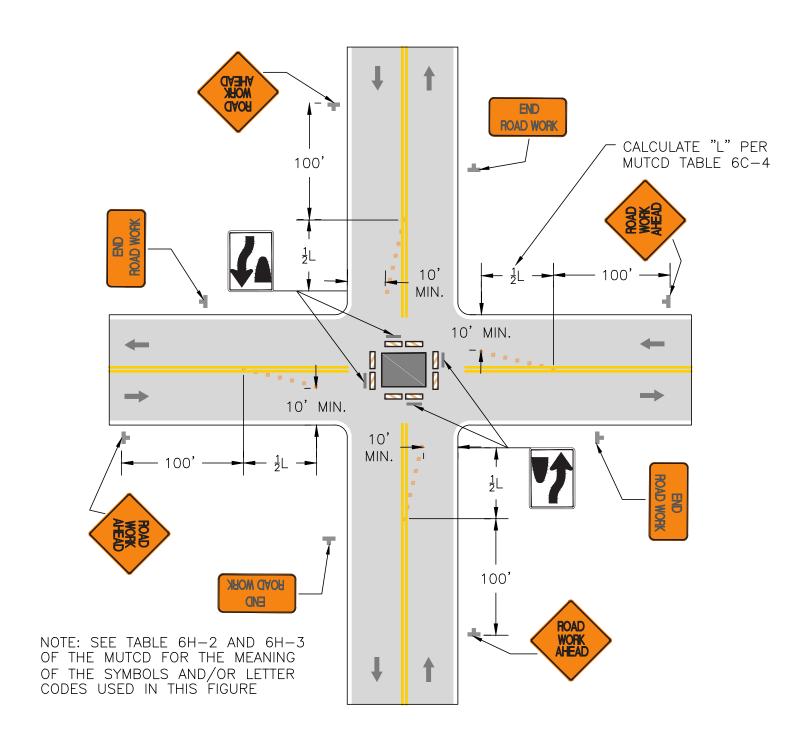

TYPICAL APPLICATION 26

CLOSURE IN THE CENTER OF AN INTERSECTION

SCALE: NTS

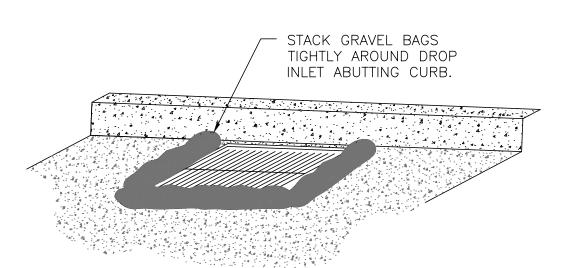

NOTES

1. INSTALL FILTER FABRIC BELOW GRATES, EXTEND FILTER FABRIC EIGHTEEN INCHES (18") BEYOND THE EDGE OF THE GRATE ALL DIRECTIONS.

DROP INLET PROTECTION DETAIL SCALE: NTS



KAO

CITY OF SPARKS ER CIPP LINING \mathbf{S}

SHEET NUMBER

<u>10</u> OF <u>11</u>

BID SET


AMENDED TRAFFIC CONTROL PLAN FOR APPROVAL.

TRAFFIC CONTROL PLAN FOR HANDLING TRAFFIC THROUGH THE PROJECT SITE TO THE OWNER FOR APPROVAL.

5) WHEN TWO-WAY TRAFFIC IS NOT POSSIBLE, CONTRACTOR SHALL MAINTAIN ONE

6) CONTRACTOR SHALL MANAGE AND BE RESPONSIBLE FOR ALL TRAFFIC

7) ALL TRAFFIC CONTROL OPERATIONS ARE SUBJECT TO APPROVAL OF THE

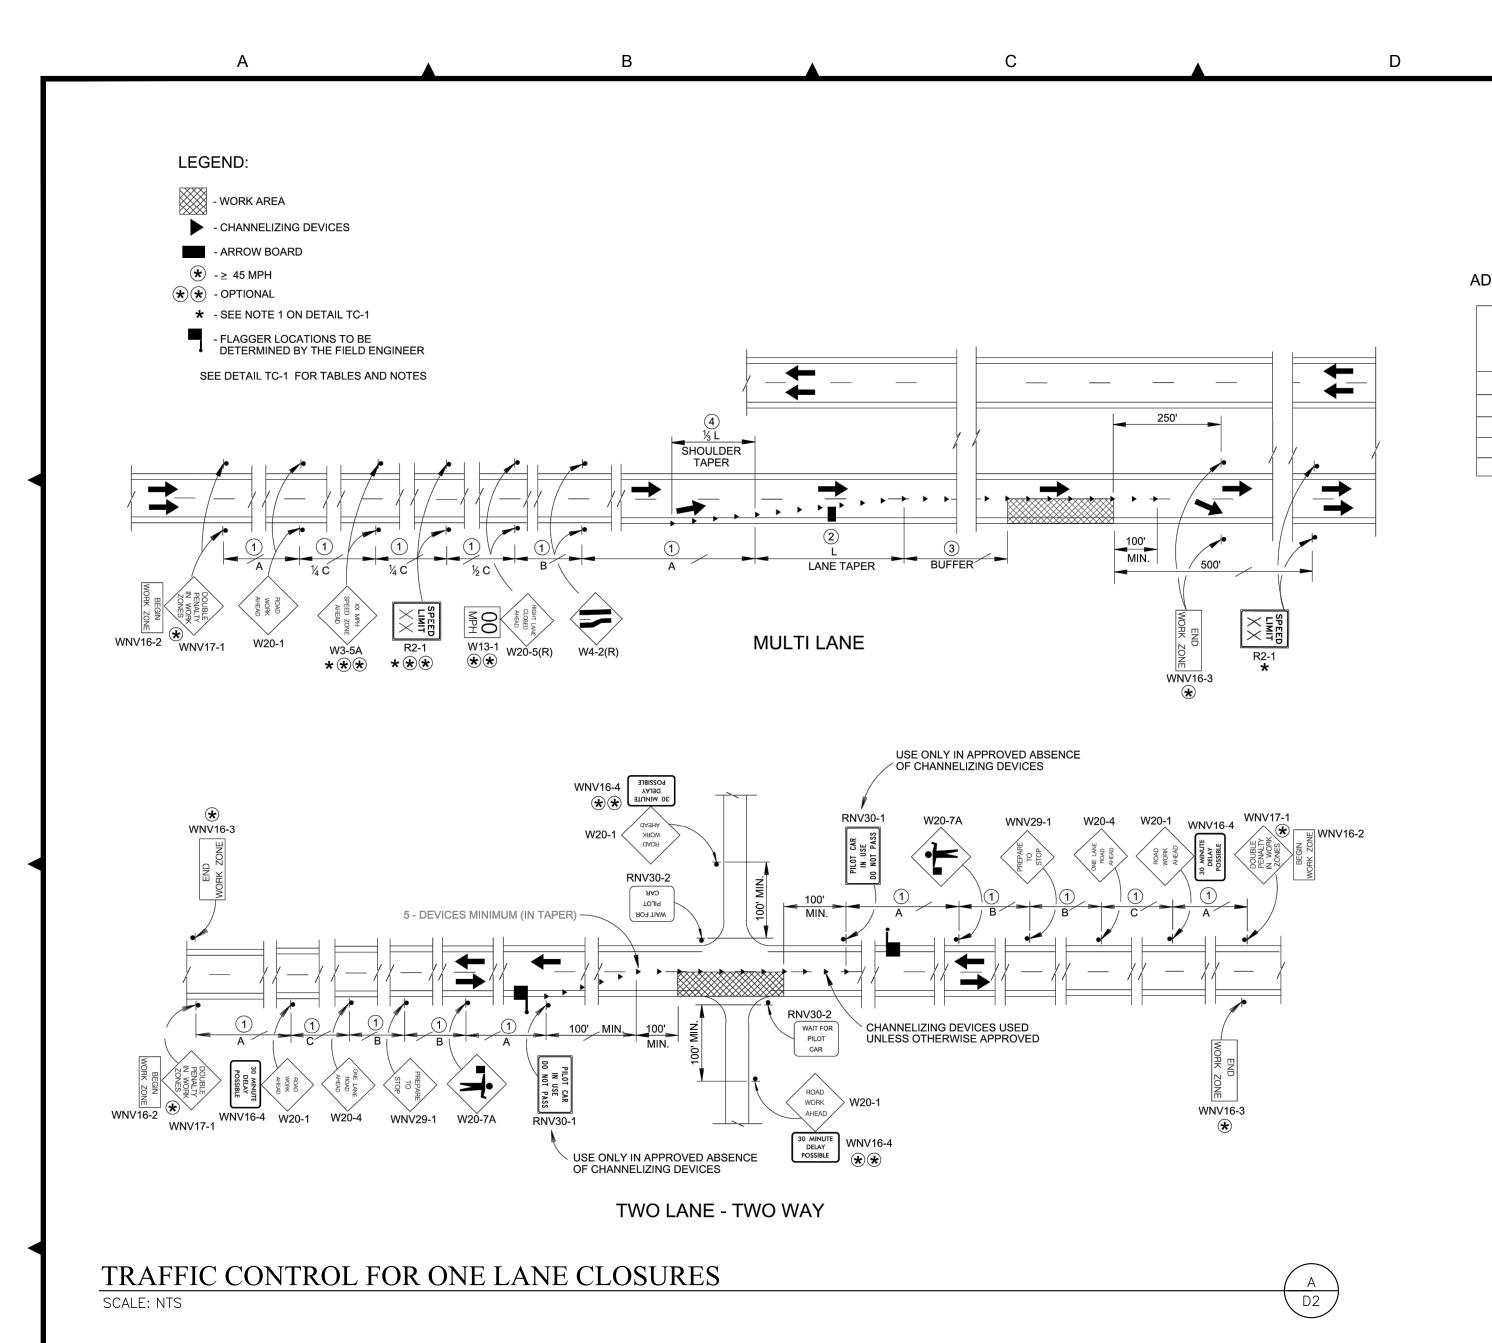

ADVANCE WARNING SIGN SPACING

SPEED MPH		DISTANCE BETWEEN SIGNS FT.	
	Α	В	С
0 - 20	200	200	200
25 - 30	300	300	300
35 - 40	400	400	400
45 - 50	600	600	600
55 - 80	1000	1600	2640

3

BUFFER LENGTH

LENGTH

115

155

200

250

305

360

425

495

570

645

730

820

920

FT.

SPEED MPH

20

25

30

35

40

45

50

55

60

65

70

75

80

TAPER LENGTH AND CHANNELIZING DEVICE SPACING

SPEED MPH	LENGTH FOR MERGING TAPER (L) LANE WIDTH		TAPER AND CHANNELIZATION DEVICE SPACING	
	10 FT.	11 FT.	12 FT.	FT.
20	80	80	80	20
25	125	125	125	25
30	150	180	180	30
35	210	245	245	35
40	280	320	320	40
45	450	495	540	45
50	500	550	600	50
55	550	605	660	55 *
60	600	660	720	60 *
65	650	715	780	65 ★
70	700	770	840	70 *
75	750	825	900	75 *
80	800	880	960	80 🛨
				l

★ ON RURAL INTERSTATE HIGHWAYS WHERE THE SPEED LIMIT IS 55 MPH OR GREATER, THE CHANNELIZATION DEVICE SPACING (EXCEPT FOR TAPERS) MAY BE INCREASED TO 80-FEET. WHEN INCREASED DEVICE SPACING IS USED, 3 DRUMS WILL BE PLACED DIAGONALLY AT 0.5-MILE INCREMENTS TO INDICATE THE LANE IS CLOSED

NOTES:

- 1. Projects with an existing speed limit greater than 55 mph may be temporarily reduced by 10 mph or to 55 mph, whichever is lower, with the concurrence from the Chief Traffic Operations Engineer. Any temporary reductions to a speed lower than 55 MPH may be reduced with concurrence from the Chief Traffic Operations Engineer and a recommendation forwarded by Traffic Operations to the Director for approval.
 - 2. The W1-3 signs shall be used when the recommended speed on a curve is 30 mph or less, the W1-4 signs shall be used when the recommended speed is 35 mph or
 - 3. The W6-3 and R4-1 signs shall be installed alternately at 0.5-mile intervals
 - 4. All regulatory signs (R series) shall be black on retroreflective white.

when the lengths of crossovers exceed 0.5-mile.

- 5. All warning signs (W series) shall be black on retroreflective orange.
- 6. Warning signs shall be a minimum of 3' x 3' for speeds of 45 mph or less,
- R2-1 shall be 3' x 4". 7. Warning signs shall be a minimum of 4' x 4' for speeds of 50 mph or greater,
- R2-1 shall be 4' x 5'. 8. All device spacing shall be designed based on work zone speed.

TYPICAL APPLICATIONS:

NDOT STANDARD DETAILS TC-2 THRU TC-22 INCLUDE A VARIETY OF TRAFFIC CONTROL METHODS, BUT DO NOT INCLUDE A LAYOUT FOR EVERY CONCEIVABLE WORK SITUATION, TYPICAL APPLICATIONS SHOULD BE ALTERED WHEN NECESSARY TO FIT THE CONDITIONS OF A PARTICULAR TEMPORARY TRAFFIC CONTROL ZONE. FOR ADDITIONAL INFORMATION REFER TO THE LATEST EDITION OF THE MANUAL ON UNIFORM TRAFFIC CONTROL DEVICES (MUTCD) AND REVISIONS.

ADVANCE WARNING ARROW PANEL

TYPE	MINIMUM SIZE INCHES	POSTED SPEED
Α	48 x 24	30 MPH OR LESS
В	60 x 30	35 MPH TO 50 MPH
С	96 x 48	55 MPH OR MORE

L = WS 2 ≤ 40 MPH > 45 MPH L = WS

S = SPEED (MPH) L = TAPER LENGTH (FT.) W = WIDTH OF LATERAL SHIFT (FT.)

SHIFTING TAPER = 1/2 L

SHOULDER TAPER = 1/3 L

TRAFFIC CONTROL NOTES

SCALE: NTS

SHEET NUMBER

__11__ OF __11_